



CALL NO. 114

CONTRACT ID. 194218

HARDIN COUNTY

FED/STATE PROJECT NUMBER HSIP 0311 (042)

DESCRIPTION N DIXIE HIGHWAY (US 31W)

WORK TYPE GRADE & DRAIN WITH ASPHALT SURFACE

PRIMARY COMPLETION DATE 11/30/2019

LETTING DATE: July 26,2019

Sealed Bids will be received electronically through the Bid Express bidding service until 10:00 AM EASTERN DAYLIGHT TIME July 26,2019. Bids will be publicly announced at 10:00 AM EASTERN DAYLIGHT TIME.

NO PLANS ASSOCIATED WITH THIS PROJECT.

DBE CERTIFICATION REQUIRED - 4.50%

REQUIRED BID PROPOSAL GUARANTY: Not less than 5% of the total bid.

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PART I
SCOPE OF WORK

ADMINISTRATIVE DISTRICT - 04

CONTRACT ID - 194218

HSIP 0311 (042)

COUNTY - HARDIN

PCN - 04047031W1901

HSIP 0311 (042)

N DIXIE HIGHWAY (US 31W) (MP 22.099) INTERSECTION AND CORRIDOR IMPROVEMENTS TO REDUCE CONFLICT POINTS AND ENHANCE SAFETY AND CAPACITY ALONG US 31W FROM FIRST STREET TO KY 1500 (MP 26.251), A DISTANCE OF 04.15 MILES.GRADE & DRAIN WITH ASPHALT SURFACE SYP NO. 04-09008.40.
GEOGRAPHIC COORDINATES LATITUDE 37:47:32.79 LONGITUDE -85:54:49.76

COMPLETION DATE(S):

COMPLETED BY 11/30/2019

APPLIES TO ENTIRE PROJECT

CONTRACT NOTES

PROPOSAL ADDENDA

All addenda to this proposal must be applied when calculating bid and certified in the bid packet submitted to the Kentucky Department of Highways. Failure to use the correct and most recent addenda may result in the bid being rejected.

BID SUBMITTAL

Bidder must use the Department's electronic bidding software. The Bidder must download the bid file located on the Bid Express website (www.bidx.com) to prepare a bid packet for submission to the Department. The bidder must submit electronically using Bid Express.

JOINT VENTURE BIDDING

Joint venture bidding is permissible. All companies in the joint venture must be prequalified in one of the work types in the Qualifications for Bidders for the project. The bidders must get a vendor ID for the joint venture from the Division of Construction Procurement and register the joint venture as a bidder on the project. Also, the joint venture must obtain a digital ID from Bid Express to submit a bid. A joint bid bond of 5% may be submitted for both companies or each company may submit a separate bond of 5%.

UNDERGROUND FACILITY DAMAGE PROTECTION

The contractor shall make every effort to protect underground facilities from damage as prescribed in the Underground Facility Damage Protection Act of 1994, Kentucky Revised Statute KRS 367.4901 to 367.4917. It is the contractor's responsibility to determine and take steps necessary to be in compliance with federal and state damage prevention directives. When prescribed in said directives, the contractor shall submit Excavation Locate Requests to the Kentucky Contact Center (KY811) via web ticket entry. The submission of this request does not relieve the contractor from the responsibility of contacting non-member facility owners, whom shall be contacted through their individual Protection Notification Center. Non-compliance with these directives can result in the enforcement of penalties.

REGISTRATION WITH THE SECRETARY OF STATE BY A FOREIGN ENTITY

Pursuant to KRS 176.085(1)(b), an agency, department, office, or political subdivision of the Commonwealth of Kentucky shall not award a state contract to a person that is a foreign entity required by [KRS 14A.9-010](#) to obtain a certificate of authority to transact business in the Commonwealth ("certificate") from the Secretary of State under [KRS 14A.9-030](#) unless the person produces the certificate within fourteen (14) days of the bid or proposal opening. If the foreign entity is not required to obtain a certificate as provided in [KRS 14A.9-010](#), the foreign entity should identify the applicable exception. Foreign entity is defined within [KRS 14A.1-070](#).

For all foreign entities required to obtain a certificate of authority to transact business in the Commonwealth, if a copy of the certificate is not received by the contracting agency within the time frame identified above, the foreign entity's solicitation response shall be deemed non-responsive or the awarded contract shall be cancelled.

Businesses can register with the Secretary of State at <https://secure.kentucky.gov/sos/ftbr/welcome.aspx>.

SPECIAL NOTE FOR PROJECT QUESTIONS DURING ADVERTISEMENT

Questions about projects during the advertisement should be submitted in writing to the Division of Construction Procurement. This may be done by fax (502) 564-7299 or email to kytc.projectquestions@ky.gov. The Department will attempt to answer all submitted questions. The Department reserves the right not to answer if the question is not pertinent or does not aid in clarifying the project intent.

The deadline for posting answers will be 3:00 pm Eastern Daylight Time, the day preceding the Letting. Questions may be submitted until this deadline with the understanding that the later a question is submitted, the less likely an answer will be able to be provided.

The questions and answers will be posted for each Letting under the heading "Questions & Answers" on the Construction Procurement website (www.transportation.ky.gov/contract). The answers provided shall be considered part of this Special Note and, in case of a discrepancy, will govern over all other bidding documents.

HARDWOOD REMOVAL RESTRICTIONS

The US Department of Agriculture has imposed a quarantine in Kentucky and several surrounding states, to prevent the spread of an invasive insect, the emerald ash borer. Hardwood cut in conjunction with the project may not be removed from the state. Chipping or burning on site is the preferred method of disposal.

INSTRUCTIONS FOR EXCESS MATERIAL SITES AND BORROW SITES

Identification of excess material sites and borrow sites shall be the responsibility of the Contractor. The Contractor shall be responsible for compliance with all applicable state and federal laws and may wish to consult with the US Fish and Wildlife Service to seek protection under Section 10 of the Endangered Species Act for these activities.

ACCESS TO RECORDS

The contractor, as defined in KRS 45A.030 (9) agrees that the contracting agency, the Finance and Administration Cabinet, the Auditor of Public Accounts, and the Legislative Research Commission, or their duly authorized representatives, shall have access to any books, documents, papers, records, or other evidence, which are directly pertinent to this contract for the purpose of financial audit or program review. Records and other prequalification information confidentially

disclosed as part of the bid process shall not be deemed as directly pertinent to the contract and shall be exempt from disclosure as provided in KRS 61.878(1)(c). The contractor also recognizes that any books, documents, papers, records, or other evidence, received during a financial audit or program review shall be subject to the Kentucky Open Records Act, KRS 61.870 to 61.884.

In the event of a dispute between the contractor and the contracting agency, Attorney General, or the Auditor of Public Accounts over documents that are eligible for production and review, the Finance and Administration Cabinet shall review the dispute and issue a determination, in accordance with Secretary's Order 11-004.

April 30, 2018

FEDERAL CONTRACT NOTES

The Kentucky Department of Highways, in accordance with the Regulations of the United States Department of Transportation 23 CFR 635.112 (h), hereby notifies all bidders that failure by a bidder to comply with all applicable sections of the current Kentucky Standard Specifications, including, but not limited to the following, may result in a bid not being considered responsive and thus not eligible to be considered for award:

102.02 Current Capacity Rating 102.10 Delivery of Proposals
102.8 Irregular Proposals 102.14 Disqualification of Bidders
102.9 Proposal Guaranty

CIVIL RIGHTS ACT OF 1964

The Kentucky Department of Highways, in accordance with the provisions of Title VI of the Civil Rights Act of 1964 (78 Stat. 252) and the Regulations of the Federal Department of Transportation (49 C.F.R., Part 21), issued pursuant to such Act, hereby notifies all bidders that it will affirmatively insure that the contract entered into pursuant to this advertisement will be awarded to the lowest responsible bidder without discrimination on the ground of race, color, or national origin.

NOTICE TO ALL BIDDERS

To report bid rigging activities call: 1-800-424-9071.

The U.S. Department of Transportation (DOT) operates the above toll-free "hotline" Monday through Friday, 8:00 a.m. to 5:00 p.m. eastern time. Anyone with knowledge of possible bid rigging, bidder collusion, or other fraudulent activities should use the "hotline" to report such activities.

The "hotline" is part of the DOT's continuing effort to identify and investigate highway construction contract fraud and abuse and is operated under the direction of the DOT Inspector General. All information will be treated confidentially and caller anonymity will be respected.

SECOND TIER SUBCONTRACTS

Second Tier subcontracts on federally assisted projects shall be permitted. However, in the case of DBE's, second tier subcontracts will only be permitted where the other subcontractor is also a DBE. All second tier subcontracts shall have the consent of both the Contractor and the Engineer.

DISADVANTAGED BUSINESS ENTERPRISE PROGRAM

It is the policy of the Kentucky Transportation Cabinet (“the Cabinet”) that Disadvantaged Business Enterprises (“DBE”) shall have the opportunity to participate in the performance of highway construction projects financed in whole or in part by Federal Funds in order to create a level playing field for all businesses who wish to contract with the Cabinet. To that end, the Cabinet will comply with the regulations found in 49 CFR Part 26, and the definitions and requirements contained therein shall be adopted as if set out verbatim herein.

The Cabinet, contractors, subcontractors, and sub-recipients shall not discriminate on the basis of race, color, national origin, or sex in the performance of work performed pursuant to Cabinet contracts. The contractor shall carry out applicable requirements of 49 CFR 26 in the award and administration of federally assisted highway construction projects. The contractor will include this provision in all its subcontracts and supply agreements pertaining to contracts with the Cabinet.

Failure by the contractor to carry out these requirements is a material breach of its contract with the Cabinet, which may result in the termination of the contract or such other remedy as the Cabinet deems necessary.

DBE GOAL

The Disadvantaged Business Enterprise (DBE) goal established for this contract, as listed on the front page of the proposal, is the percentage of the total value of the contract.

The contractor shall exercise all necessary and reasonable steps to ensure that Disadvantaged Business Enterprises participate in a least the percent of the contract as set forth above as goals for this contract.

OBLIGATION OF CONTRACTORS

Each contractor prequalified to perform work on Cabinet projects shall designate and make known to the Cabinet a liaison officer who is assigned the responsibility of effectively administering and promoting an active program for utilization of DBEs.

If a formal goal has not been designated for the contract, all contractors are encouraged to consider DBEs for subcontract work as well as for the supply of material and services needed to perform this work.

Contractors are encouraged to use the services of banks owned and controlled by minorities and women.

CERTIFICATION OF CONTRACT GOAL

Contractors shall include the following certification in bids for projects for which a DBE goal has been established. BIDS SUBMITTED WHICH DO NOT INCLUDE CERTIFICATION OF DBE PARTICIPATION WILL NOT BE ACCEPTED. These bids will not be considered for award by the Cabinet and they will be returned to the bidder.

“The bidder certifies that it has secured participation by Disadvantaged Business Enterprises (“DBE”) in the amount of ____ percent of the total value of this contract and that the DBE participation is in compliance with the requirements of 49 CFR 26 and the policies of the Kentucky Transportation Cabinet pertaining to the DBE Program.”

The certification statement is located in the electronic bid file. All contractors must certify their DBE participation on that page. DBEs utilized in achieving the DBE goal must be certified and prequalified for the work items at the time the bid is submitted.

DBE PARTICIPATION PLAN

Lowest responsive bidders must submit the *DBE Plan/ Subcontractor Request*, form TC 14-35 DBE, within **5** days of the letting. This is necessary before the Awards Committee will review and make a recommendation. **The project will not be considered for award prior to submission and approval of the apparent low bidder’s DBE Plan/Subcontractor Request.**

The DBE Participation Plan shall include the following:

- 1 Name and address of DBE Subcontractor(s) and/or supplier(s) intended to be used in the proposed project;
- 2 Description of the work each is to perform including the work item , unit, quantity, unit price and total amount of the work to be performed by the individual DBE. The Project Code Number (PCN), Category Number, and the Project Line Number can be found in the “material listing” on the Construction Procurement website under the specific letting;
- 3 The dollar value of each proposed DBE subcontract and the percentage of total project contract value this represents. DBE participation may be counted as follows; a) If DBE suppliers and manufactures assume actual and contractual responsibility, the dollar value of materials to be furnished will be counted toward the goal as follows:
 - The entire expenditure paid to a DBE manufacturer;
 - 60 percent of expenditures to DBE suppliers that are not manufacturers provided the supplier is a regular dealer in the product involved. A regular dealer must be engaged in, as its principal business and in its own name, the sale of products to the public, maintain an inventory and own and operate distribution equipment; and
 - The amount of fees or commissions charged by the DBE firms for a bona fide service, such as professional, technical, consultant, or managerial services and assistance in the procurement of essential personnel, facilities, equipment, materials, supplies, delivery of materials and supplies or for furnishing bonds, or insurance, providing such fees or commissions are determined to be reasonable and customary.

- b) The dollar value of services provided by DBEs such as quality control testing, equipment repair and maintenance, engineering, staking, etc.;
 - c) The dollar value of joint ventures. DBE credit for joint ventures will be limited to the dollar amount of the work actually performed by the DBE in the joint venture;
- 4 Written and signed documentation of the bidder's commitment to use a DBE contractor whose participation is being utilized to meet the DBE goal; and
- 5 Written and signed confirmation from the DBE that it is participating in the contract as provided in the prime contractor's commitment.

UPON AWARD AND BEFORE A WORK ORDER WILL BE ISSUED

Contractors must submit the signed subcontract between the contractor and the DBE contractor, the DBE's certificate of insurance, and an affidavit for bidders, offerors, and contractors from the DBE to the Division of Construction Procurement. The affidavit can be found on the Construction Procurement website. If the DBE is a supplier of materials for the project, a signed purchase order and an affidavit for bidders, offerors, and contractors must be submitted to the Division of Construction Procurement.

Changes to DBE Participation Plans must be approved by the Cabinet. The Cabinet may consider extenuating circumstances including, but not limited to, changes in the nature or scope of the project, the inability or unwillingness of a DBE to perform the work in accordance with the bid, and/or other circumstances beyond the control of the prime contractor.

CONSIDERATION OF GOOD FAITH EFFORTS REQUESTS

If the DBE participation submitted in the bid by the apparent lowest responsive bidder does not meet or exceed the DBE contract goal, the apparent lowest responsive bidder must submit a Good Faith Effort Package to satisfy the Cabinet that sufficient good faith efforts were made to meet the contract goals prior to submission of the bid. Efforts to increase the goal after bid submission will not be considered in justifying the good faith effort, unless the contractor can show that the proposed DBE was solicited prior to the letting date. DBEs utilized in achieving the DBE goal must be certified and prequalified for the work items at the time the bid is submitted. One complete set and nine (9) copies of this information must be received in the office of the Division of Contract Procurement no later than 12:00 noon of the tenth calendar day after receipt of notification that they are the apparent low bidder.

Where the information submitted includes repetitious solicitation letters it will be acceptable to submit a sample representative letter along with a distribution list of the firms solicited. Documentation of DBE quotations shall be a part of the good faith effort submittal as necessary to demonstrate compliance with the factors listed below which the Cabinet considers in judging good faith efforts. This documentation may include written subcontractors' quotations, telephone log notations of verbal quotations, or other types of quotation documentation.

The Good Faith Effort Package shall include, but may not be limited to information showing evidence of the following:

- 1 Whether the bidder attended any pre-bid meetings that were scheduled by the Cabinet to inform DBEs of subcontracting opportunities;
- 2 Whether the bidder provided solicitations through all reasonable and available means;
- 3 Whether the bidder provided written notice to all DBEs listed in the DBE directory at the time of the letting who are prequalified in the areas of work that the bidder will be subcontracting;
- 4 Whether the bidder followed up initial solicitations of interest by contacting DBEs to determine with certainty whether they were interested. If a reasonable amount of DBEs within the targeted districts do not provide an intent to quote or no DBEs are prequalified in the subcontracted areas, the bidder must notify the DBE Liaison in the Office of Minority Affairs to give notification of the bidder's inability to get DBE quotes;
- 5 Whether the bidder selected portions of the work to be performed by DBEs in order to increase the likelihood of meeting the contract goals. This includes, where appropriate, breaking out contract work items into economically feasible units to facilitate DBE participation, even when the prime contractor might otherwise perform these work items with its own forces;
- 6 Whether the bidder provided interested DBEs with adequate and timely information about the plans, specifications, and requirements of the contract;
- 7 Whether the bidder negotiated in good faith with interested DBEs not rejecting them as unqualified without sound reasons based on a thorough investigation of their capabilities. Any rejection should be so noted in writing with a description as to why an agreement could not be reached;
- 8 Whether quotations were received from interested DBE firms but were rejected as unacceptable without sound reasons why the quotations were considered unacceptable. The fact that the DBE firm's quotation for the work is not the lowest quotation received will not in itself be considered as a sound reason for rejecting the quotation as unacceptable. The fact that the bidder has the ability and/or desire to perform the contract work with its own forces will not be considered a sound reason for rejecting a DBE quote. Nothing in this provision shall be construed to require the bidder to accept unreasonable quotes in order to satisfy DBE goals;
- 9 Whether the bidder specifically negotiated with subcontractors to assume part of the responsibility to meet the contract DBE goal when the work to be subcontracted includes potential DBE participation;
- 10 Whether the bidder made any efforts and/or offered assistance to interested DBEs in obtaining the necessary equipment, supplies, materials, insurance and/or bonding to satisfy the work requirements of the bid proposal; and
- 11 Any other evidence that the bidder submits which may show that the bidder has made reasonable good faith efforts to include DBE participation.

FAILURE TO MEET GOOD FAITH REQUIREMENT

Where the apparent lowest responsive bidder fails to submit sufficient participation by DBE firms to meet the contract goal and upon a determination by the Good Faith Committee based upon the information submitted that the apparent lowest responsive bidder failed to make sufficient reasonable efforts to meet the contract goal, the bidder will be offered the opportunity to meet in person for administrative reconsideration. The bidder will be notified of the Committee's decision within 24 hours of its decision. The bidder will have 24 hours to request reconsideration of the Committee's decision. The reconsideration meeting will be held within two days of the receipt of a request by the bidder for reconsideration.

The request for reconsideration will be heard by the Office of the Secretary. The bidder will have the opportunity to present written documentation or argument concerning the issue of whether it met the goal or made an adequate good faith effort. The bidder will receive a written decision on the reconsideration explaining the basis for the finding that the bidder did or did not meet the goal or made adequate Good Faith efforts to do so.

The result of the reconsideration process is not administratively appealable to the Cabinet or to the United States Department of Transportation.

The Cabinet reserves the right to award the contract to the next lowest responsive bidder or to rebid the contract in the event that the contract is not awarded to the low bidder as the result of a failure to meet the good faith requirement.

SANCTIONS FOR FAILURE TO MEET DBE REQUIREMENTS OF THE PROJECT

Failure by the prime contractor to fulfill the DBE requirements of a project under contract or to demonstrate good faith efforts to meet the goal constitutes a breach of contract. When this occurs, the Cabinet will hold the prime contractor accountable, as would be the case with all other contract provisions. Therefore, the contractor's failure to carry out the DBE contract requirements shall constitute a breach of contract and as such the Cabinet reserves the right to exercise all administrative remedies at its disposal including, but not limited to the following:

- Disallow credit toward the DBE goal;
- Withholding progress payments;
- Withholding payment to the prime in an amount equal to the unmet portion of the contract goal; and/or
- Termination of the contract.

PROMPT PAYMENT

The prime contractor will be required to pay the DBE within seven (7) working days after he or she has received payment from the Kentucky Transportation Cabinet for work performed or materials furnished.

CONTRACTOR REPORTING

All contractors must keep detailed records and provide reports to the Cabinet on their progress in meeting the DBE requirement on any highway contract. These records may include, but shall not be limited to payroll, lease agreements, cancelled payroll checks, executed subcontracting agreements, etc. Prime contractors will be required to complete and submit a signed and notarized affidavit (TC 18-7) and copies of checks for any monies paid to each DBE subcontractor or supplier utilized to meet a DBE goal. **These documents must be submitted within 10 days of being paid by the Cabinet.**

Payment information that needs to be reported includes date the payment is sent to the DBE, check number, Contract ID, amount of payment and the check date. Before Final Payment is made on this contract, the Prime Contractor will certify that all payments were made to the DBE subcontractor and/or DBE suppliers.

The Prime Contractor should supply the payment information at the time the DBE is compensated for their work. Form to use is located at:

<http://transportation.ky.gov/Construction/Pages/Subcontracts.aspx>

The prime contractor should notify the KYTC Office of Civil Rights and Small Business Development seven (7) days prior to DBE contractors commencing work on the project. The contact is Melvin Bynes and the telephone number is (502) 564-3601.

Photocopied payments and completed, signed and notarized affidavit must be submitted by the Prime Contractor to: Office of Civil Rights and Small Business Development
6th Floor West 200 Mero Street
Frankfort, KY 40622

DEFAULT OR DECERTIFICATION OF THE DBE

If the DBE subcontractor or supplier is decertified or defaults in the performance of its work, and the overall goal cannot be credited for the uncompleted work, the prime contractor may utilize a substitute DBE or elect to fulfill the DBE goal with another DBE on a different work item. If after exerting good faith effort in accordance with the Cabinet's Good Faith Effort policies and procedures, the prime contractor is unable to replace the DBE, then the unmet portion of the goal may be waived at the discretion of the Cabinet.

1/27/2017

LEGAL REQUIREMENTS AND RESPONSIBILITY TO THE PUBLIC – CARGO PREFERENCE ACT (CPA).

(REV 12-17-15) (1-16)

SECTION 7 is expanded by the following new Article:

102.10 **Cargo Preference Act – Use of United States-flag vessels.**

Pursuant to Title 46CFR Part 381, the Contractor agrees

- To utilize privately owned United States-flag commercial vessels to ship at least 50 percent of the gross tonnage (computed separately for dry bulk carriers, dry cargo liners, and tankers) involved, whenever shipping any equipment, material, or commodities pursuant to this contract, to the extent such vessels are available at fair and reasonable rates for United States-flag commercial vessels.

- To furnish within 20 days following the date of loading for shipments originating within the United States or within 30 working days following the date of loading for shipments originating outside the United States, a legible copy of a rated, 'on-board' commercial ocean bill-of-lading in English for each shipment of cargo described in paragraph 1 of this section to both the Contracting Officer (through the prime contractor in the case of subcontractor bills-of-lading) and to the Division of National Cargo, Office of Market Development, Maritime Administration, Washington, DC 20590.

- To insert the substance of the provisions of this clause in all subcontracts issued pursuant to this contract.

NATIONAL HIGHWAY

Be advised this project is on the NATIONAL HIGHWAY SYSTEM.

PROJECT TRAFFIC COORDINATOR (PTC)

Be advised this project is a significant project pursuant to section 112.03.12.

ASPHALT MIXTURE

Unless otherwise noted, the Department estimates the rate of application for all asphalt mixtures to be 110 lbs/sy per inch of depth.

FUEL AND ASPHALT PAY ADJUSTMENT

The Department has included the Contract items Asphalt Adjustment and Fuel Adjustment for possible future payments at an established Contract unit price of \$1.00. The Department will calculate actual adjustment quantities after work is completed. If existing Contract amount is insufficient to pay all items on the contract with the adjustments, the Department will establish additional monies with a change order.

OPTION A

Be advised that the Department will accept compaction of asphalt mixtures furnished for driving lanes and ramps, at 1 inch (25mm) or greater, on this project according to OPTION A in accordance with Section 402 and Section 403 of the current Standard Specifications. The Department will require joint cores as described in Section 402.03.02 for surface mixtures only. The Department will accept compaction of all other asphalt mixtures according to OPTION B.

SPECIAL NOTES APPLICABLE TO PROJECT – GENERAL NOTES & DESCRIPTION OF WORK

CAUTION

The information in this proposal and the type of work listed herein are approximate only and are not to be taken as an exact evaluation of materials and conditions to be encountered during construction; the bidder must draw his/her own conclusions. The Department does not give any guarantee as to the accuracy of the data and no claim for money or time extension will be considered if the conditions encountered are not in accordance with the information shown.

ON-SITE INSPECTION

Before submitting a bid for the work, make a thorough inspection of the site and determine existing conditions so that the work can be expeditiously performed after the contract is awarded. The Department will consider submission of a bid to be evidence of this inspection having been made. The Department will not honor any claims for money or time extension resulting from site conditions.

CONTROL

Perform all work under the absolute control of the Department of Highways. Obtain the Engineer's approval of all designs required to be furnished by the Contractor prior to incorporation into the work. The Department reserves the right to have work performed by other contractors and its own forces and to permit public utility companies and others to do work during the construction within the limits of, or adjacent to, the project. Conduct operations and cooperate with such other parties so that interference with such other work will be reduced to a minimum. The Department will not honor any claims for money or time extension created by the operations of such other parties. Should a difference of opinion arise as to the rights of the Contractor and others working within the limits of, or adjacent to, the project, the Engineer will decide as to the respective rights of the various parties involved in order to assure the completion of the Department's work in general harmony and in a satisfactory manner, and his/her decision shall be final and binding upon the Contractor.

DESCRIPTION OF WORK

Except as specified herein, perform all work in accordance with the Department's Standard Specifications, Supplemental Specifications, applicable Special Notes and Special Provisions, and applicable Standard and Sepia Drawings, current editions. Furnish all materials, labor, equipment, and incidentals for the following work:

Construction of a J-Turn Intersection. The intent of this project is to construct 3 J-Turn Intersections at the intersections of US 31W @ KY 220, KY 434, and Blackjack Road. This will be accomplished by constructing a Standard Barrier Median in the middle of the US 31W @ KY 220, KY 434, and Blackjack Road intersections. Turn lanes and U-Turn crossovers will be located a short distance upstream and downstream from the main US 31W @ KY 220, KY 434, and Blackjack Road intersections. Loons will be located along the slow lanes shoulders of US 31W at the southern U-Turn Crossover @ KY 220 and the southern and northern U-turn Crossovers @ KY 434.

General Notes & Description of Work

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Standard Barrier Median. Standard Barrier Median has been designed to prevent the thru and left turning movements from KY 220, KY 434, and Blackjack Road onto US 31W, but still allow left turning movements from US 31W onto KY 220, KY 434, and Blackjack Road. Details within the Proposal show the design and layout for the Standard Barrier Median.

Turn Lanes and U-Turn Crossovers. Since the thru and left turning movements from KY 220, KY 434 and Blackjack Road onto US 31W are being prohibited in this design, Left Turn Lanes and U-Turns are being provided a short distance from the main intersections of US 31W @ KY 220, KY 434 and Blackjack Road. Details within the Proposal show the design and layout for the Turn Lanes and U-Turn Crossovers.

Loons. To accommodate vehicles that require a large turning radius at the U-Turns, Loons are to be constructed along US 31W at the southern U-Turn Crossover @ KY 220 and the southern and northern U-turn Crossovers @ KY 434. Details within the Proposal show the design and layout for the Loons.

Remove Signals. This work will include removal of poles, equipment, and concrete bases. Concrete bases to be removed to 12 inches below existing ground line; stop signals at KY 434 intersection and northbound warning flashers. Deliver removed signal heads, cabinets, and warning flashers to:

310 Valley Road
Elizabethtown, KY 42701

Before Delivering, contact Jake Riggs:
(270) 401-8132

Remove Guardrail. Removed guardrail to be delivered to Bailey Bridge Yard.

Drainage. To accommodate the new turn lanes and U-Turns, the existing drainage along US 31W must be modified. Refer to the plans and cross sections within the Proposal for the pipe construction, pipe extension, proposed drainage structures, and ditch construction details.

Striping & Pavement Markings. Install the proposed Striping and Pavement Markings, as detailed on the Striping Plan. See Special Note for Spray Applied Thermo.

SPECIAL NOTE FOR STAKING

Perform Contractor Staking according to Section 201; except, in addition to the requirements of Section 201, perform the following:

1. Contrary to Section 201, perform items 1-3 usually performed by the Engineer.
2. Verify the dimensions, type, and quantities of the culvert pipes, entrance pipes, and/or box culverts as listed and detailed in the proposal, and determine flow line elevations and slopes necessary to provide positive drainage. Revise as necessary to accommodate the existing site conditions; to provide proper alignment of the drainage structures with existing and/or proposed ditches, stream channels, swales, and the roadway lines and grades; and to ensure positive drainage upon completion of the work.
3. Using paint marks on the pavement, and/or any other means approved by the Engineer, the Contractor shall layout and pre-mark the proposed barrier median. Adjust as necessary to accommodate the existing site conditions and to provide proper alignment of the proposed thru and turning lanes. Obtain approval of the pre-marked layout from the Engineer and/or District Traffic Engineer prior to installing the barrier median.
4. Using paint marks on the pavement, and/or any other means approved by the Engineer, the Contractor shall layout and pre-mark the proposed striping, pavement markings, etc. Adjust as necessary to accommodate the existing site conditions and to provide proper alignment of the proposed thru and turning lanes. Obtain approval of the pre-marked layout from the Engineer and/or District Traffic Engineer prior to installing the striping and/or pavement markings.
5. Produce and furnish to the Engineer "As Built" information for the drainage improvements. The as built information will consist of a final record of the actual types, sizes, and locations of the drainage structures (i.e. box inlets, headwalls, junction boxes, etc.), culvert pipes, and/or box culverts constructed. Final elevation data of the drainage improvements is not necessary.
6. Prior to incorporating into the work, obtain the Engineers approval of all revisions determined by the Contractor.
7. Perform any and all other staking operations required to control and construct the work.

SPECIAL NOTE FOR EROSION CONTROL

I. DESCRIPTION

Perform all erosion and water pollution control work in accordance with any other notes in the Proposal, the Department's Standard and Interim Supplemental Specifications, the Special Provisions and Special Notes, and the Standard and Sepia Drawings, current editions, or as directed by the Engineer. Section references are to the Standard Specifications. This work shall consist of:

(1) Developing and preparing a Best Management Practices Plan (BMP) tailored to suit the specific construction phasing for each site within the project; (2) Preparing the project site for construction, including locating, furnishing, installing, and maintaining temporary and/or permanent erosion and water pollution control measures as required by the BMP prior to beginning any earth disturbing activity on the project site; (3) Clearing and grubbing and removal of all obstructions as required for construction; (4) Removing all erosion control devices when no longer needed; (5) Restoring all disturbed areas as nearly as possible to their original condition; (6) Preparing seedbeds and permanently seeding all disturbed areas; (7) Providing a Kentucky Erosion Prevention and Sediment Control Program (KEPSC) qualified inspector; and (8) Performing any other work to prevent erosion and/or water pollution as specified by this contract, required by the BMP, or as directed by the Engineer.

II. MATERIALS

Furnish materials in accordance with these notes, the Standard Specifications and Interim Supplemental Specifications, applicable Special Provisions and Special Notes, and the Standard and Sepia Drawings, current editions. Provide for all materials to be sampled and tested in accordance with the Department's Sampling Manual. Unless directed otherwise by the Engineer, make the materials available for sampling a sufficient time in advance of the use of the materials to allow for the necessary time for testing.

III. CONSTRUCTION

Be advised, these Erosion Control Notes do not constitute a BMP plan for the project. Jointly with the Engineer, prepare a site specific BMP plan for each drainage area within the project in accordance with Section 213. Provide a unique BMP at each project site using good engineering practices taking into account existing site conditions, the type of work to be performed, the construction phasing, methods, and the techniques to be utilized to complete the work. Be responsible for all erosion prevention, sediment control, and water pollution prevention measures required by the BMP for each site. Represent and warrant compliance with the Clean Water Act (33 USC Section 1251 et seq.), the 404 Permit, the 401 Water Quality Certification, and applicable state and local government agency laws, regulations, rules, specifications, and permits. Contrary to Section 105.05, in case of discrepancy between these notes, the Standard Specifications, Interim Supplemental Specifications, Special Provisions and Special Notes, Standard and Sepia Drawings, and such state and local government agency requirements, adhere to the most restrictive requirement.

Erosion Control

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Conduct operations in such a manner as to minimize the amount of disturbed ground during each phase of the construction and limit the haul roads to the minimum required to perform the work. Preserve existing vegetation not required to be removed by the work or the contract. Seed and/or mulch disturbed areas at the earliest opportunity. Use silt fence, silt traps, temporary ditches, brush barriers, erosion control blankets, sodding, channel lining, and other erosion control measures in a timely manner as required by the BMP and as directed or approved by the Engineer. Prevent sediment laden water from leaving the project, entering an existing drainage structure, or entering a stream.

Provide for erosion control measures to be in place and functioning prior to any earth disturbance within a drainage area. Compute the volume and size of silt control devices necessary to control sediment during each phase of construction. All silt control devices shall be sized to retain a volume of 3,600 cubic feet per disturbed contributing acre. Remove sediment from silt traps before they become a maximum of ½ full. Maintain silt fence by removing accumulated trappings and/or replacing the geotextile fabric when it becomes clogged, damaged, or deteriorated, or when directed by the Engineer. Properly dispose of all materials trapped by erosion control devices at approved sites off the right of way obtained by the Contractor at no additional cost to the Department. See the Special Provision for Waste and Borrow Sites.

As work progresses, add or remove erosion control measures as required by the BMP, applicable to the Contractor's project phasing, construction methods, and techniques. Update the volume calculations and modify the BMP as necessary throughout the duration of the project. Ensure that an updated BMP is kept on site and available for public inspection throughout the life of the project.

The required volume at each Silt Trap shall be computed based on the Up Gradient Contributing Areas that are disturbed and/or stabilized to the satisfaction of the Engineer. The required volume calculation for each Silt Trap shall be determined by the Contractor and verified by the Engineer. The required volume at each Silt Trap may be reduced by the following amounts:

- Up Gradient Areas not disturbed (acres)
- Up Gradient Areas that have been reclaimed and protected by Erosion Control Blanket or other ground protection material such as Temporary Mulch (acres)
- Up Gradient Areas that have been protected by Silt Fence (acres) – Areas protected by Silt Fence shall be computed at a maximum rate of 100 square feet per linear foot of Silt Fence
- Up Gradient Areas that have been protected by Silt Traps (acres)

The use of Temporary Mulch is encouraged.

Silt Trap Type B shall always be placed at the collection point prior to discharging into a Blue Line Stream or onto an adjacent Property Owner. Where overland flow exists, a Silt Fence or other filter devices may be used.

After all construction is complete, restore all disturbed areas in accordance with Section 212. Completely remove all temporary erosion control devices not required as part of the permanent erosion control from the construction site. Prior to removal, obtain the Engineer's concurrence of items to be removed. Grade the remaining exposed earth (both on and off the Right-of-Way) as nearly

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as possible to its original condition, or as directed by the Engineer. Prepare the seed bed areas and sow all exposed earthen areas with the applicable seed mixture(s) according to Section 212.03.03.

IV. MEASUREMENT

The Department will measure the various erosion control items according to Section 212.04 and Section 213.04, as applicable.

V. BASIS OF PAYMENT

The Department will make payment for the various erosion control items according to Section 212.04 and Section 213.04, as applicable.

SPECIAL NOTES FOR PIPE REPLACEMENTS / EXTENSIONS

I. DESCRIPTION

Except as provided herein, perform all work in accordance with the Department's Standard Specifications, interim Supplemental Specifications, Standard and Sepia Drawings, and Special Notes and Special Provisions, current editions. Article references are to the Standard Specifications. This project shall consist of furnishing all labor, equipment, materials, and incidentals for the following:

(1) Maintaining and Controlling Traffic; (2) Constructing pipe replacements and/or pipe extensions; (3) Embankment and/or Excavation; (4) Erosion Control; and (6) Any other work as specified by this contract.

II. MATERIALS

Provide for sampling and testing of all materials in accordance with the Department's Sampling Manual. Make materials available for sampling a sufficient time in advance of the use of the materials to allow for the necessary time for testing unless otherwise specified in these notes.

A. Maintain and Control Traffic. See Traffic Control Plan.

B. Culvert Pipe. Furnish pipe meeting the requirements of Section 810. Select pipe for pH range Medium and minimum fill cover height according to the applicable Standard or Sepia Drawings, current editions. Verify maximum and minimum fill cover height required for new pipe prior to construction and obtain the Engineer's approval of the class or gauge of pipe and type of coating prior to delivering pipe to project. Furnish approved connecting bands or pipe anchors and toe walls.

C. Flowable Fill. Furnish Flowable Fill for Pipe Backfill per Section 601.03.03(B).

D. Erosion Control. See Special Note for Erosion Control.

III. CONSTRUCTION METHODS

A. Maintain and Control Traffic. See Traffic Control Plan.

B. Erosion Control. See Special Note for Erosion Control.

C. Site Preparation. Be responsible for all site preparation including, but not limited to, saw cutting and removing pavement; clearing and grubbing; staking; incidental excavation and backfilling; common and solid rock excavation; embankment in place; removal of obstructions, or any other items; restoration of pavements, slopes, and all disturbed areas; final dressing and cleanup; and disposal of materials. Limit clearing and grubbing to the absolute minimum required to construct the drainage features. Perform all site preparation only as approved or directed by the Engineer.

Pipe Replacements/Extensions
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- D. Removing Headwalls, Pipe, and Excavation.** Remove existing headwalls and lengths of culvert and/or entrance pipes at the approximate locations noted in the Proposal. The Engineer will determine the exact locations and lengths of pipe to be removed at the time of construction. When removing pipe, or any portion of pipe under the roadway, saw cut the existing asphalt pavement and base to a neat edge prior to excavation and removal of the existing pipe. NOTE: Saw cutting the pavement shall be incidental. Obtain the Engineer's approval of trench width and/or saw cutting limits prior to saw cutting the pavement. Excavate the trench and remove the pipe as directed, or approved, by the Engineer without disturbing existing underground utilities.
- E. Constructing Pipe, Headwalls, and Drainage Boxes.** Construct culvert and/or entrance pipes, pipe extensions, headwalls, drainage boxes, and other drainage structures at the locations shown in the proposal or as designated by the Engineer. The contractor will establish, with the approval of the Engineer, the final centerlines, flow lines, and skews to obtain the best fit with the existing and/or proposed ditches and other proposed improvements. (See the Special Note for Staking.) Construct pipe bedding according to Section 701 and the applicable Standard or Sepia Drawings, current editions. Use approved connecting bands or concrete anchors as required. Prior to backfilling pipe, obtain the Engineer's approval of the pipe installation. Provide Positive drainage upon completion of pipe installation.
- F. Pipe Backfill.** Backfill entrance pipes according to Section 701.03.06. Contrary to Section 701.03.06, backfill culvert pipes under the roadway with flowable fill for the width of the roadway. Steel plates may be required to maintain traffic while the flowable fill cures. Once the flowable fill has sufficiently cured, place the Asphalt Base in lifts with thicknesses of 3-4 inches, up to the surface of the existing pavement. Seal with Leveling & Wedging. Allow the asphalt base and leveling & wedging to be exposed to traffic for a minimum of 14 days to allow for settlement. During the waiting period, level & wedge any settlement as directed by the Engineer. After the waiting period has been met for the last pipe replacement constructed, the final milling and/or surfacing operations can begin, unless directed otherwise by the Engineer.
- G. Embankments.** Backfill pipe and culvert extensions, and construct shoulder embankments as directed by the Engineer. The contractor shall bench into the existing slope and apply proper compaction according to Section 206. Provide positive drainage of ditches, shoulders, and slopes at all times during, and upon completion of construction.
- H. Property Damage.** Be responsible for all damage to public and/or private property resulting from the work. Repair or replace damaged roadway features in like kind materials and design, as directed by the Engineer at no additional cost to the Department. Repair or replace damaged private property in like kind materials and design to the satisfaction of the owner and the Engineer at no additional cost to the Department.
- I. Coordination with Utility Companies.** Locate all underground, above ground, and overhead utilities prior to beginning construction. Be responsible for contacting and maintaining liaison with all utility companies that have utilities located within the project limits. Do not disturb

Pipe Replacements/Extensions
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existing overhead or underground utilities. It is not anticipated that any utility facilities will need to be relocated and/or adjusted; however, in the event that it is discovered that the work does require that utilities be relocated and/or adjusted, the utility companies will work concurrently with the Contractor while relocating their facilities. Be responsible for repairing all utility damage that occurs as a result of pipe replacement and pipe extension operations at no additional cost to the Department. NOTIFY THE ENGINEER AND THE UTILITY OWNER(S) IMMEDIATELY WHEN IT IS DISCOVERED OR ANTICIPATED THAT ANY UTILITY CONFLICT COULD DELAY THE CONTRACTOR'S OPERATIONS. If the total delay exceeds ten working days, an extension of the specified completion date will be negotiated with the Contractor for delay to the Contractor's work; however, no extension will be granted for any delay caused by the Contractor's failure to notify the Engineer and/or the utility company as specified above when a conflict is discovered or anticipated as specified.

- J. Clean Up, Disposal of Waste.** Clean up the project area as work progresses. Dispose of all removed concrete, pipe, pavement, debris, excess and unsuitable excavation, and all other waste at approved sites off the Right of Way obtained by the Contractor at no additional cost to the Department. See the Special Provision for Waste and Borrow Sites.
- K. Final Dressing, Seeding and Protection.** Grade all disturbed areas to blend with the adjacent roadways features and to provide a suitable seed bed. Apply Class A Final Dressing to all disturbed areas, both on and off the Right-of-Way. Sow all disturbed earthen areas with the applicable seed mixture(s) according to Section 212.03.03.
- L. Erosion Control.** See the Special Note for Erosion Control.

IV. METHOD OF MEASUREMENT

- A. Maintain and Control Traffic.** See the Traffic Control Plan.
- B. Site Preparation.** Other than the bid items listed, site preparation will NOT be measured for payment, but shall be incidental to culvert and/or entrance pipe bid items, as applicable.
- C. Remove Headwall.** The Department will measure the removal of existing headwalls as Each. Any excavation, including rock excavation, necessary to remove existing headwalls will NOT be measured for payment, but shall be incidental to the bid item "Remove Headwall".
- D. Remove Pipe.** Removal of existing culvert and entrance pipe shall be measured according to Section 701.04.14. Any excavation, including rock excavation, necessary to remove existing pipe will NOT be measured for payment, but shall be incidental to the bid item "Remove Pipe".
- E. Culvert and Entrance Pipe.** The Department will measure the quantities according to Section 701.04. Any excavation, including rock excavation, necessary to install culvert or

Pipe Replacements/Extensions
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entrance pipe shall be incidental to the corresponding pipe bid items.

- F. Headwalls, Drainage Boxes.** The Department will measure according to Section 710. Any excavation, including rock excavation, necessary to construct headwalls and/or drainage boxes will NOT be measured for payment, but shall be incidental to the applicable bid item.
- G. Excavation, Pipe Backfill, Embankments.** The Department will NOT measure for payment the following items: any excavation, including rock excavation, necessary to remove the existing pipe and/or install the proposed culvert or entrance pipe, pipe backfill material, flowable fill, and re-constructing shoulder embankments, but shall considered these items incidental to the bid items for culvert and entrance pipe.
- H. Clean Up, Disposal of Waste, Final Dressing, Seeding and Protection.** The Department will NOT measure for payment the following activities: Clean Up, Disposal of Waste, and Final Dressing. These activities shall be incidental to the project bid items. Seeding and Protection shall be measured according to Section 212.
- I. Erosion Control.** See the Special Note for Erosion Control.

V. BASIS OF PAYMENT

- A. Maintain and Control Traffic.** See the Traffic Control Plan.
- B. Remove Headwall.** The Department will make payment for the completed and accepted quantities of Each headwall removed. Payment at the Contract unit price per Each shall be full compensation for furnishing all labor, materials, equipment, and incidentals for removing the existing headwall.
- C. Remove Pipe.** The Department will make payment according to Section 701.05. Payment at the Contract unit price per linear foot shall be full compensation for furnishing all labor, materials, equipment, and incidentals for removing the existing pipe.
- D. Culvert and Entrance Pipe.** The Department will make payment according to Section 701.05. Payment at the Contract unit price per linear foot shall be full compensation for furnishing all labor, materials, equipment, and incidentals necessary for installing and backfilling new culvert and entrance pipe.
- E. Headwalls, Drainage Boxes.** The Department will make payment according to Section 710.
- F. Erosion Control.** See the Special Note for Erosion Control.

SPECIAL NOTE FOR NON-TRACKING TACK COAT

1. DESCRIPTION AND USEAGE. This specification covers the requirements and practices for applying a non-tracking tack asphalt coating. Place this material on the existing pavement course, prior to placement of a new asphalt pavement layer. Use when expedited paving is necessary or when asphalt tracking would negatively impact the surrounding area. This material is not suitable for other uses. Ensure material can “break” within 15 minutes under conditions listed in 3.2.

2. MATERIALS, EQUIPMENT, AND PERSONNEL.

2.1 Non-Tracking Tack. Provide material conforming to Subsection 2.1.1.

2.1.1 Provide a tack conforming to the following material requirements:

Property	Specification	Test Procedure
Viscosity, SFS, 77 ° F	20 – 100	AASHTO T 72
Sieve, %	0.3 max.	AASHTO T 59
Asphalt Residue ¹ , %	50 min.	AASHTO T 59
Oil Distillate, %	1.0 max.	AASHTO T 59
Residue Penetration, 77 ° F	20 max.	AASHTO T 49
Original Dynamic Shear (G*/sin δ), 82 ° C	1.0 min.	AASHTO T 315
Softening Point, ° F	149 min.	AASHTO T 53
Solubility, %	97.5 min.	AASHTO T 44

¹ Bring sample to 212 °F over a 10-15 minute period. Maintain 212 °F for 15-20 minutes or until 30-40 mL of water has distilled. Continue distillation as specified in T59.

2.2. Equipment. Provide a distributor truck capable of heating, circulating, and spraying the tack between 170 °F and 180 °F. Do not exceed 180 °F. Circulate the material while heating. As required by the manufacturer, ensure the spray bar is equipped with #1 or #2 ¼” V-slot Etnyre nozzles. Other nozzles are not acceptable. Arrange the nozzles in the following patterns from left to right:

Nozzle number(s)	Activity	Orientation
1	On	Vertical
2	Off	-
3	On	Horizontal
4 & 5	Off	-
6	On	Horizontal
Continue 2 off and 1 on pattern through rest of spray bar system.		

Ensure the bar can be raised to between 14 and 18” from the roadway.

2.3 Personnel. Ensure the tack supplier has provided training to the contractor on the installation procedures for this product. Make a technical representative from the supplier available at the request of the Engineer.

3. CONSTRUCTION.

3.1 Surface Preparation. Prior to the application of the non-tracking tack, ensure the pavement surface is thoroughly dry and free from dust or any other debris that would inhibit adhesion. Clean the surface by scraping, sweeping, and the use of compressed air. Ensure this preparation process occurs shortly before application to prevent the return of debris pavement. If rain is expected within one hour after application, do not apply material. Apply material only when the surface is dry, and no precipitation is expected.

3.2 Non-tracking Tack Application. Ensure the roadway temperature is a minimum of 40 °F and rising during the application of the tack. This material is not suitable for use in colder temperatures. Prior to applying the tack, demonstrate competence in applying the tack according to this note to the satisfaction of the Engineer. Heat the tack in the distributor to between 170 – 180 °F. After initial heating to between 170 – 180 °F, the material may be sprayed between 165 °F and 180 °F. Do not apply outside this temperature range. Apply material at a rate of 0.50 pounds (0.06 gallons) per square yard. Ensure full coverage of the material on the pavement surface. Full coverage of this material is critical. If full coverage is not achieved, material application rate may be increased to ensure full coverage. Do not heat material more than twice in one day.

3.3 Non-tracking Tack Certification. Furnish the tacks certification to the Engineer stating the material conforms to all requirements herein prior to use.

3.4 Sampling and Testing. The Department will require a sample of non-tracking tack be taken from the distributor at a rate of one sample per 15,000 tons of mix. Take two 1 gallon samples of the heated material and forward the sample to the Division of Materials for testing within 7 days. Ensure the product temperature is between 170 and 180 °F at the time of sampling.

4. MEASUREMENT. The Department will measure the quantity of non-tracking tack in tons. The Department will not measure for payment any extra materials, labor, methods, equipment, or construction techniques used to satisfy the requirements of this note. The Department will not measure for payment any trial applications of non-tracking tack, the cleaning of the pavement surface, or furnishing and placing the adhesive. The Department will consider all such items incidental to the non-tracking tack.

5. PAYMENT. The Department will pay for the non-tracking tack at the Contract unit bid price and apply an adjustment for each manufacturer's lot of material based on the degree of compliance as defined in the following schedule. When a sample fails on two or more tests, the Department may add the deductions, but the total deduction will not exceed 100 percent.

Non-Tracking Tack Price Adjustment Schedule						
Test	Specification	100% Pay	90% Pay	80% Pay	50% Pay	0% Pay
Viscosity, SFS, 77 ° F	20 – 100	19 - 102	17 - 18	15 - 16	14	≤13
			103 - 105	106 - 107	108 - 109	≥ 110
Sieve, %	0.30 max.	≤ 0.40	0.41 - 0.50	0.51 - 0.60	0.61 - 0.70	≥ 0.71
Asphalt Residue, %	50 min.	≥49.0	48.5 – 48.9	48.0 – 48.4	47.5-47.9	≤ 47.4
Oil Distillate, %	1.0 max.	≤1.0	1.1-1.5	1.6 - 1.7	1.8-1.9	>2.0
Residue Penetration, 77 ° F	20 max.	≤ 21	22 - 23	24 - 25	26 - 27	≥ 28
Original Dynamic Shear (G*/sin δ), 82 ° C	1.0 min.	≥0.95	0.92 – 0.94	0.90 – 0.91	0.85 - 0.89	≤ 0.84
Softening Point, ° F	149 min.	≥145	142 - 144	140 - 141	138 - 139	≤ 137
Solubility, %	97.5 min.	≥ 97.0	96.8 – 96.9	96.6 – 96.7	96.4 – 96.5	≤ 96.3

<u>Code</u>	<u>Pay Item</u>	<u>Pay Unit</u>
24970EC	Asphalt Material for Tack Non-Tracking	Ton

April 30, 2018

SPECIAL NOTE FOR SPRAY APPLIED THERMOPLASTIC PAVEMENT MARKING MATERIALS

I. DESCRIPTION

Except as provided herein, all work shall be performed in accordance with the Department’s Standard Specifications, Interim Supplemental Specifications, applicable Standard and Sepia Drawings, applicable Special Provisions and Special Notes, current editions. Article references are to the Standard Specifications. This project shall consist of furnishing all labor, equipment, materials and incidentals for the following:

- (1) Spray applied thermoplastic pavement marking materials with reflectorized glass beads for permanent applications

II. MATERIALS

- A. **DROP ON BEADS.** Use beads that will ensure the pavement marking material will meet retroreflectivity requirements. The Department will evaluate the beads as part of the marking system through retroreflectivity readings.
- B. **APPROVAL.** Select materials that conform to the composition and physical characteristic requirements below when evaluated in accordance with AASHTO T-250 or other test methods as cited. The Department will sample and evaluate for approval each lot of thermoplastic material delivered for use per contract prior to installation of the thermoplastic material. Do not allow the installation of thermoplastic material until it has been approved by the Division of Materials. Allow the Department a minimum of 10 working days to evaluate and approve thermoplastic material from the date sampled.
- C. **Composition.** Use a maleic-modified glycerol ester resin (alkyd binder) to formulate the thermoplastic material. Ensure the pigment, pre-mix beads, and filler are uniformly dispersed in the resin. Use material that is free from all dirt and foreign material. Provide independent analysis data and certification for each formulation stating the total concentration of each heavy metal present, the test method used for each determination, and compliance to 40 CFR 261 for leachable heavy metals content.

COMPOSITION (Percentage by Weight)		
Component	White	Yellow
Binder, ⁽¹⁾	26.0 min.	26.0 min.
Glass Beads (Premixed)	30 - 40	30 - 40
Titanium Dioxide (Rutile, Type II)	10.0 min.	—
Calcium Carbonate & Inert Fillers ⁽²⁾	42.0 max.	50.0 max.
Heavy Metals Content	Comply with 40 CFR 261	Comply with 40 CFR 261

⁽¹⁾Use a binder that consists of a mixture of synthetic resins, at least one being solid at room temperature, and high boiling point plasticizers. Ensure that at least one-third of the binder composition is solid maleic-modified glycerol ester resin and is not less than 8 percent by weight of the entire material formulation. Do not use alkyd binder that contains petroleum based hydrocarbon resins.

⁽²⁾The manufacturer may choose the amount of calcium carbonate and inert fillers, providing all other requirements of this section are met.

Spray Applied Thermoplastic
 Page 2 of 3

D. Physical Characteristics. For thermoplastic material heated for 4 hours at 425°F under agitation, conform to the following requirements.

a) **Color.** As determined with a spectrophotometer using D65 illuminant with a 45 degree entrance angle and 0 degree observation angle geometry.

CIELAB Color Coordinates		
	Yellow	White
Daytime Color (CIELAB) Spectrophotometer using illuminant D65 at 45° illumination and 0° viewing with a 2° observer	L* 81.76 a* 19.79 b* 89.89 Maximum allowable variation 6.0ΔE*	L* 93.51 a* -1.01 b* 0.70 Maximum allowable variation 6.0ΔE*
Nighttime Color (CIELAB) Spectrophotometer using illuminant A at 45° illumination and 0° viewing with a 2° observer	L* 86.90 a* 24.80 b* 95.45 Maximum allowable variation 6.0ΔE*	L* 93.45 a* -0.79 b* 0.43 Maximum allowable variation 6.0ΔE*

b) **Set Time.** Use material that, when applied at a temperature range of 375 ± 25 °F and thickness of 60 ± 10 mils, sets to bear traffic in not more than 2 minutes when the air and road surface temperature is approximately ≥ 50 ± 3 °F, and not more than 10 minutes when the air and road surface temperature is approximately < 50 ± 3 °F.

c) **Softening Point.** Ensure that the thermoplastic material has a softening point of 180 ± 15 °F.

d) **Bond Strength.** Ensure that the bond strength of the thermoplastic material to concrete exceeds 180 psi.

e) **Cracking Resistance at Low Temperature.** Ensure that the thermoplastic material shows no cracks when observed from a distance exceeding one foot.

f) **Impact Resistance.** Ensure the impact resistance of the thermoplastic material is a minimum of 50 inch-pounds.

g) **Flash Point.** Use thermoplastic material that has a flash point not less than 475 °F.

E. PACKAGING. Package thermoplastic material in suitable 50 pound containers to which the material shall not adhere during shipment or storage. Include a label stating that the thermoplastic material is to be maintained with a temperature range of 350 – 400°F during application. Provide the thermoplastic material in granular form.

F. SHELF LIFE. Ensure that the thermoplastic material conforms to this section for a period of one year. Replace any thermoplastic material not conforming to the above requirements.

G. MANUFACTURER’S TESTING. Perform testing in accordance with AASHTO T-250 on a minimum of one composite sample per 10,000 pounds, or portion thereof, per lot of thermoplastic produced.

H. CERTIFICATION. Submit manufacturer’s certification stating conformance to the requirements of this section for each lot of extruded thermoplastic delivered for use on projects. Clearly state the manufacture, formulation identification, product name, color, date of manufacturer, total quantity of lot produced, actual quantity of thermoplastic material represented, sampling method utilized to obtain the samples, and required manufacturer’s testing data for each composite sample tested to represent each lot produced.

III. CONSTRUCTION METHODS

- A. **SURFACE PREPARATION.** The contractor will be required to sweep all pavement surfaces prior to striping and maintain the cleaning operation far enough in advance of the striping operation to prevent any dust from the cleaning operation from mixing with the paint. The sweeper must maintain contact with the roadway. When the Engineer determines abnormal amounts of debris or other material have accumulated beyond the capability of the required sweeping unit which will require shoveling or other means to remove, the Engineer will make arrangements, prior to painting, to have the material removed by the Department.
- B. **INSTALLATION.** Install thermoplastic materials in accordance with Section 714, Durable Pavement Striping, and the following exceptions:
 - Install the thermoplastic materials at a minimum thickness of 60 mils.
 - Ensure the material temperature is maintained between 350 and 400°F.
 - Do not allow the material temperature to exceed 400°F.
 - Removal of existing stripe on asphalt surfaces is not required.
- C. **RETROREFLECTIVITY.** The Department will evaluate installed markings in accordance with Section 714.03.06, Proving Period for Durable Markings.

IV. METHOD OF MEASUREMENT

- A. **ACCEPTANCE AND PAYMENT.** The Department will accept spray applied thermoplastic materials based on compliance of the manufacturer’s certification and conformance of test results obtained by the Department to the requirements of this special note.

Contrary to Section 714.03.08, Acceptance of Non-Specification Thermoplastic Markings, the Department will not accept non-specification compliant markings. Remove non-specification compliant markings by water blasting. The Department will perform random thickness tests on applied markings to determine compliance to thickness requirements

IV. BASIS OF PAYMENT

The Department will make payment for the completed and accepted quantities under the following:

<u>Code</u>	<u>Pay Item</u>	<u>Pay Unit</u>
24995EC	PAVE STRIPING-SPRAY THERMO-6 IN W	LF
24996EC	PAVE STRIPING-SPRAY THERMO-6 IN Y	LF

The Department will consider payment as full compensation for furnishing all labor, materials, equipment, and incidentals required to construct spray applied thermoplastic pavement markings.

SPECIAL NOTES FOR COMPLETION DATES & LIQUIDATED DAMAGES

The ultimate fixed completion date for this project will be November 1, 2019. Liquidated Damages for failure to complete the project on time will be assessed following Section 108.09.

In addition to the requirements of Section 108.09, the Department will assess Liquidated Damages in the amount of **\$1,000** per hour for each hour, or fraction of an hour, for any and all closures that are in place beyond the time frame(s) noted in the Traffic Control Plan.

Contrary to Section 108.09, Liquidated Damages will be assessed for the months of December through March.

Contrary to Section 108.09, Liquidated Damages will be assessed regardless of whether seasonal limitations prohibit the Contractor from performing work on the controlling operation.

All liquidated damages will be applied accumulatively.

All other applicable portions of Section 108 apply.

SPECIAL PROVISION FOR WASTE AND BORROW SITES

Obtain U.S. Army Corps of Engineer's approval before utilizing a waste or borrow site that involves "Waters of the United States". The Corps of Engineers defines "Waters of the United States" as perennial or intermittent streams, ponds or wetlands. The Corps of Engineers also considers ephemeral streams, typically dry except during rainfall but having a defined drainage channel, to be jurisdictional waters. Direct questions concerning any potential impacts to "Waters of the United States" to the attention of the appropriate District Office for the Corps of Engineers for a determination prior to disturbance. Be responsible for any fees associated with obtaining approval for waste and borrow sites from the U.S. Army Corps of Engineer or other appropriate regulatory agencies.

1-296 Waste & Borrow Sites
01/02/2012

SPECIAL NOTES FOR GUARDRAIL

I. DESCRIPTION

Except as specified herein, perform all work in accordance with the Department's Standard and Supplemental Specifications, Special Notes and Special Provisions, and the Standard and Sepia Drawings, current editions. Article references are to the Standard Specifications.

Furnish all equipment, labor, materials, and incidentals for the following work items:

(1) Site preparation; (2) Remove existing guardrail systems; (3) Construct Guardrail, End Treatments, Bridge End Connectors, and Terminal Sections, as applicable; (4) Delineators for guardrail; (5) Maintain and Control Traffic; and (6) all other work specified as part of this contract.

II. MATERIALS

Except as specified herein, provide for all materials to be sampled and tested in accordance with the Department's Sampling Manual and make the materials available for sampling a sufficient time in advance of the use of the materials to allow for the necessary time for testing.

- A. Maintain and Control Traffic.** See Traffic Control Plan.
- B. Guardrail.** Furnish guardrail system components according to Section 814 and the Standard and Sepia Drawings; except use steel posts only, no alternates.
- C. Delineators for Guardrail.** Furnish white and/or yellow Delineators for Guardrail according to Standard Drawing RBR-055 – Delineators for Guardrail, current edition.
- D. Erosion Control.** See the Special Note for Erosion Control.

III. CONSTRUCTION METHODS

- A. Maintain and Control Traffic.** See Traffic Control Plan.
- B. Site Preparation.** Remove existing guardrail system, including the guardrail end treatments, Bridge End connectors and all other elements of the existing guardrail system as per Section 719, except that the Contractor will take possession of all concrete posts and all concrete associated with the existing bridge and/or guardrail end treatments. Locate all disposal areas off the Right of Way. Be responsible for all site preparation, including but not limited to, clearing and grubbing, excavation, embankment, and removal of all obstructions or any other items; regrading, reshaping, adding and compacting of suitable materials on the existing shoulders to provide proper template or foundation for the guardrail;

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filling voids left as the result of removing existing guardrail and guard posts with dry sand; temporary pollution and erosion control; disposal of excess, waste materials, and debris; and final dressing, cleanup, and seeding and protection. Perform all site preparation as approved or directed by the engineer.

- C. Guardrail.** Except as specified herein, construct guardrail system according to Section 719 and the Standard and Sepia Drawings, current editions. Locations listed on the summary and/or shown on the drawings are approximate only. The Engineer will determine the exact termini for individual guardrail installations at the time of construction. Unless directed otherwise by the Engineer, provide a minimum two (2) foot shoulder width. Construct radii at entrances and road intersections as directed by the Engineer.

Erect guardrail to the lines and grades shown on the current Standard and Sepia Drawings, or as directed by the Engineer by any method approved by the Engineer which allows construction of the guardrail to the true grade without apparent sags.

When removing existing guardrail and installing new guardrail, do not leave the blunt end exposed where it would be hazardous to the public. When it is not practical to complete the construction of the guardrail and the permanent end treatments and terminal sections first, provide a temporary end by connecting at least 25 feet of rail to the last post, and by slightly flaring, and burying the end of the rail completely into the existing shoulder. If left overnight, place a drum with bridge panel in advance of the guardrail end and maintain during use.

- D. Delineators for Guardrail.** Construct Delineators for Guardrail according to Standard Drawing RBR-055 – Delineators for Guardrail, current edition.
- E. Property Damage.** Be responsible for all damage to public and/or private property resulting from the work. Restore damaged roadway features and private property at no additional cost to the Department.
- F. Coordination with Utility Companies.** Locate all underground, above ground, and overhead utilities prior to beginning construction. Be responsible for contacting and maintaining liaison with all utility companies that have utilities located within the project limits. Do not disturb existing overhead or underground utilities. It is not anticipated that any utility facilities will need to be relocated and/or adjusted; however, in the event that it is discovered that the work does require utilities to be relocated and/or adjusted, the utility companies will work concurrently with the Contractor while relocating their facilities. Be responsible for repairing all utility damage that occurs as a result of guardrail operations at no additional cost to the Department.
- G. Right of Way Limits.** The Department has not established the exact limits of the Right-of-Way. Limit work activities to obvious Right-of-Way, permanent or temporary easements, and work areas secured by the Department through consent and release of the adjacent property owners. Be responsible for all encroachments onto private lands.

Guardrail
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- H. Clean Up, Disposal of Waste.** Dispose of all removed concrete, debris, and other waste and debris off the Right-of-Way at sites obtained by the Contractor at no additional cost to the Department. See the Special Provision for Waste and Borrow Sites.
- I. Final Dressing, Seeding and Protection.** Apply Class A Final Dressing to all disturbed areas, both on and off the Right-of-Way. Sow all disturbed earthen areas with the applicable seed mixture(s) according to Section 212.03.03.
- J. Erosion Control.** See the Special Note for Erosion Control.

IV. METHOD OF MEASUREMENT

- A. Maintain and Control Traffic.** See Traffic Control Plan.
- B. Site preparation.** Other than the bid items listed, the Department will not measure Site Preparation for separate payment but shall be incidental to the Guardrail, End Treatments, Bridge End Connectors, and Terminal Sections, as applicable.
- C. Guardrail, End Treatments, Bridge End Connectors, Terminal Sections, and Remove Guardrail.** The Department will measure according to Section 719.04.
- D. Delineators for Guardrail.** See Standard Drawing RBR-055 – Delineators for Guardrail.
- E. Clean Up, Disposal of Waste, Final Dressing, and Seeding and Protection.** The Department will NOT measure for payment the operations of: Clean Up, Disposal of Waste, and Final Dressing. These activities shall be incidental. Seeding and Protection will be measured according to Section 212.
- F. Erosion Control.** See the Special Note for Erosion Control.

V. BASIS OF PAYMENT

- A. Maintain and Control Traffic.** See Traffic Control Plan.
- B. Guardrail, End Treatments, Bridge End Connectors, Terminal Sections, and Remove Guardrail.** The Department will make payment according to Section 719.05.
- C. Delineators for Guardrail.** See Standard Drawing RBR-055 – Delineators for Guardrail.
- D. Erosion Control.** See the Special Note for Erosion Control.

**SPECIAL NOTE FOR
ASPHALT MILLING AND TEXTURING**

Begin paving operations within **48 hours** of commencement of the milling operation. Continue paving operations continuously until completed. If paving operations are not begun within this time period, the Department will assess liquidated damages at the rate prescribed by Section 108.09 until such time as paving operations are begun.

Take possession of the millings and recycle the millings or dispose of the millings off the Right-of-Way at sites obtained by the Contractor at no additional cost to the Department.

1-3520 48 hours Contractor keeps millings
01/2/2012

SPECIAL NOTE FOR TYPICAL SECTION DIMENSIONS

Consider the dimensions shown on the typical sections for pavement and shoulder widths and thickness' to be nominal or typical dimensions. The Engineer may direct or approve varying the actual dimensions to be constructed to fit existing conditions. Do not widen existing pavement or shoulders unless specified elsewhere in this proposal or directed by the engineer.

1-3725 Typical Section Dimensions
01/02/2012

SPECIAL NOTE FOR SIDEWALK RAMPS & DETECTABLE WARNINGS

GENERAL

Unless otherwise stated in the contract, or as directed by or with prior approval from the Engineer, construct Sidewalk Ramps and Detectable Warnings in accordance with Sections 505 and 720; Supplemental Specifications; Standard Drawings RGX-040-03, RPM-150-08, RPM-152-08, RPM-170-09, and RPM-172-07; current editions, as applicable. In lieu of the Detectable Warnings shown on Standard Drawing RGX-040-03, the Department will also allow the use of any Detectable Warnings listed as Phase XI on the [Kentucky Product Evaluation List](http://www.ktc.uky.edu/kytc/kypel/allevvaluations.php) (<http://www.ktc.uky.edu/kytc/kypel/allevvaluations.php>). For Detectable Warnings as shown on Standard Drawing RGX-040-03, saw cut existing sidewalks, curb and gutter, and pavement, if present, as shown on the detail and reconstruct sidewalk ramps with detectable warnings as directed or approved by the Engineer. For Detectable Warnings from the Kentucky Product Evaluation List, install according to the manufacturer's recommendations. Unless specified otherwise in the Contract, construct sidewalk with 4" nominal minimum required thickness; however, if the existing sidewalk thickness is found to be greater or less than the thickness specified, transition the thickness as directed by the Engineer.

Except as required by the work, do not disturb drainage pipe, catch basins, and other roadway features, appurtenances and installations. Restore any roadway features, appurtenances, and installations damaged by the work in like kind materials and design at no additional cost to the Department. Dispose of all waste off the right of way at sites obtained by the Contractor at no additional cost to the Department (see Special Note for Waste and Borrow).

MEASUREMENT & PAYMENT

SIDEWALK RAMPS – The Department will measure Sidewalk Ramps in accordance with Section 505.04.01 and Standard Drawing RPM-170-09, current editions; however, contrary to Sections 505.04.05 and 505.04.06, the Department will not measure Roadway Excavation or Embankment in Place, but shall be incidental to the Sidewalk. Accept payment at the Contract unit price per square yard as full compensation for all labor, materials, equipment, and incidentals required for removal and disposal of existing sidewalk and curb and gutter, excavation and embankment, construction of the sidewalk ramps, reconstruction of the adjacent curb and/or sidewalk as necessary to install the sidewalk ramps, and restoration of disturbed features in accordance with these notes or as directed by the Engineer.

DETECTABLE WARNINGS – The Department will measure Detectable Warnings in accordance with Section 505.04.04 and Standard Drawings RGX-040-03 and RPM-170-09, current editions. The Department will make payment according to Section 505.05.

HANDRAIL – The Department will measure and make payment for Handrail in accordance with Section 720.05 and Standard Drawing RPM-172-07, current editions.

**TRAFFIC CONTROL PLAN
HARDIN COUNTY
US 31W INTERSECTION IMPROVEMENTS
ITEM No. 4-9008.40**

TRAFFIC CONTROL GENERAL

Except as provided herein, traffic shall be maintained in accordance with the current editions of the Manual on Uniform Traffic Control Devices (MUTCD), Standard Specifications, and the Standard and Sepia Drawings. Except for the roadway and traffic control bid items listed, all items of work necessary to maintain and control traffic will be paid at the lump sum bid price to "Maintain and Control Traffic".

Contrary to Section 106.01, traffic control devices used on this project may be new, or used in like new condition, at the beginning of the work and maintained in like new condition until completion of the work. Any temporary traffic control items, devices, materials, and incidentals shall remain the property of the contractor unless otherwise addressed, when no longer needed.

TRAFFIC MANAGEMENT PLAN

Due to the combined high volume of traffic and anticipated length of time for construction, a Transportation Management Plan (TMP) must be developed and submitted for review and approval at least one week prior to the beginning of any construction activity. This plan will include a Public Information Plan (PIP) and a Temporary Traffic Control Plan (TTCP). The PIP shall identify communication strategies that will be used to inform the affected road users, the general public, area residences and businesses and appropriate public entities about the work zone traffic control measures for the project and permanent traffic flow changes. The TTCP should include but not be limited to maintenance of traffic procedures and signage, flagging and traffic control personnel and equipment, construction equipment to be used on and around the roadway, passage or restriction of wide loads, and safety of traffic and construction personnel.

PROJECT PHASING & CONSTRUCTION PROCEDURES

US31W @ Blackjack Road

1. Before construction begins, communicate with roadway users and stakeholders of upcoming changes to traffic patterns, as outlined in the PIP.
2. Construct the north and south U-Turn Lane and U-Turn.
3. Construct the right turn lanes.
4. Close intersection and construct median barrier and associated drainage.
5. Complete permanent striping.

US31W @ KY434

1. Before construction begins, communicate with roadway users and stakeholders of upcoming changes to traffic patterns, as outlined in the PIP.
2. Construct the north and south loons and associated entrances and drainage.
3. Construct the north and south U-Turn Lane and U-Turn.

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4. Construct southbound right turn lane and Wilson Road Connector
5. Close intersection and construct median barrier and associated drainage.
6. Complete permanent striping.

US31W @ KY220

1. Before construction begins, communicate with roadway users and stakeholders of upcoming changes to traffic patterns, as outlined in the PIP.
2. Construct the south loon and associated entrance and drainage.
3. Construct the north and south U-Turn Lane and U-Turn.
4. Construct southbound right turn lane.
5. Close intersection and construct median barrier and associated drainage.
6. Complete permanent striping.

No through-lane closures will be allowed during the following days and/or hours:

Normal Workday Rush Hours

Monday – Friday 6:00 am to 9:00 am and 3:00 pm to 6:00 pm

Holidays and Special Events

Labor Day Weekend

Friday, August 30, 2019 – Monday, September 2, 2019

At the discretion of the Engineer, additional days and hours may be specified when lane closures will not be allowed due to unforeseen events.

LANES CLOSURES

US 31W Through-Lanes

The Contractor shall maintain two lanes of travel in each direction with a minimum lane width of 10 feet. However, during working hours and with approval of the Engineer, the Contractor may reduce the through-lanes to one lane of traffic in each direction, provided adequate signing and flag persons are in place. When maintaining one-lane of traffic in each direction provide a minimum clear lane width of 10 feet; however, provide for the passage of vehicles of up to 16 feet in width. Through-lane closures may not be combined with left turn lane closures at intersections.

North and South U-Turn Lane and U-Turn

For the U-Turn Lanes and U-Turns north and south of the intersections, the median or left turn lane may be continuously closed. However, that closure may not last more than 5 days, at which point the proposed left turn bays and U-turn locations shall be opened to traffic.

Left Turn and Median at the Intersection

For the intersection work, the median or left turn lane may be continuously closed. However, that closure may not last more than 10 days, at which point the intersection shall be opened to traffic. Signal phasing and signal head location shall be coordinated with the Engineer and the District Traffic Engineer before those lane closures are allowed.

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Approaches and Side Roads

Two-lane approaches and side roads may be reduced to one lane during working hours provided adequate signing and flaggers are in place, and with prior approval from the Engineer. Where signalized, coordination with the Engineer and District Traffic Engineer shall be done prior to any lane closures. Consideration shall also be given to mainline lane closures and pedestrian traffic when traffic patterns at approaches and side roads are altered.

Additional Lane Closure and Traffic Impact Restrictions

If traffic should be stopped due to construction operations, and a school bus or emergency vehicle on an official run arrives on the scene, make provisions for the passage of the school bus or emergency vehicle as quickly as possible.

When the road is open to through traffic, do not leave lane closures in place during non-working hours. Maintain lane closures only during hours of actual operations. Reduce lane closures to a shoulder closure, or remove as appropriate, when active operations do not require a lane closure. The Engineer will permit shoulder closures during non-working hours; however do not park equipment or store materials on a closed shoulder during non-working hours. The Engineer may designate days and hours when lane and/or shoulder closures will not be allowed.

Contrary to Section 112.04.17, lane closures, whether long term or short term, will not be measured for payment and will be incidental to the bid item "Maintain and Control Traffic".

TEMPORARY SIGNS

The Engineer and the Contractor, or their authorized representative, shall review the signing before traffic is allowed to use any lane closures, crossovers, or detours. All signing shall be approved by the Engineer before work can be started by the Contractor.

Sign posts and splices shall be compliant with NCHRP 350 or MASH. Manufacturer's documentation validating this compliance shall be provided to the Engineer prior to installation. Signs, including any splices, shall be installed according to manufacturer's specifications and installation recommendations. Contrary to section 112.04.02, only long-term signs (signs intended to be continuously in place for more than 3 days) will be measured for payment. Short-term signs (signs intended to be left in place for 3 days or less) will not be measured for payment but will be incidental to Maintain and Control Traffic.

In general, all traffic control devices shall be placed starting and proceeding in the direction of the flow of traffic, and removed starting and proceeding in the direction opposite the flow of traffic.

The Contractor shall completely cover any signs, existing, permanent, or temporary, which do not properly apply to the current traffic phasing, and shall maintain the covering until signs are applicable or are removed.

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PORTABLE CHANGEABLE MESSAGE SIGNS

Provide changeable message signs at locations determined by the Engineer. The Engineer may vary the designated locations as the work progresses. The Engineer will determine the messages to be displayed. In the event of damage or mechanical/electrical failure, repair or replace the Changeable Message Sign within 24 hours. The Department will measure for payment the maximum number of Changeable Message Signs in concurrent use at the same time on a single day on all sections of the contract. The Department will measure individual Changeable Message Signs only once for payment, regardless of how many times they are set, reset, removed, and relocated during the duration of the project. The Department will not measure for payment any replacements for damaged Changeable Message Signs or any changeable message signs the Engineer directs to be replaced due to poor condition or readability. Retain possession of the Changeable Message Signs upon completion of the work.

BARRICADES

The Department will not measure barricades used in lieu of barrels and cones for channelization or delineation, but shall be incidental to Maintain and Control Traffic according to Section 112.04.01.

The Department will measure barricades used for road closures and to protect pavement removal areas in individual units Each. The Department will measure for payment the maximum number of barricades in concurrent use at the same time on a single day on all sections of the contract. The Department will measure individual barricades only once for payment, regardless of how many times they are set, reset, removed, and relocated during the duration of the project. The Department will not measure for payment any replacements for damaged barricades, or any barricades the Engineer directs to be replaced due to poor condition or reflectivity. Retain possession of the Barricades upon completion of construction.

TEMPORARY ENTRANCES

The Engineer will not require the Contractor to provide continuous access to farms, single family, duplex, or triplex residential properties during working hours. However reasonable egress and ingress must be provided to each such property when actual operations are not in progress at that location. Limit the time during which a residential or farm entrance is blocked to the minimum length of time required for actual operations. Do not extend the time for the Contractor's convenience, and in no case will the blockage be allowed to exceed six (6) hours. Notify all residents twenty-four hours in advance of any driveway or entrance closings and make any accommodations necessary to meet the access needs of elderly or disabled residents.

Except where allowed by the Engineer, maintain direct access to all side roads and streets, schools, churches, commercial properties, and apartments or apartment complexes of four or more units at all times.

The Department will measure asphalt materials required to construct and maintain any temporary entrances which may be needed to provide access. However the Department will not measure aggregates, excavation and/or embankment; these items shall be incidental to the bid item Maintain and Control Traffic. The Engineer will determine the type of surfacing material to be used at each entrance.

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PAVEMENT MARKINGS

Removal of Existing Permanent Markings

Markings shall be removed by either an abrasive or burning process to the satisfaction of the Engineer. If the abrasive method is used, the area affected is to be coated with black (or more precisely a color similar to that of the adjacent pavement surface) traffic paint. Painting of existing markings with bituminous or other materials to obliterate the markings shall not be allowed.

Temporary and Permanent Striping and Markings

If there is to be a deviation from the striping plan, the Engineer will furnish the Contractor with an updated plan. Place temporary and permanent striping in accordance with Section 112 with the following exceptions:

- Place temporary or permanent traffic striping before opening a lane to traffic.
- If the Contractor's operations or phasing requires temporary markings that must subsequently be removed, use an approved removable lane tape; however, the Department will not measure removable lane tape for separate payment, and any use should be included in the lump sum bid item for Maintain and Control Traffic.

PAVEMENT EDGE DROP-OFFS

Do not allow a pavement edge between opposing directions of traffic or lanes that is expected to cross in a lane change situation with an elevation difference greater than 1 ½". Place Warning signs (MUTCD W8-11 or W8-9A) in advance of and at 1500' intervals throughout the drop-off area. Dual post the signs on both sides of the traveled way. Wedge all transverse transitions between resurfaced and unsurfaced areas which traffic may cross with asphalt mixture for leveling and wedging. Remove the wedges prior to placement of the final surface course.

Protect pavement edges that traffic is not expected to cross, except accidentally, as follows:

- Less than 2" – Not protection required. Warning signs should be placed in advance and throughout the drop-off area.
- 2" to 4" - Place plastic drums, vertical panels, or barricades every 50 feet. During daylight working hours only, the Engineer will allow the Contractor to use cones in lieu of plastic drums, panels, and barricades. Wedge the drop-off with DGA or asphalt mixture for leveling and wedging with a 1:1 or flatter slope in daylight hours, or 3:1 or flatter slope during nighttime hours, when work is not active in the drop-off area.
- Greater than 4" - Protect drop-offs greater than 4 inches within 10 feet of traffic by placing drums, vertical panels, or barricades every 25 feet. The Engineer will not allow the use of cones in lieu of drums, vertical panels, or barricades for drop-offs greater than 4". Place Type III Barricades directly in front of the drop-off facing oncoming traffic in both directions of travel. Provide warning signs as shown on the Standard Drawings or as directed by the Engineer
- Pedestrians & Bicycles - Protect pedestrian and bicycle traffic as directed by the Engineer.

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ARROW PANELS

Use arrow panels as shown on the Standard Drawings or as directed by the Engineer. The Department will measure for payment the maximum number of arrow panels in concurrent use at the same time on a single day on all sections of the contract. The Department will measure individual arrow panels only once for payment, regardless of how many times they are set, reset, removed, and/or relocated during the duration of the project. The Department will not measure for payment any replacements for damaged arrow panels or for arrow panels the Engineer directs to be replaced due to poor condition or readability. The Contractor will retain possession of the arrow panels upon completion of the work.

COORDINATION OF WORK

The Contractor is advised that other projects will be in progress within or in the near vicinity of this project. The traffic control of those projects may affect this project and the traffic control of this project may affect those projects. The Contractor will coordinate the work on this project with the work of the other contractors. In case of conflict, the Engineer will determine the relative priority to give to work phasing on the various projects.

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USE AND PLACEMENT OF CHANGEABLE MESSAGE SIGNS

The following policy is based upon current Changeable Message Signs (CMS) standards and practice from many sources, including the Federal Highway Administration (FHWA), other State Departments of Transportation, and Traffic Safety Associations. It is understood that each CMS installation or use requires individual consideration due to the specific location or purpose. However, there will be elements that are constant in nearly all applications. Accordingly these recommended guidelines bring a level of uniformity, while still being open to regional experience and engineering judgment.

Application

The primary purpose of CMS is to advise the driver of unexpected traffic and routing situations. Examples of applications where CMS can be effective include:

- Closures (road, lane, bridge, ramp, shoulder, interstate)
- Changes in alignment or surface conditions
- Significant delays, congestion
- Construction/maintenance activities (delays, future activities)
- Detours/alternative routes
- Special events with traffic and safety implications
- Crash/incidents
- Vehicle restrictions (width, height, weight, flammable)
- Advance notice of new traffic control devices
- Real-time traffic conditions (must be kept up to date)
- Weather /driving conditions, environmental conditions, Roadway Weather Information Systems
- Emergency Situations
- Referral to Highway Advisory Radio (if available)
- Messages as approved by the County Engineer's Office

CMS should not be used for:

- Replacement of static signs (e.g. road work ahead), regulatory signage (e.g. speed limits), pavement markings, standard traffic control devices, conventional warning or guide signs.
- Replacement of lighted arrow board
- Advertising (Don't advertise the event unless clarifying "action" to be taken by driver – e.g. Speedway traffic next exit)
- Generic messages
- Test messages (portable signs only)
- Describe recurrent congestion (e.g. rush hour)
- Public service announcements (not traffic related)

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Messages

Basic principles that are important to providing proper messages and insuring the proper operation of a CMS are:

- Visible for at least ½ mile under ideal daytime and nighttime conditions
- Legible from all lanes a minimum of 650 feet
- Entire message readable twice while traveling at the posted speed
- No more than two message panels should be used (three panels may be used on roadways where vehicles are traveling less than 45 mph). A panel is the message that fits on the face of the sign without flipping or scrolling.
- Each panel should convey a single thought; short and concise
- Do not use two unrelated panels on a sign
- Do not use the sign for two unrelated messages
- Should not scroll text horizontally or vertically
- Should not contain both the words left and right
- Use standardized abbreviations and messages
- Should be accurate and timely
- Avoid filler/unnecessary words and periods (hazardous, a, an, the)
- Avoid use of speed limits
- Use words (not numbers) for dates

Placement

Placement of the CMS is important to insure that the sign is visible to the driver and provides ample time to take any necessary action. Some of the following principles may only be applicable to controlled access roadways. The basic principles of placement for a CMS are:

- When 2 signs are needed, place on same side of roadway and at least 1,000 feet apart
- Place behind semi-rigid/rigid protection (guardrail, barrier) or outside of the clear zone
- Place 1,000 feet in advance of work zone; at least one mile ahead of decision point
- Normally place on right side of roadway; but should be placed closest to the affected lane so that either side is acceptable
- Signs should not be dual mounted (one on each side of roadway facing same direction)
- Point trailer hitch downstream
- Secure to immovable object to prevent theft (if necessary)
- Do not place in sags or just beyond crest
- Check for reflection of sun to prevent the blinding of motorist
- Should be turned ~3 degrees outward from perpendicular to the edge of pavement
- Bottom of sign should be 7 feet above the elevation of edge of roadway
- Should be removed when not in use

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Standard Abbreviations

The following is a list of standard abbreviations to be used on CMS:

<u>Word</u>	<u>Abbrev</u>	<u>Example</u>
Access	ACCS	ACCIDENT AHEAD/ USE ACCS RD NEXT RIGHT
Alternate	ALT	ACCIDENT AHEAD/ USE ALT RTE NEXT RIGHT
Avenue	AVE	FIFTH AVE CLOSED/ DETOUR NEXT LEFT
Blocked	BLKD	FIFTH AVE BLKD/ MERGE LEFT
Boulevard	BLVD	MAIN BLVD CLOSED/ USE ALT RTE
Bridge	BRDG	SMITH BRDG CLOSED/ USE ALT RTE
Cardinal Directions	N, S, E, W	N I75 CLOSED/ DETOUR EXIT 30
Center	CNTR	CNTR LANE CLOSED/ MERGE LEFT
Commercial	COMM	OVRSZ COMM VEH/ USE I275
Condition	COND	ICY COND POSSIBLE
Congested	CONG	HVY CONG NEXT 3 MI
Construction	CONST	CONST WORK AHEAD/ EXPECT DELAYS
Downtown	DWNTN	DWNTN TRAF USE EX 40
Eastbound	E-BND	E-BND I64 CLOSED/ DETOUR EXIT 20
Emergency	EMER	EMER VEH AHEAD/ PREPARE TO STOP
Entrance, Enter	EX, EXT	DWNTN TRAF USE EX 40
Expressway	EXPWY	WTRSN EXPWY CLOSED/ DETOUR EXIT 10
Freeway	FRWY, FWY	GN SYNDR FWY CLOSED/ DETOUR EXIT 15
Hazardous Materials	HAZMAT	HAZMAT IN ROADWAY/ ALL TRAF EXIT 25
Highway	HWY	ACCIDENT ON AA HWY/ EXPECT DELAYS
Hour	HR	ACCIDENT ON AA HWY/ 2 HR DELAY
Information	INFO	TRAF INFO TUNE TO 1240 AM
Interstate	I	E-BND I64 CLOSED/ DETOUR EXIT 20
Lane	LN	LN CLOSED MERGE LEFT
Left	LFT	LANE CLOSED MERGE LFT
Local	LOC	LOC TRAF USE ALT RTE
Maintenance	MAINT	MAINT WRK ON BRDG/ SLOW
Major	MAJ	MAJ DELAYS I75/ USE ALT RTE
Mile	MI	ACCIDENT 3 MI AHEAD/ USE ALT RTE
Minor	MNR	ACCIDENT 3 MI MNR DELAY
Minutes	MIN	ACCIDENT 3 MI/ 30 MIN DELAY
Northbound	N-BND	N-BND I75 CLOSED/ DETOUR EXIT 50
Oversized	OVRSZ	OVRSZ COMM VEH/ USE I275 NEXT RIGHT
Parking	PKING	EVENT PKING NEXT RGT
Parkway	PKWY	CUM PKWAY TRAF/ DETOUR EXIT 60
Prepare	PREP	ACCIDENT 3 MI/ PREP TO STOP
Right	RGT	EVENT PKING NEXT RGT
Road	RD	HAZMAT IN RD/ ALL TRAF EXIT 25
Roadwork	RDWK	RDWK NEXT 4 MI/ POSSIBLE DELAYS
Route	RTE	MAJ DELAYS I75/ USE ALT RTE
Shoulder	SHLDR	SHLDR CLOSED NEXT 5 MI
Slippery	SLIP	SLIP COND POSSIBLE/ SLOW SPD
Southbound	S-BND	S-BND I75 CLOSED/ DETOUR EXIT 50
Speed	SPD	SLIP COND POSSIBLE/ SLOW SPD

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Standard Abbreviations (cont)

<u>Word</u>	<u>Abbrev</u>	<u>Example</u>
Street	ST	MAIN ST CLOSED/ USE ALT RTE
Traffic	TRAF	CUM PKWAY TRAF/ DETOUR EXIT 60
Vehicle	VEH	OVRSZ COMM VEH/ USE I275 NEXT RIGHT
Westbound	W-BND	W-BND I64 CLOSED/ DETOUR EXIT 50
Work	WRK	CONST WRK 2MI/ POSSIBLE DELAYS

Certain abbreviations are prone to inviting confusion because another word is abbreviated or could be abbreviated in the same way. DO NO USE THESE ABBREVIATIONS:

<u>Abbrev</u>	<u>Intended Word</u>	<u>Word Erroneously Given</u>
ACC	Accident	Access (Road)
CLRS	Clears	Colors
DLY	Delay	Daily
FDR	Feeder	Federal
L	Left	Lane (merge)
LOC	Local	Location
LT	Light (traffic)	Left
PARK	Parking	Park
POLL	Pollution (index)	Poll
RED	Reduce	Red
STAD	Stadium	Standard
TEMP	Temporary	Temperature
WRNG	Warning	Wrong

Typical Messages

The following is a list of typical messages used on CMS. The list consists of the reason or problem that you want the driver to be aware of and the action that you want the driver to take.

<u>Reason/Problem</u>	<u>Action</u>
ACCIDENT	ALL TRAFFIC EXIT RT
ACCIDENT/XX MILES	AVOID DELAY USE XX
XX ROAD CLOSED	CONSIDER ALT ROUTE
XX EXIT CLOSED	DETOUR
BRIDGE CLOSED	DETOUR XX MILES
BRIDGE/(SLIPPERY, ICE, ETC.)	DO NOT PASS
CENTER/LANE/CLOSED	EXPECT DELAYS
DELAY(S), MAJOR/DELAYS	FOLLOW ALT ROUTE
DEBRIS AHEAD	KEEP LEFT
DENSE FOG	KEEP RIGHT
DISABLED/VEHICLE	MERGE XX MILES
EMER/VEHICLES/ONLY	MERGE LEFT
EVENT PARKING	MERGE RIGHT
EXIT XX CLOSED	ONE-WAY TRAFFIC
FLAGGER XX MILES	PASS TO LEFT
FOG XX MILES	PASS TO RIGHT

Traffic Control Plan
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Typical Messages (cont)

Reason/Problem

FREEWAY CLOSED
FRESH OIL
HAZMAT SPILL
ICE
INCIDENT AHEAD
LANES (NARROW, SHIFT, MERGE, ETC.)
LEFT LANE CLOSED
LEFT LANE NARROWS
LEFT 2 LANES CLOSED
LEFT SHOULDER CLOSED
LOOSE GRAVEL
MEDIAN WORK XX MILES
MOVING WORK ZONE, WORKERS IN ROADWAY
NEXT EXIT CLOSED
NO OVERSIZED LOADS
NO PASSING
NO SHOULDER
ONE LANE BRIDGE
PEOPLE CROSSING
RAMP CLOSED
RAMP (SLIPPERY, ICE, ETC.)
RIGHT LANE CLOSED
RIGHT LANE NARROWS
RIGHT SHOULDER CLOSED
ROAD CLOSED
ROAD CLOSED XX MILES
ROAD (SLIPPERY, ICE, ETC.)
ROAD WORK
ROAD WORK (OR CONSTRUCTION) (TONIGHT, TODAY, TOMORROW, DATE)
ROAD WORK XX MILES
SHOULDER (SLIPPERY, ICE, SOFT, BLOCKED, ETC.)
NEW SIGNAL XX MILES
SLOW 1 (OR 2) - WAY TRAFFIC
SOFT SHOULDER
STALLED VEHICLES AHEAD
TRAFFIC BACKUP
TRAFFIC SLOWS
TRUCK CROSSING
TRUCKS ENTERING
TOW TRUCK AHEAD
UNEVEN LANES
WATER ON ROAD
WET PAINT
WORK ZONE XX MILES
WORKERS AHEAD

Action

PREPARE TO STOP
REDUCE SPEED
SLOW
SLOW DOWN
STAY IN LANE
STOP AHEAD
STOP XX MILES
TUNE RADIO 1610 AM
USE NN ROAD
USE CENTER LANE
USE DETOUR ROUTE
USE LEFT TURN LANE
USE NEXT EXIT
USE RIGHT LANE
WATCH FOR FLAGGER

DURABLE PAVEMENT EDGE DETAIL


(Resurfacing adjacent to fill slope or ditch foreslope that is 3:1 or less)



PREPARE SHOULDER ACCORDING TO STANDARD SPECIFICATIONS


DURABLE PAVEMENT EDGE DETAIL

(Resurfacing adjacent to fill slope or ditch foreslope that is steeper than 3:1)

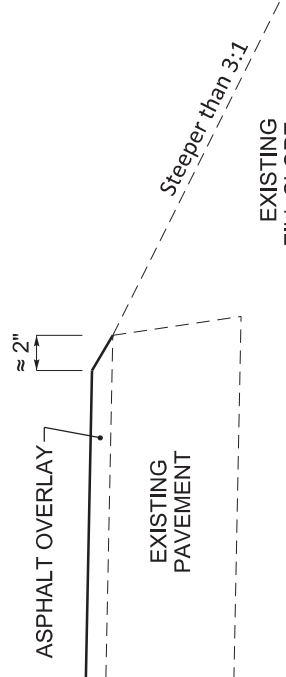


DURABLE PAVEMENT EDGE DETAIL

(Resurfacing adjacent to low shoulder with dropoff of 5 inches or less)

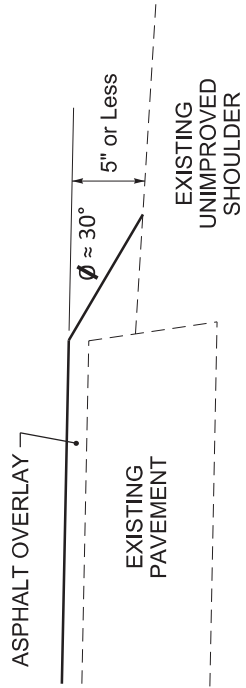

DURABLE PAVEMENT EDGE DETAIL

(Resurfacing adjacent to low shoulder with dropoff of more than 5 inches)

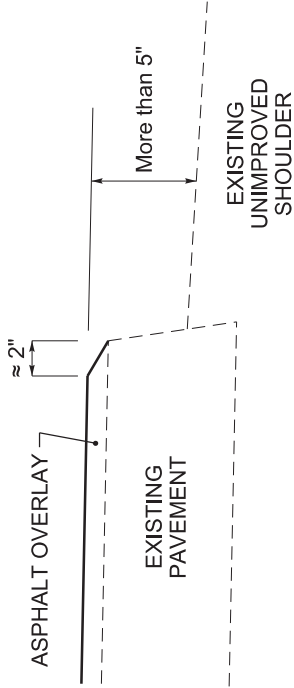

DURABLE PAVEMENT EDGE DETAIL

(Resurfacing adjacent to an obstruction, such as an existing headwall)



NOTES

1. DETAILS DO NOT APPLY TO OVERLAYS LESS THAN 1 INCH THICK.
2. THE DURABLE PAVEMENT EDGE DEVICE MAY BE DISENGAGED AT DRIVEWAYS, SIDE STREETS, HIGH SHOULDERS, AND OTHER LOCATIONS NOT FEASIBLE TO CONSTRUCT, AS APPROVED BY THE ENGINEER.

DRAWING NOT TO SCALE

DURABLE PAVEMENT EDGE DETAILS



KENTUCKY TRANSPORTATION CABINET
Department of Highways
DIVISION OF RIGHT OF WAY & UTILITIES

RIGHT OF WAY CERTIFICATION

TC 62-226
Rev. 01/2016
Page 1 of 1

<input checked="" type="checkbox"/>	Original	<input type="checkbox"/>	Re-Certification	RIGHT OF WAY CERTIFICATION			
ITEM #		COUNTY		PROJECT # (STATE)		PROJECT # (FEDERAL)	
04-9008.4		Hardin		FD52 C047 93791 01R		HSIP 0311 040	
PROJECT DESCRIPTION							
INTERSECTION AND CORRIDOR IMPROVEMENTS TO REDUCE CONFLICT POINTS AND ENHANCE SAFETY & CAPACITY ALONG US 31W FROM FIRST ST TO KY 1500. (2016BOP)							
<input type="checkbox"/> No Additional Right of Way Required							
Construction will be within the limits of the existing right of way. The right of way was acquired in accordance to FHWA regulations under the Uniform Relocation Assistance and Real Property Acquisitions Policy Act of 1970, as amended. No additional right of way or relocation assistance were required for this project.							
<input checked="" type="checkbox"/> Condition # 1 (Additional Right of Way Required and Cleared)							
All necessary right of way, including control of access rights when applicable, have been acquired including legal and physical possession. Trial or appeal of cases may be pending in court but legal possession has been obtained. There may be some improvements remaining on the right-of-way, but all occupants have vacated the lands and improvements, and KYTC has physical possession and the rights to remove, salvage, or demolish all improvements and enter on all land. Just Compensation has been paid or deposited with the court. All relocations have been relocated to decent, safe, and sanitary housing or that KYTC has made available to displaced persons adequate replacement housing in accordance with the provisions of the current FHWA directive.							
<input type="checkbox"/> Condition # 2 (Additional Right of Way Required with Exception)							
The right of way has not been fully acquired, the right to occupy and to use all rights-of-way required for the proper execution of the project has been acquired. Some parcels may be pending in court and on other parcels full legal possession has not been obtained, but right of entry has been obtained, the occupants of all lands and improvements have vacated, and KYTC has physical possession and right to remove, salvage, or demolish all improvements. Just Compensation has been paid or deposited with the court for most parcels. Just Compensation for all pending parcels will be paid or deposited with the court prior to AWARD of construction contract							
<input type="checkbox"/> Condition # 3 (Additional Right of Way Required with Exception)							
The acquisition or right of occupancy and use of a few remaining parcels are not complete and/or some parcels still have occupants. All remaining occupants have had replacement housing made available to them in accordance with 49 CFR 24.204. KYTC is hereby requesting authorization to advertise this project for bids and to proceed with bid letting even though the necessary right of way will not be fully acquired, and/or some occupants will not be relocated, and/or the just compensation will not be paid or deposited with the court for some parcels until after bid letting. KYTC will fully meet all the requirements outlined in 23 CFR 635.309(c)(3) and 49 CFR 24.102(j) and will expedite completion of all acquisitions, relocations, and full payments after bid letting and prior to AWARD of the construction contract or force account construction.							
Total Number of Parcels on Project		1	EXCEPTION (S) Parcel #		ANTICIPATED DATE OF POSSESSION WITH EXPLANATION		
Number of Parcels That Have Been Acquired							
Signed Deed		1					
Condemnation							
Signed ROE							
Notes/ Comments (Use Additional Sheet if necessary)							
LPA RW Project Manager				Right of Way Supervisor			
Printed Name				Printed Name		Michael H. Price	
Signature				Signature		<i>Michael H. Price</i> 2019.04.02 10:56:00 -04'00'	
Date				Date		04/02/2019	
Right of Way Director				FHWA			
Printed Name				Printed Name		No Signature Required	
Signature				Signature		as per FHWA-KYTC	
Date		<i>[Signature]</i> 2019.04.03		Date		Current Stewardship Agreement	
		09:21:45 -05'00'					

UTILITIES AND RAIL CERTIFICATION NOTE

Hardin County – HSIP 0311 (040)
FD52 047 031W 018-027
Item No. 4-9008.40

GENERAL PROJECT NOTE ON UTILITY PROTECTION

Utility coordination efforts determined that no significant utility relocation work is required to complete the project. Any work pertaining to these utility facilities is defined in the bid package and is to be carried out as instructed by the Kentucky Transportation Cabinet. The contractor will be responsible for any coordination or adjustments that are discussed or quantified in the proposal.

NOTE: DO NOT DISTURB THE FOLLOWING UTILITIES LOCATED WITHIN THE PROJECT DISTURB LIMITS

The following utility facilities are present and are not to be disturbed during construction activities.

- **Utility Pole**
All Utility Poles, including those located at US 31W Sta. 1184+46 (84.34 RT), Sta. 1276+34 (88.10 LT), Sta. 1369+13 (62.96 RT), Sta. 1372+17 (75.02 RT).
- **Various Water Mains**
Various water mains located on both left and right sides throughout the project limits.
- **Various Gas Mains**
Various gas mains located on both left and right sides throughout the project limits.
- **Overhead Electric / Telephone**
Overhead electric/telephone is located on both left and right sides throughout project limits.
- **Windstream Underground Telephone Line**
Station 1183+00 RT to 1186+00 RT of the KY 220 intersection.
- **AT&T**
Has an underground fiberoptic line at approximate station 1274+70 offset 88' left that is encased in 4" pvc. There is also a dead copper line in this vicinity that belonged to AT&T.

The Contractor is fully responsible for protection of all utilities listed above

THE FOLLOWING COMPANIES ARE RELOCATING/ADJUSTING THEIR UTILITIES WITHIN THE PROJECT LIMITS AND WILL BE COMPLETE PRIOR TO CONSTRUCTION

N/A

THE FOLLOWING COMPANIES HAVE FACILITIES TO BE RELOCATED/ADJUSTED BY THE COMPANY OR THE COMPANY'S SUBCONTRACTOR AND IS TO BE COORDINATED WITH THE ROAD CONTRACT

- **Hardin County Water District #2**
Has waterline relocation work from Station 1181+00 to 1190+00 at the KY 220 intersection.
Has waterline relocation work from Station 1256+00 RT to 1265+00 RT at the KY 434 intersection.
Waterline relocation work will be completed by September 15, 2019.
- **LG&E**
Has gasline relocation work at the Blackjack intersection and will be complete by 10/15/2019.

UTILITIES AND RAIL CERTIFICATION NOTE

Hardin County – HSIP 0311 (040)
FD52 047 031W 018-027
Item No. 4-9008.40

THE FOLLOWING COMPANIES HAVE FACILITIES TO BE RELOCATED/ADJUSTED BY THE ROAD CONTRACTOR AS INCLUDED IN THIS CONTRACT

N/A

THE FOLLOWING RAIL COMPANIES HAVE FACILITIES IN CONJUNCTION WITH THIS PROJECT AS NOTED

No Rail Involved **Minimal Rail Involved (See Below)** **Rail Involved (See Below)**

UNDERGROUND FACILITY DAMAGE PROTECTION – BEFORE YOU DIG

The contractor shall make every effort to protect underground facilities from damage as prescribed in the Underground Facility Damage Protection Act of 1994, Kentucky Revised Statute KRS 367.4901 to 367.4917. It is the contractor’s responsibility to determine and take steps necessary to be in compliance with federal and state damage prevention directives. The contractor is instructed to contact KY 811 for the location of existing underground utilities. Contact shall be made a minimum of two (2) and no more than ten (10) business days prior to excavation.

The contractor shall submit Excavation Locate Requests to the Kentucky Contact Center (KY 811) via web ticket entry. The submission of this request does not relieve the contractor from the responsibility of contacting non-member facility owners, whom are to be contacted through their individual Protection Notification Center. It may be necessary for the contractor to contact the County Court Clerk to determine what utility companies have facilities in the area. Non-compliance with these directives can result in the enforcement of penalties.

SPECIAL CAUTION NOTE – PROTECTION OF UTILITIES

The contractor will be responsible for contacting all utility facility owners on the subject project to coordinate his activities. The contractor will coordinate his activities to minimize and, where possible, avoid conflicts with utility facilities. Due to the nature of the work proposed, it is unlikely to conflict with the existing utilities beyond minor facility adjustments. Where conflicts with utility facilities are unavoidable, the contractor will coordinate any necessary relocation work with the facility owner and Resident Engineer. The Kentucky Transportation Cabinet maintains the right to remove or alter portions of this contract if a utility conflict occurs.

UTILITIES AND RAIL CERTIFICATION NOTE

Hardin County – HSIP 0311 (040)
FD52 047 031W 018-027
Item No. 4-9008.40

The utility facilities as noted in the previous section(s) have been determined using data garnered by varied means and with varying degrees of accuracy: from the facility owners, a result of S.U.E., field inspections, and/or reviews of record drawings. The facilities defined may not be inclusive of all utilities in the project scope and are not Level A quality, unless specified as such. It is the contractor's responsibility to verify all utilities and their respective locations before excavating.

Please Note: The information presented in this Utility Note is informational in nature and the information contained herein is not guaranteed.

UTILITIES AND RAIL CERTIFICATION NOTE

Hardin County – HSIP 0311 (040)
FD52 047 031W 018-027
Item No. 4-9008.40

AREA UTILITIES CONTACT LIST

<u>Utility Company/Agency</u>	<u>Contact Name</u>	<u>Contact Information</u>
1. Hardin Co. Water #1	Justin Metz	1400 Rogersville Road Radcliff, KY 40160 270-351-3222 jmetz@hcwd.com
Windstream	Steve Johnson	130 W New Circle Rd. Lexington, KY 40505 859-357-6209 steve.johnson@windstream.com
Hardin Co. Water District #2	Forest Pollock	360 Ring Road Elizabethtown, KY 42701 270-373-1056 Ext 212 flpollock@hardincountywater2.org
2. Nolin Rural Electric Co-Op	Paul Baker	411 Ring Road Elizabethtown, KY 42701 270-765-6153 pbaker@nolinrecc.com
Comcast	Steve Gaddie	2919 Ring Road Elizabethtown, KY 42701 270-706-0326 stephen_gaddie@comcast.com
3. Kentucky Utilities	Brad Keown	242 W. Dixie Avenue Elizabethtown, KY 42701 502-333-6650 brad.keown@lge-ku.com
4. LG&E/KU	Caroline Justice	820 W. Broadway Louisville, KY 40202 502-627-3708 caroline.justice@lge-ku.com
5. Marathon Pipeline	Kevin Heath	klheath@marathonpetroleum.com
6. City of Elizabethtown Gas	Matt Hobbs	301 Waterworks Drive Elizabethtown, KY 42701 270-765-6121 Matthew.hobbs@elizabethtownky.gov

UTILITIES AND RAIL CERTIFICATION NOTE

Hardin County – HSIP 0311 (040)
FD52 047 031W 018-027
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7. Brandenburg Telecom	Kyle Dalton	2840 Leitchfield Road Elizabethtown, KY 42701 kyle.dalton@brandenburgtel.com
8. USIC (Locates for Windstream, AT&T, & COMCAST)	Chester Shoffner	502-528-5861 chestershoffner@usicllc.com
9. AT&T	Scott Roche	sr8832@att.com 502-348-4528
10. Contract Locator	Chris	217-994-4091

NOTE: The Utilities Contact List is provided as informational only, and may not be a complete list of all Utility Companies with facilities in the project area.

KYTC BMP Plan for Project CID 19 - 4218



Kentucky Transportation Cabinet

Highway District 4

And

_____ **(2), Construction**

**Kentucky Pollutant Discharge Elimination System
Permit KYR10
Best Management Practices (BMP) plan**

Groundwater protection plan

For Highway Construction Activities

For

**Highway Safety Improvement Project on US 31W
in Hardin County**

Project: CID 19 - 4218

KYTC BMP Plan for Project CID 19 - 4218

Project information

Note – (1) = Design (2) = Construction (3) = Contractor

1. Owner – Kentucky Transportation Cabinet, District 4
2. Resident Engineer: (2)
3. Contractor name: (2)
Address: (2)

Phone number: (2)
Contact: (2)
Contractors agent responsible for compliance with the KPDES permit requirements (3):
4. Project Control Number: (2)
5. Route (Address): US 31W
6. Latitude/Longitude (project mid-point): 37° 47' 23", -85° 54' 46"
7. County (project mid-point): Hardin
8. Project start date (date work will begin): (2)
9. Projected completion date: (2)

KYTC BMP Plan for Project CID 19 - 4218

A. Site description:

1. Nature of Construction Activity (from letting project description): Grade & Drain with Asphalt Surface
2. Order of major soil disturbing activities: (2) and (3)
3. Projected volume of material to be moved:
 - KY 220: 1250 CY (Cut) & 262 CY (Fill)
 - KY 434: 2928 CY (Cut) & 1198 CY (Fill)
 - Blackjack Road: 4361 CY (Cut) & 99 CY (Fill)
4. Estimate of total project area (acres):
 - KY 220: 4.1
 - KY 434: 7.7
 - Blackjack: 5.2
5. Estimate of area to be disturbed (acres):
 - KY 220: 0.9
 - KY 434: 2.1
 - Blackjack: 1.2
6. Post construction runoff coefficient will be included in the project drainage folder. Persons needing information pertaining to the runoff coefficient will contact the resident engineer to request this information.
7. Data describing existing soil condition: (1) & (2)
8. Data describing existing discharge water quality (if any): (1) & (2)
9. Receiving water name: Mill Creek Branch, Brushy Fork, & Disappearing Stream
10. TMDLs and Pollutants of Concern in Receiving Waters: No TDML's were involved on this project.
11. Site map – Project layout sheet plus the erosion control sheets in the project plans that depict Disturbed Drainage Areas (DDAs) and related information. These sheets depict the existing project conditions with areas delineated by DDA (drainage area bounded by watershed breaks and right of way limits), the storm water discharge locations (either as a point discharge or as overland flow) and the areas that drain to each discharge point. These plans define the limits of areas to be disturbed and the location of control measures. Controls will be either site specific as designated by the designer or will be annotated by the contractor and resident engineer before disturbance commences. The project layout sheet shows the surface waters and wetlands.
12. Potential sources of pollutants: The primary source of pollutants is solids that are mobilized during storm events. Other sources of pollutants include

KYTC BMP Plan for Project CID 19 - 4218

oil/fuel/grease from servicing and operating construction equipment, concrete washout water, sanitary wastes and trash/debris. (3)

B. Sediment and Erosion Control Measures:

1. Plans for highway construction projects will include erosion control sheets that depict Disturbed Drainage Areas (DDAs) and related information. These plan sheets will show the existing project conditions with areas delineated by DDA within the right of way limits, the discharge points and the areas that drain to each discharge point. Project managers and designers will analyze the DDAs and identify Best Management Practices (BMPs) that are site specific. The balance of the BMPs for the project will be listed in the bid documents for selection and use by the contractor on the project with approval by the resident engineer.

Projects that do not have DDAs annotated on the erosion control sheets will employ the same concepts for development and managing BMP plans.

2. Following award of the contract, the contractor and resident engineer will annotate the erosion control sheets showing location and type of BMPs for each of the DDAs that will be disturbed at the outset of the project. This annotation will be accompanied by an order of work that reflects the order or sequence of major soil moving activities. The remaining DDAs are to be designated as "Do Not Disturb" until the contractor and resident engineer prepare the plan for BMPs to be employed. The initial BMP's shall be for the first phase (generally Clearing and Grubbing) and shall be modified as needed as the project changes phases. The BMP Plan will be modified to reflect disturbance in additional DDA's as the work progresses. All DDA's will have adequate BMP's in place before being disturbed.
3. As DDAs are prepared for construction, the following will be addressed for the project as a whole or for each DDA as appropriate:
 - Construction Access – This is the first land-disturbing activity. As soon as construction begins, bare areas will be stabilized with gravel and temporary mulch and/or vegetation.
 - At the beginning of the project, all DDAs for the project will be inspected for areas that are a source of storm water pollutants. Areas that are a source of pollutants will receive appropriate cover or BMPs to arrest the introduction of pollutants into storm water. Areas that have not been opened by the contractor will be inspected periodically (once per month) to determine if there is a need to employ BMPs to keep pollutants from entering storm water.
 - Clearing and Grubbing – The following BMP's will be considered and used where appropriate.

KYTC BMP Plan for Project CID 19 - 4218

- Leaving areas undisturbed when possible.
- Silt basins to provide silt volume for large areas.
- Silt Traps Type A for small areas.
- Silt Traps Type C in front of existing pipes and drop inlets which are to be saved
- Diversion ditches to catch sheet runoff and carry it to basins or traps or to divert it around areas to be disturbed.
- Brush and/or other barriers to slow and/or divert runoff.
- Silt fences to catch sheet runoff on short slopes. For longer slopes, multiple rows of silt fence may be considered.
- Temporary Mulch for areas which are not feasible for the fore mentioned types of protections.
- Non-standard or innovative methods.
- Cut & Fill and placement of drainage structures - The BMP Plan will be modified to show additional BMP's such as:
 - Silt Traps Type B in ditches and/or drainways as they are completed
 - Silt Traps Type C in front of pipes and drop inlets after they are placed
 - Channel Lining
 - Erosion Control Blanket
 - Temporary mulch and/or seeding for areas where construction activities will be ceased for 21 days or more.
 - Non-standard or innovative methods
- Profile and X-Section in place – The BMP Plan will be modified to show elimination of BMP's which had to be removed and the addition of new BMP's as the roadway was shaped. Probably changes include:
 - Silt Trap Type A, Brush and/or other barriers, Temporary Mulch, and any other BMP which had to be removed for final grading to take place.
 - Additional Silt Traps Type B and Type C to be placed as final drainage patterns are put in place.
 - Additional Channel Lining and/or Erosion Control Blanket.
 - Temporary Mulch for areas where Permanent Seeding and Protection cannot be done within 21 days.
 - Special BMP's such as Karst Policy
- Finish Work (Paving, Seeding, Protect, etc.) – A final BMP Plan will result from modifications during this phase of construction. Probable changes include:
 - Removal of Silt Traps Type B from ditches and drainways if they are protected with other BMP's which are sufficient to control erosion, i.e. Erosion Control Blanket or Permanent Seeding and Protection on moderate grades.
 - Permanent Seeding and Protection

KYTC BMP Plan for Project CID 19 - 4218

- Placing Sod
- Planting trees and/or shrubs where they are included in the project
- BMP's including Storm Water Management Devices such as velocity dissipation devices and Karst policy BMP's to be installed during construction to control the pollutants in storm water discharges that will occur after construction has been completed are: This project does not include storm water BMPs or flow controls for post-construction use.

C. Other Control Measures

1. No solid materials, including building materials, shall be discharged to waters of the commonwealth, except as authorized by a Section 404 permit.
2. Waste Materials

All waste materials that may leach pollutants (paint and paint containers, caulk tubes, oil/grease containers, liquids of any kind, soluble materials, etc.) will be collected and stored in appropriate covered waste containers. Waste containers shall be removed from the project site on a sufficiently frequent basis as to not allow wastes to become a source of pollution. All personnel will be instructed regarding the correct procedure for waste disposal. Wastes will be disposed in accordance with appropriate regulations. Notices stating these practices will be posted in the office.

3. Hazardous Waste

All hazardous waste materials will be managed and disposed of in the manner specified by local or state regulation. The contractor shall notify the Section Engineer if there any hazardous wastes being generated at the project site and how these wastes are being managed. Site personnel will be instructed with regard to proper storage and handling of hazardous wastes when required. The Transportation Cabinet will file for generator, registration when appropriate, with the Division of Waste Management and advise the contractor regarding waste management requirements.

4. Spill Prevention

The following material management practices will be used to reduce the risk of spills or other exposure of materials and substances to the weather and/or runoff.

- **Good Housekeeping:**

KYTC BMP Plan for Project CID 19 - 4218

The following good housekeeping practices will be followed onsite during the construction project.

- An effort will be made to store only enough product required to do the job
- All materials stored onsite will be stored in a neat, orderly manner in their appropriate containers and, if possible, under a roof or other enclosure
- Products will be kept in their original containers with the original manufacturer's label
- Substances will not be mixed with one another unless recommended by the manufacturer
- Whenever possible, all of the product will be used up before disposing of the container
- Manufacturers' recommendations for proper use and disposal will be followed
- The site contractor will inspect daily to ensure proper use and disposal of materials onsite

➤ **Hazardous Products:**

These practices will be used to reduce the risks associated with any and all hazardous materials.

- Products will be kept in original containers unless they are not resealable
- Original labels and material safety data sheets (MSDS) will be reviewed and retained
- Contractor will follow procedures recommended by the manufacturer when handling hazardous materials
- If surplus product must be disposed of, manufacturers' or state/local recommended methods for proper disposal will be followed

The following product-specific practices will be followed onsite:

➤ **Petroleum Products:**

Vehicles and equipment that are fueled and maintained on site will be monitored for leaks, and receive regular preventative maintenance to reduce the chance of leakage. Petroleum products onsite will be stored in tightly sealed containers, which are clearly labeled and will be protected from exposure to weather.

The contractor shall prepare an Oil Pollution Spill Prevention Control and Countermeasure plan when the project that involves the storage of petroleum products in 55 gallon or larger containers with a total combined storage capacity of 1,320 gallons. This is a requirement of 40 CFR 112.

KYTC BMP Plan for Project CID 19 - 4218

This project (will / will not) (3) have over 1,320 gallons of petroleum products with a total capacity, sum of all containers 55 gallon capacity and larger.

➤ **Fertilizers:**

Fertilizers will be applied at rates prescribed by the contract, standard specifications or as directed by the resident engineer. Once applied, fertilizer will be covered with mulch or blankets or worked into the soil to limit exposure to storm water. Storage will be in a covered shed. The contents of any partially used bags of fertilizer will be transferred to a sealable plastic bin to avoid spills.

➤ **Paints:**

All containers will be tightly sealed and stored indoors or under roof when not being used. Excess paint or paint wash water will not be discharged to the drainage or storm sewer system but will be properly disposed of according to manufacturers' instructions or state and local regulations.

➤ **Concrete Truck Washout:**

Concrete truck mixers and chutes will not be washed on pavement, near storm drain inlets, or within 75 feet of any ditch, stream, wetland, lake, or sinkhole. Where possible, excess concrete and wash water will be discharged to areas prepared for pouring new concrete, flat areas to be paved that are away from ditches or drainage system features, or other locations that will not drain off site. Where this approach is not possible, a shallow earthen wash basin will be excavated away from ditches to receive the wash water

➤ **Spill Control Practices**

In addition to the good housekeeping and material management practices discussed in the previous sections of this plan, the following practices will be followed for spill prevention and cleanup:

- Manufacturers' recommended methods for spill cleanup will be clearly posted. All personnel will be made aware of procedures and the location of the information and cleanup supplies.
- Materials and equipment necessary for spill cleanup will be kept in the material storage area. Equipment and materials will include as appropriate, brooms, dust pans, mops, rags, gloves, oil absorbents, sand, sawdust, and plastic and metal trash containers.
- All spills will be cleaned up immediately after discovery.
- The spill area will be kept well ventilated and personnel will wear appropriate protective clothing to prevent injury from contact with a hazardous substance.

KYTC BMP Plan for Project CID 19 - 4218

- Spills of toxic or hazardous material will be reported to the appropriate state/local agency as required by KRS 224 and applicable federal law.
- The spill prevention plan will be adjusted as needed to prevent spills from reoccurring and improve spill response and cleanup.
- Spills of products will be cleaned up promptly. Wastes from spill clean up will be disposed in accordance with appropriate regulations.

D. Other State and Local Plans

This BMP plan shall include any requirements specified in sediment and erosion control plans, storm water management plans or permits that have been approved by other state or local officials. Upon submittal of the NOI, other requirements for surface water protection are incorporated by reference into and are enforceable under this permit (even if they are not specifically included in this BMP plan). This provision does not apply to master or comprehensive plans, non-enforceable guidelines or technical guidance documents that are not identified in a specific plan or permit issued for the construction site by state or local officials. *There are no other local (MS4) requirements that are expected to be necessary for this project.*

E. Maintenance

1. The BMP plan shall include a clear description of the maintenance procedures necessary to keep the control measures in good and effective operating condition.
- Maintenance of BMPs during construction shall be a result of weekly and post rain event inspections with action being taken by the contractor to correct deficiencies.
 - Post Construction maintenance will be a function of normal highway maintenance operations. Following final project acceptance by the cabinet, district highway crews will be responsible for identification and correction of deficiencies regarding ground cover and cleaning of storm water BMPs. The project manager shall identify any BMPs that will be for the purpose of post construction storm water management with specific guidance for any non-routine maintenance. There are no such BMP's for this project.

F. Inspections

Inspection and maintenance practices that will be used to maintain erosion and sediment controls:

KYTC BMP Plan for Project CID 19 - 4218

- All erosion prevention and sediment control measures will be inspected at least once each week and following any rain of one-half inch or more.
- Inspections will be conducted by individuals that have successfully completed the KEPSC-RI course as required by Section 213.02.02 of the Standard Specifications for Road and Bridge Construction, current edition.
- Inspection reports will be written, signed, dated, and kept on file.
- Areas at final grade will be seeded and mulched within 14 days.
- Areas that are not at final grade where construction has ceased for a period of 21 days or longer and soil stock piles shall receive temporary mulch no later than 14 days from the last construction activity in that area.
- All measures will be maintained in good working order; if a repair is necessary, it will be initiated within 24 hours of being reported.
- Built-up sediment will be removed from behind the silt fence before it has reached halfway up the height of the fence.
- Silt fences will be inspected for bypassing, overtopping, undercutting, depth of sediment, tears, and to ensure attachment to secure posts.
- Sediment basins will be inspected for depth of sediment, and built-up sediment will be removed when it reaches 50 percent of the design capacity and at the end of the job.
- Diversion dikes and berms will be inspected and any breaches promptly repaired. Areas that are eroding or scouring will be repaired and re-seeded / mulched as needed.
- Temporary and permanent seeding and mulching will be inspected for bare spots, washouts, and healthy growth. Bare or eroded areas will be repaired as needed.
- All material storage and equipment servicing areas that involve the management of bulk liquids, fuels, and bulk solids will be inspected weekly for conditions that represent a release or possible release of pollutants to the environment.

G. Non – Storm Water discharges

It is expected that non-storm water discharges may occur from the site during the construction period. Examples of non-storm water discharges include:

- Water from water line flushings.
- Water from cleaning concrete trucks and equipment.
- Pavement wash waters (where no spills or leaks of toxic or hazardous materials have occurred).

KYTC BMP Plan for Project CID 19 - 4218

- Uncontaminated groundwater and rain water (from dewatering during excavation).

All non-storm water discharges will be directed to the sediment basin or to a filter fence enclosure in a flat vegetated infiltration area or be filtered via another approved commercial product.

H. Groundwater Protection Plan (3)

This plan serves as the groundwater protection plan as required by 401 KAR 5:037.

- Contractors statement: (3)

The following activities, as enumerated by 401 KAR 5:037 Section 2 that require the preparation and implementation of a groundwater protection plan, will or may be conducted as part of this construction project:

_____ 2. (e) land treatment or land disposal of a pollutant;

_____ 2. (f) Storing, ..., or related handling of hazardous waste, solid waste or special waste, ..., in tanks, drums, or other containers, or in piles, (This does not include wastes managed in a container placed for collection and removal of municipal solid waste for disposal off site);

_____ 2. (g) Handling of materials in bulk quantities (equal or greater than 55 gallons or 100 pounds net dry weight transported held in an individual container) that, if released to the environment, would be a pollutant;

_____ 2. (j) Storing or related handling of road oils, dust suppressants,, at a central location;

_____ 2. (k) Application or related handling of road oils, dust suppressants or deicing materials, (does not include use of chloride-based deicing materials applied to roads or parking lots);

_____ 2. (m) Installation, construction, operation, or abandonment of wells, bore holes, or core holes, (this does not include bore holes for the purpose of explosive demolition);

Or, check the following only if there are no qualifying activities

_____ There are no activities for this project as listed in 401 KAR 5:037 Section 2 that require the preparation and implementation of a groundwater protection plan.

KYTC BMP Plan for Project CID **19 - 4218**

The contractor is responsible for the preparation of a plan that addresses the

401 KAR 5:037 Section 3. (3) Elements of site specific groundwater protection plan:

- (a) General information about this project is covered in the Project information;
- (b) Activities that require a groundwater protection plan have been identified above;
- (c) Practices that will protect groundwater from pollution are addressed in section C. Other control measures.
- (d) Implementation schedule – all practices required to prevent pollution of groundwater are to be in place prior to conducting the activity;
- (e) Training is required as a part of the ground water protection plan. All employees of the contractor, sub-contractor and resident engineer personnel will be trained to understand the nature and requirements of this plan as they pertain to their job function(s). Training will be accomplished within one week of employment and annually thereafter. A record of training will be maintained by the contractor with a copy provide to the resident engineer.
- (f) Areas of the project and groundwater plan activities will be inspected as part of the weekly sediment and erosion control inspections
- (g) Certification (see signature page.)

KYTC BMP Plan for Project CID 19 - 4218

Contractor and Resident Engineer Plan certification

The contractor that is responsible for implementing this BMP plan is identified in the Project Information section of this plan.

The following certification applies to all parties that are signatory to this BMP plan:

I certify under penalty of law that this document and all attachments were prepared under my direction or supervision in accordance with a system designed to assure that qualified personnel properly gathered and evaluated the information submitted. Based on my inquiry of the person or persons who manage the system, or those persons directly responsible for gathering the information, the information submitted is, to the best of my knowledge and belief, true, accurate, and complete. I am aware that there are significant penalties for submitting false information, including the possibility of fine and imprisonment for knowing violations. Further, this plan complies with the requirements of 401 KAR 5:037. By this certification, the undersigned state that the individuals signing the plan have reviewed the terms of the plan and will implement its provisions as they pertain to ground water protection.

Resident Engineer and Contractor Certification:

(2) Resident Engineer signature

Signed _____, _____
 Typed or printed name² signature

(3) Signed _____, _____
 Typed or printed name¹ signature

1. Contractors Note: to be signed by a person who is the owner, a responsible corporate officer, a general partner or the proprietor or a person designated to have the authority to sign reports by such a person in accordance with 401 KAR 5:060 Section 9. This delegation shall be in writing to: Manager, KPDES Branch, Division of Water, 14 Reilly Road, Frankfort Kentucky 40601. Reference the Project Control Number (PCN) and KPDES number when one has been issued.

2. KyTC note: to be signed by the Chief District Engineer or a person designated to have the authority to sign reports by such a person (usually the resident engineer) in accordance with 401 KAR 5:060 Section 9. This delegation shall be in writing to: Manager, KPDES Branch, Division of Water, 14 Reilly Road, Frankfort Kentucky 40601 Reference the Project Control Number (PCN) and KPDES number when one has been issued.

KYTC BMP Plan for Project CID 19 - 4218

Sub-Contractor Certification

The following sub-contractor shall be made aware of the BMP plan and responsible for implementation of BMPs identified in this plan as follows:

Subcontractor

Name:
Address:
Address:

Phone:

The part of BMP plan this subcontractor is responsible to implement is:

I certify under penalty of law that I understand the terms and conditions of the general Kentucky Pollutant Discharge Elimination System permit that authorizes the storm water discharges, the BMP plan that has been developed to manage the quality of water to be discharged as a result of storm events associated with the construction site activity and management of non-storm water pollutant sources identified as part of this certification.


Signed _____ title _____, _____
Typed or printed name¹ signature

1. Sub Contractor Note: to be signed by a person who is the owner, a responsible corporate officer, a general partner or the proprietor or a person designated to have the authority to sign reports by such a person in accordance with 401 KAR 5:060 Section 9. This delegation shall be in writing to: Manager, KPDES Branch, Division of Water, 14 Reilly Road, Frankfort Kentucky 40601. Reference the Project Control Number (PCN) and KPDES number when one has been issued.

CID 19-4218
Hardin County
Highway Safety Improvement Project along US 31W
from MP 22.099 – 26.251
Item No.: 4-9008.40

An electronic Notice of Intent (eNOI) for obtaining coverage under the Kentucky Pollutant Discharge Elimination System (KPDES) General Permit for Stormwater Discharges Associated with Construction Activities (KYR10) has been drafted, a copy of which is attached. Upon award, the Contractor will be identified in Section III of the form as the “Building Contractor” and the eNOI will be submitted for approval to the Kentucky Division of Water. The Contractor shall be responsible for advancing the work within this contract in a manner that is compliant with all applicable and appropriate KYTC specifications for sediment and erosion control, as well as meeting the requirements of the KYR10 permit and the KDOW.

eForm Submittal ID: 159908

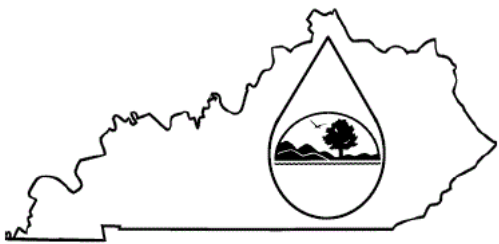	<h2 style="margin:0;">KENTUCKY POLLUTION DISCHARGE</h2> <h3 style="margin:0;">ELIMINATION SYSTEM (KPDES)</h3> <p style="margin:0;">Notice of Intent (NOI) for coverage of Storm Water Discharge Associated with Construction Activities Under the KPDES Storm Water General Permit KYR100000</p> <p style="margin:0;">Click here for Instructions (Controls/KPDES_FormKYR10_Instructions.htm)</p> <p style="margin:0;">Click here to obtain information and a copy of the KPDES General Permit. (http://dep.ky.gov/formslibrary/Documents/KYR10PermitPage.pdf)</p> <p style="margin:0;">(*) indicates a required field; (✓) indicates a field may be required based on user input or is an optionally required field</p>
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Reason for Submittal:(*) <input type="text" value="Application for New Permit Coverage"/>	Agency Interest ID: <input type="text" value="Agency Interest ID"/>	Permit Number:(✓) <input type="text" value="KPDES Permit Number"/>
--	--	---

If change to existing permit coverage is requested, describe the changes for which modification of coverage is being sought:(✓)

ELIGIBILITY:
Stormwater discharges associated with construction activities disturbing individually one (1) acre or more, including, in the case of a common plan of development, contiguous construction activities that cumulatively equal one (1) acre or more of disturbance.

EXCLUSIONS:
The following are excluded from coverage under this general permit:
 1) Are conducted at or on properties that have obtained an individual KPDES permit for the discharge of other wastewaters which requires the development and implementation of a Best Management Practices (BMP) plan;
 2) Any operation that the DOW determines an individual permit would better address the discharges from that operation;
 3) Any project that discharges to an Impaired Water listed in the most recent Integrated Report, §305(b) as impaired for sediment and for which an approved TMDL has been developed.

SECTION I -- FACILITY OPERATOR INFORMATION (PERMITTEE)

Company Name:(✓) <input type="text" value="KYTC District 4"/>	First Name:(✓) <input type="text" value="Paul"/>	M.I.: <input type="text" value="MI"/>	Last Name:(✓) <input type="text" value="Sanders"/>
Mailing Address:(*) <input type="text" value="634 East Dixie Ave"/>	City:(*) <input type="text" value="Elizabethtown"/>	State:(*) <input type="text" value="Kentucky"/>	Zip:(*) <input type="text" value="42701"/>
eMail Address:(*) <input type="text" value="Paul.Sanders@ky.gov"/>	Business Phone:(*) <input type="text" value="2707665066"/>	Alternate Phone: <input type="text" value="Phone"/>	

SECTION II -- GENERAL SITE LOCATION INFORMATION

Project Name:(*) <input type="text" value="KYTC Project: CID 19-4218"/>	Status of Owner/Operator(*) <input type="text" value="State Government"/>	SIC Code(*) <input type="text" value="1611 Highway and Street Const"/>
Company Name:(✓) <input type="text" value="KYTC Department of Highways District 4"/>	First Name:(✓) <input type="text" value="Paul"/>	M.I.: <input type="text" value="MI"/>
Last Name:(✓) <input type="text" value="Sanders"/>		
Site Physical Address:(*) <input type="text" value="US-31W"/>		
City:(*) <input type="text" value="Elizabethtown"/>	State:(*) <input type="text" value="Kentucky"/>	Zip:(*) <input type="text" value="42701"/>
County:(*) <input type="text" value="Hardin"/>	Latitude(decimal degrees)(*)DMS to DD Converter (https://www.fcc.gov/media/radio/dms-decimal) <input type="text" value="37.789658"/>	Longitude(decimal degrees)(*) <input type="text" value="-85.912683"/>

SECTION III -- SPECIFIC SITE ACTIVITY INFORMATION

Project Description:(*)

a. For single projects provide the following information

Total Number of Acres in Project:(✓) <input style="width:95%;" type="text" value="17.0"/>	Total Number of Acres Disturbed:(✓) <input style="width:95%;" type="text" value="4.2"/>
Anticipated Start Date:(✓) <input style="width:95%;" type="text"/>	Anticipated Completion Date:(✓) <input style="width:95%;" type="text"/>

b. For common plans of development provide the following information

Total Number of Acres in Project:(✓) <input style="width:95%;" type="text" value="# Acre(s)"/>	Total Number of Acres Disturbed:(✓) <input style="width:95%;" type="text" value="# Acre(s)"/>
Number of individual lots in development, if applicable:(✓) <input style="width:95%;" type="text" value="# lot(s)"/>	Number of lots in development:(✓) <input style="width:95%;" type="text" value="# lot(s)"/>
Total acreage of lots intended to be developed:(✓) <input style="width:95%;" type="text" value="Project Acres"/>	Number of acres intended to be disturbed at any one time:(✓) <input style="width:95%;" type="text" value="Disturbed Acres"/>
Anticipated Start Date:(✓) <input style="width:95%;" type="text"/>	Anticipated Completion Date:(✓) <input style="width:95%;" type="text"/>

List Building Contractor(s) at the time of Application:(*)

	Company Name		
+	<input style="width:95%;" type="text"/>	<input style="width:95%;" type="text"/>	<input style="width:95%;" type="text"/>

SECTION IV -- IF THE PERMITTED SITE DISCHARGES TO A WATER BODY THE FOLLOWING INFORMATION IS REQUIRED ?

Discharge Point(s):

	Unnamed Tributary?	Latitude	Longitude	Receiving Water Name	
1	Yes	37.787250	-85.911585	Brushy Fork	Delete
2	Yes	37.787501	-85.911683	Brushy Fork	Delete
3	Yes	37.787745	-85.911804	Brushy Fork	Delete
4	Yes	37.788502	-85.911926	Brushy Fork	Delete
5	Yes	37.788555	-85.912181	Brushy Fork	Delete
6	Yes	37.789085	-85.912400	Brushy Fork	Delete
7	Yes	37.789531	-85.913077	Brushy Fork	Delete
8	Yes	37.789674	-85.913295	Brushy Fork	Delete
9	Yes	37.789776	-85.912462	Brushy Fork	Delete
10	Yes	37.789781	-85.913010	Brushy Fork	Delete

SECTION V -- IF THE PERMITTED SITE DISCHARGES TO A MS4 THE FOLLOWING INFORMATION IS REQUIRED ?

Name of MS4: <input style="width:95%;" type="text"/>											
Date of application/notification to the MS4 for construction site permit coverage: <input style="width:95%;" type="text" value="Date"/>	Discharge Point(s):(*) <table border="1" style="width:100%; border-collapse: collapse;"> <thead> <tr> <th style="width:5%;"></th> <th style="width:20%;">Latitude</th> <th style="width:20%;">Longitude</th> <th style="width:20%;"></th> <th style="width:35%;"></th> </tr> </thead> <tbody> <tr> <td style="text-align:center;">+</td> <td><input style="width:95%;" type="text"/></td> <td><input style="width:95%;" type="text"/></td> <td><input style="width:95%;" type="text"/></td> <td><input style="width:95%;" type="text"/></td> </tr> </tbody> </table>		Latitude	Longitude			+	<input style="width:95%;" type="text"/>	<input style="width:95%;" type="text"/>	<input style="width:95%;" type="text"/>	<input style="width:95%;" type="text"/>
	Latitude	Longitude									
+	<input style="width:95%;" type="text"/>	<input style="width:95%;" type="text"/>	<input style="width:95%;" type="text"/>	<input style="width:95%;" type="text"/>							

SECTION VI -- WILL THE PROJECT REQUIRE CONSTRUCTION ACTIVITIES IN A WATER BODY OR THE RIPARIAN ZONE?

Will the project require construction activities in a water body or the riparian zone?: (*)	<input style="width:95%;" type="text" value="No"/>
If Yes, describe scope of activity: (✓)	<input style="width:95%;" type="text" value="describe scope of activity"/>
Is a Clean Water Act 404 permit required?:(*)	<input style="width:95%;" type="text" value="No"/>

Is a Clean Water Act 401 Water Quality Certification required?:(*)	No
--	----

SECTION VII -- NOI PREPARER INFORMATION

First Name:(*) First Name	M.I.: MI	Last Name:(*) Last Name	Company Name:(*) Company Name
Mailing Address:(*) Mailing Address	City:(*) City	State:(*)	Zip:(*) Zip
eMail Address:(*) eMail Address	Business Phone:(*) Phone	Alternate Phone: Phone	

SECTION VIII -- ATTACHMENTS


Facility Location Map:(*)	Upload file
Supplemental Information:	Upload file

SECTION IX -- CERTIFICATION


I certify under penalty of law that this document and all attachments were prepared under my direction or supervision in accordance with a system designed to assure that qualified personnel properly gather and evaluate the information submitted. Based on my inquiry of the person or persons who manage the system, or those persons directly responsible for gathering the information submitted is, to the best of my knowledge and belief, true, accurate, and complete. I am aware that there are significant penalties for submitting false information, including the possibility of fine and imprisonment for knowing violations.



Signature:(*) Signature	Title:(*) Title		
First Name:(*) First Name	M.I.: MI	Last Name:(*) Last Name	
eMail Address:(*) eMail Address	Business Phone:(*) Phone	Alternate Phone: Phone	Signature Date:(*) Date

Click to Save Values for Future Retrieval	Click to Submit to EEC
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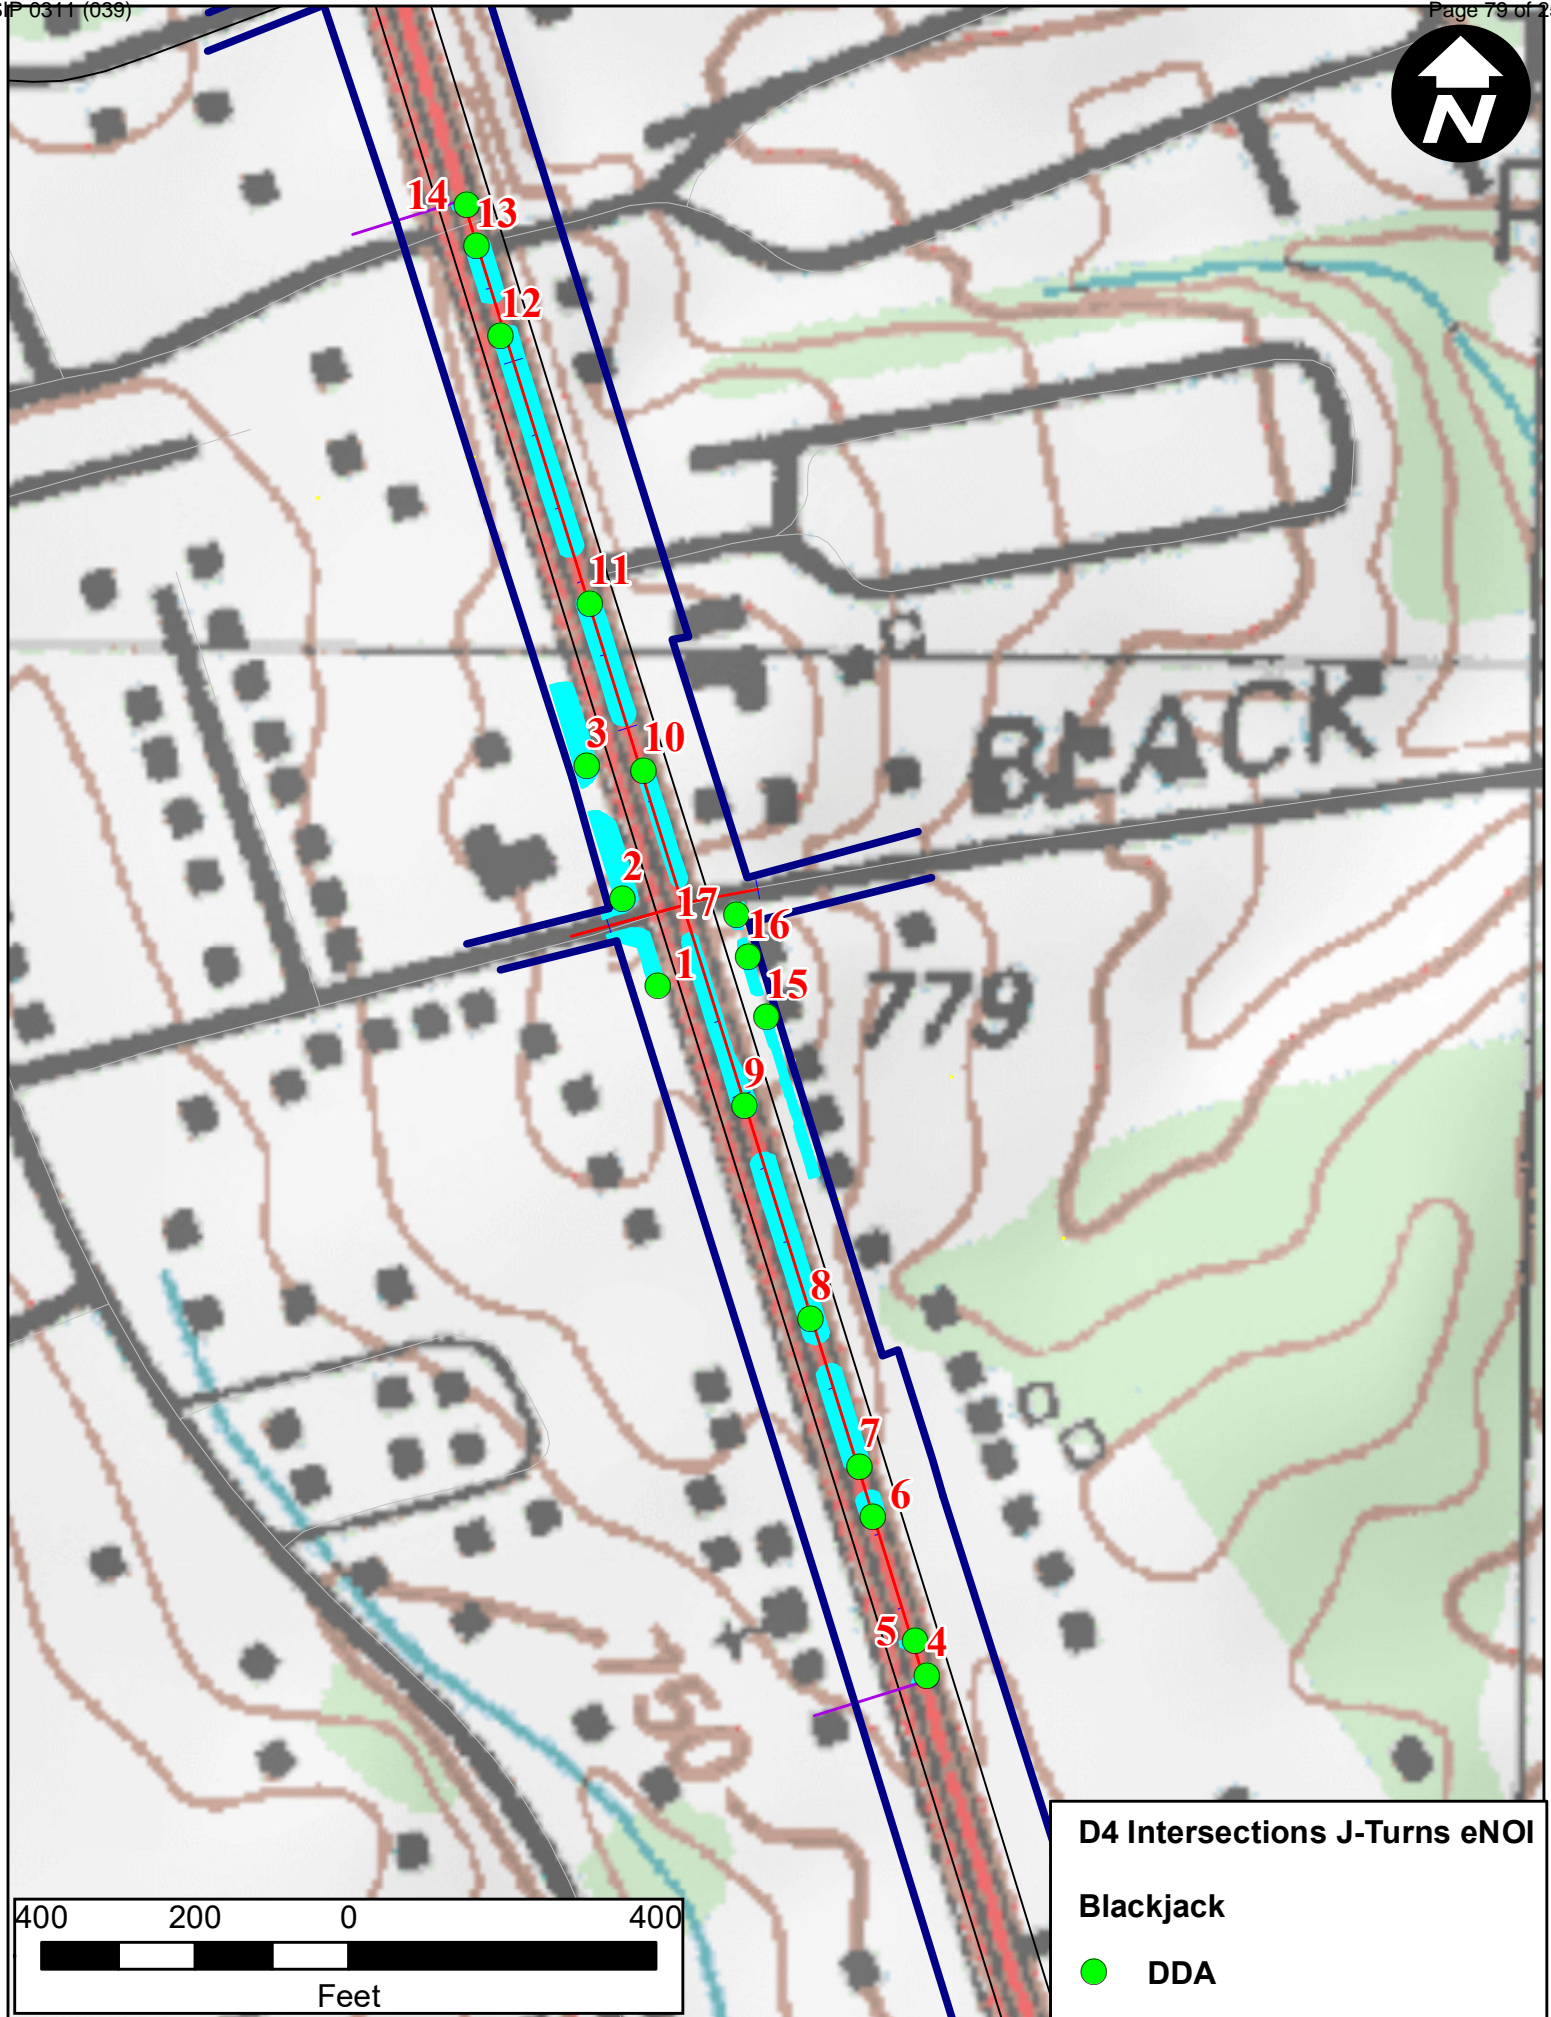


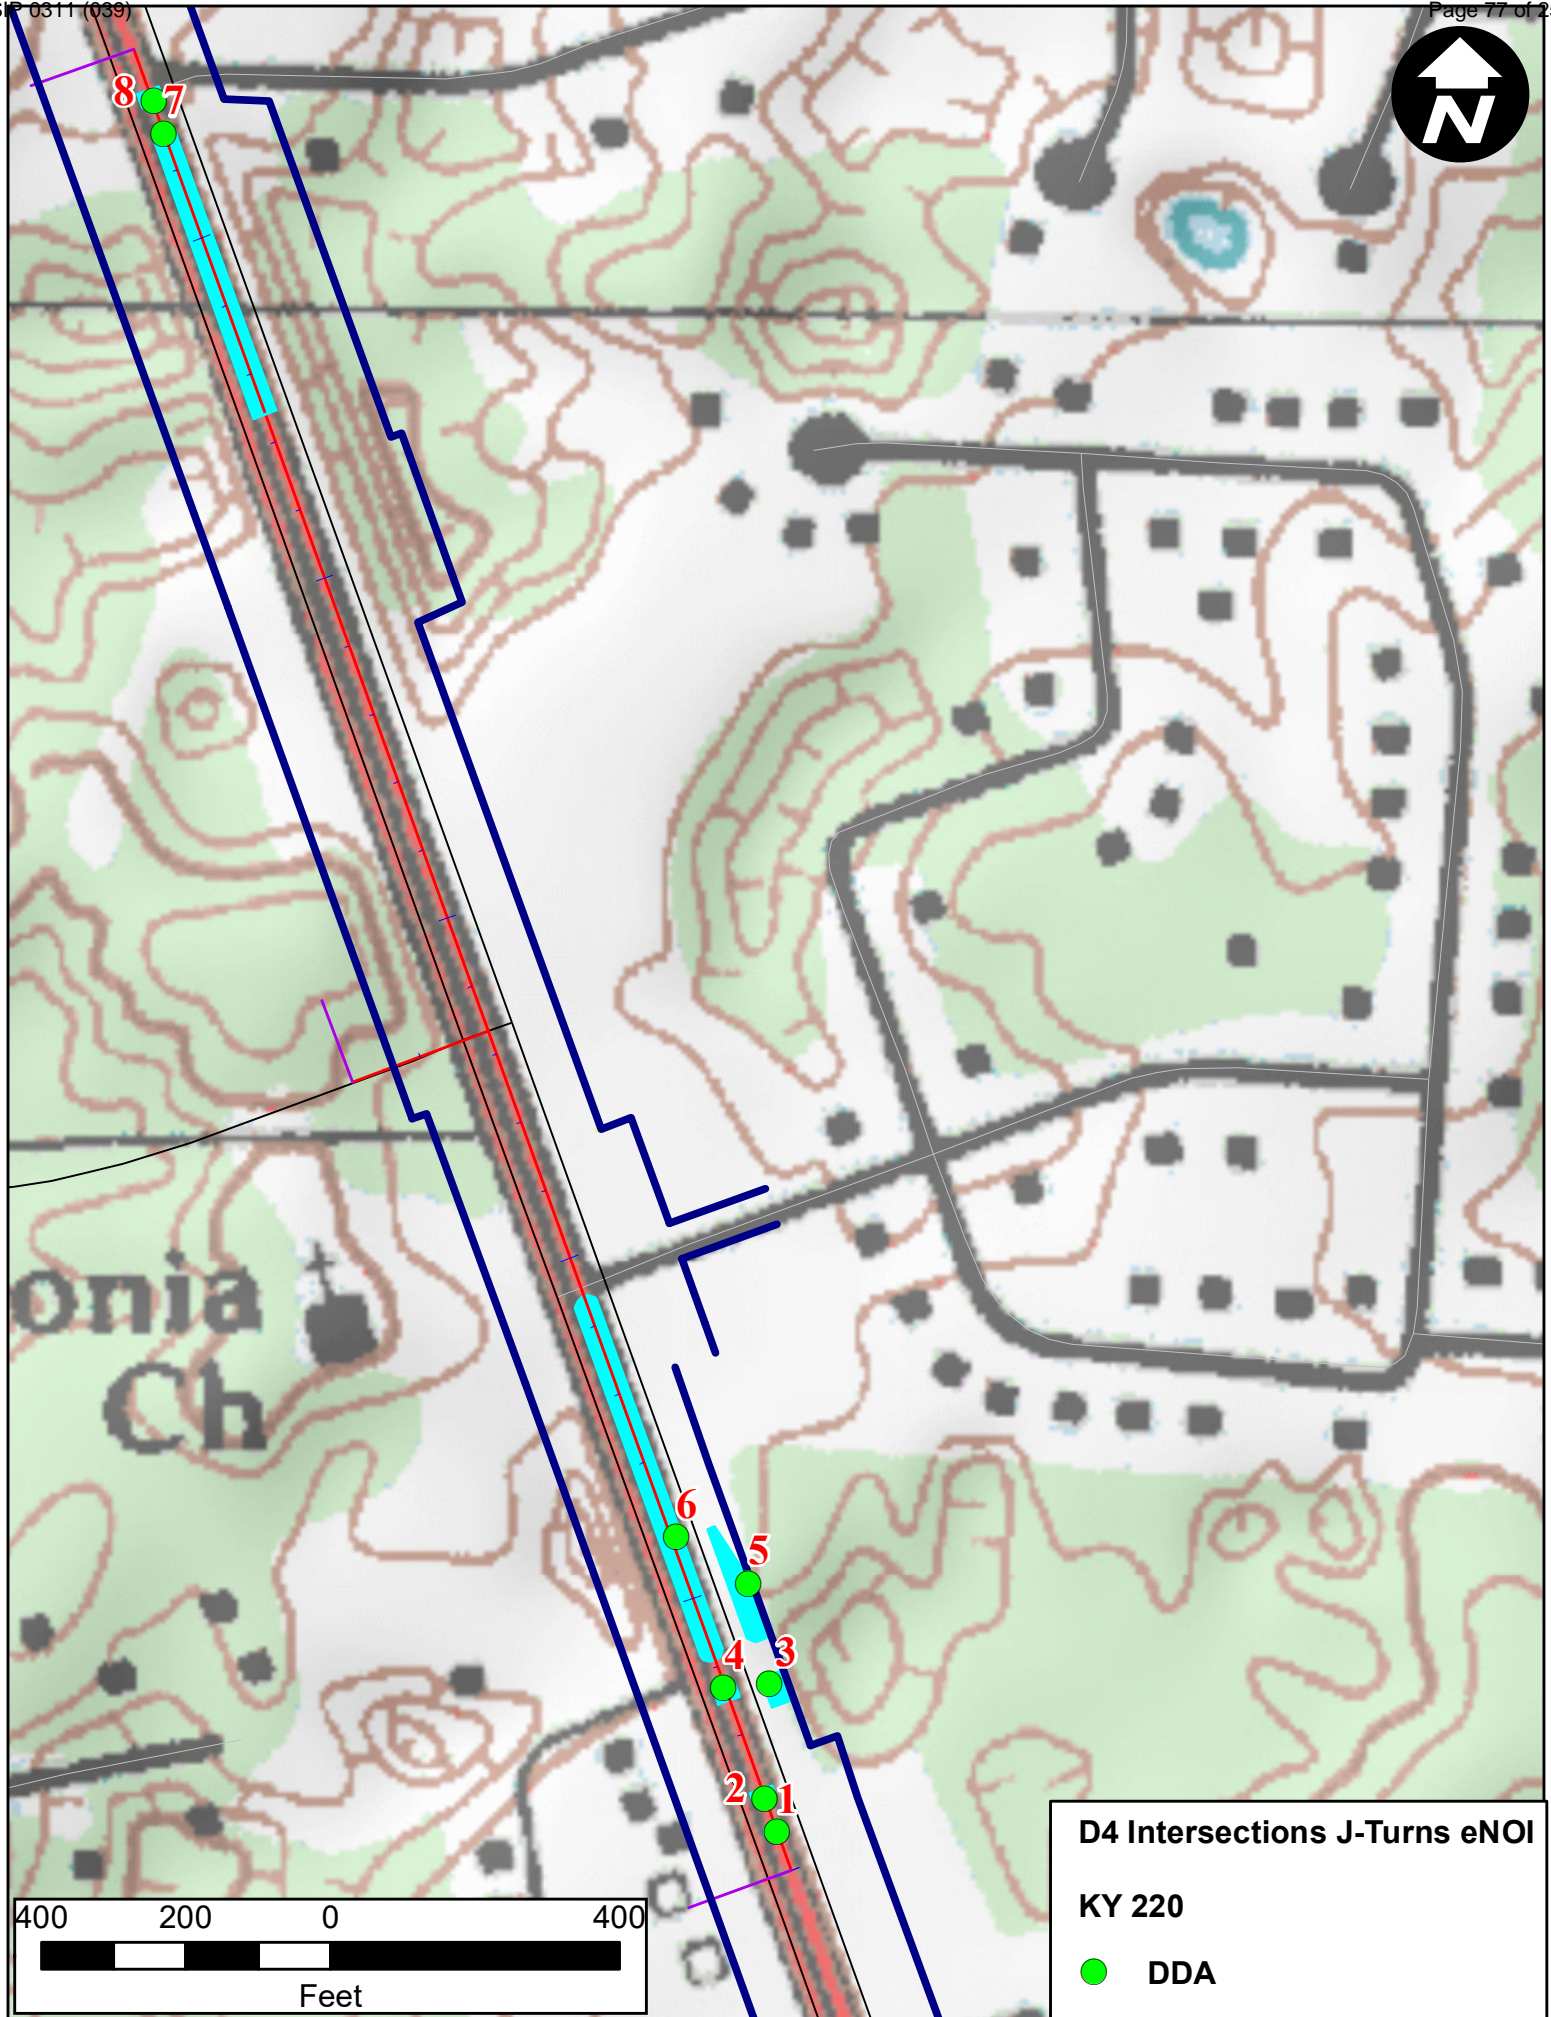D4 Intersections J-Turns eNOI
KY 220
● DDA



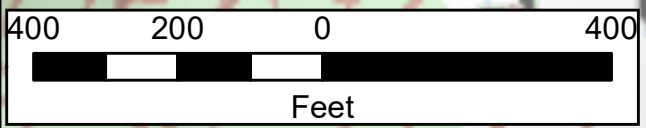

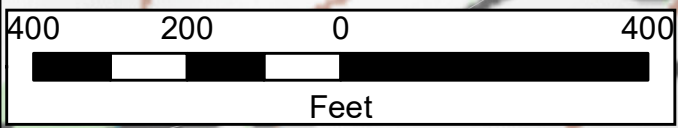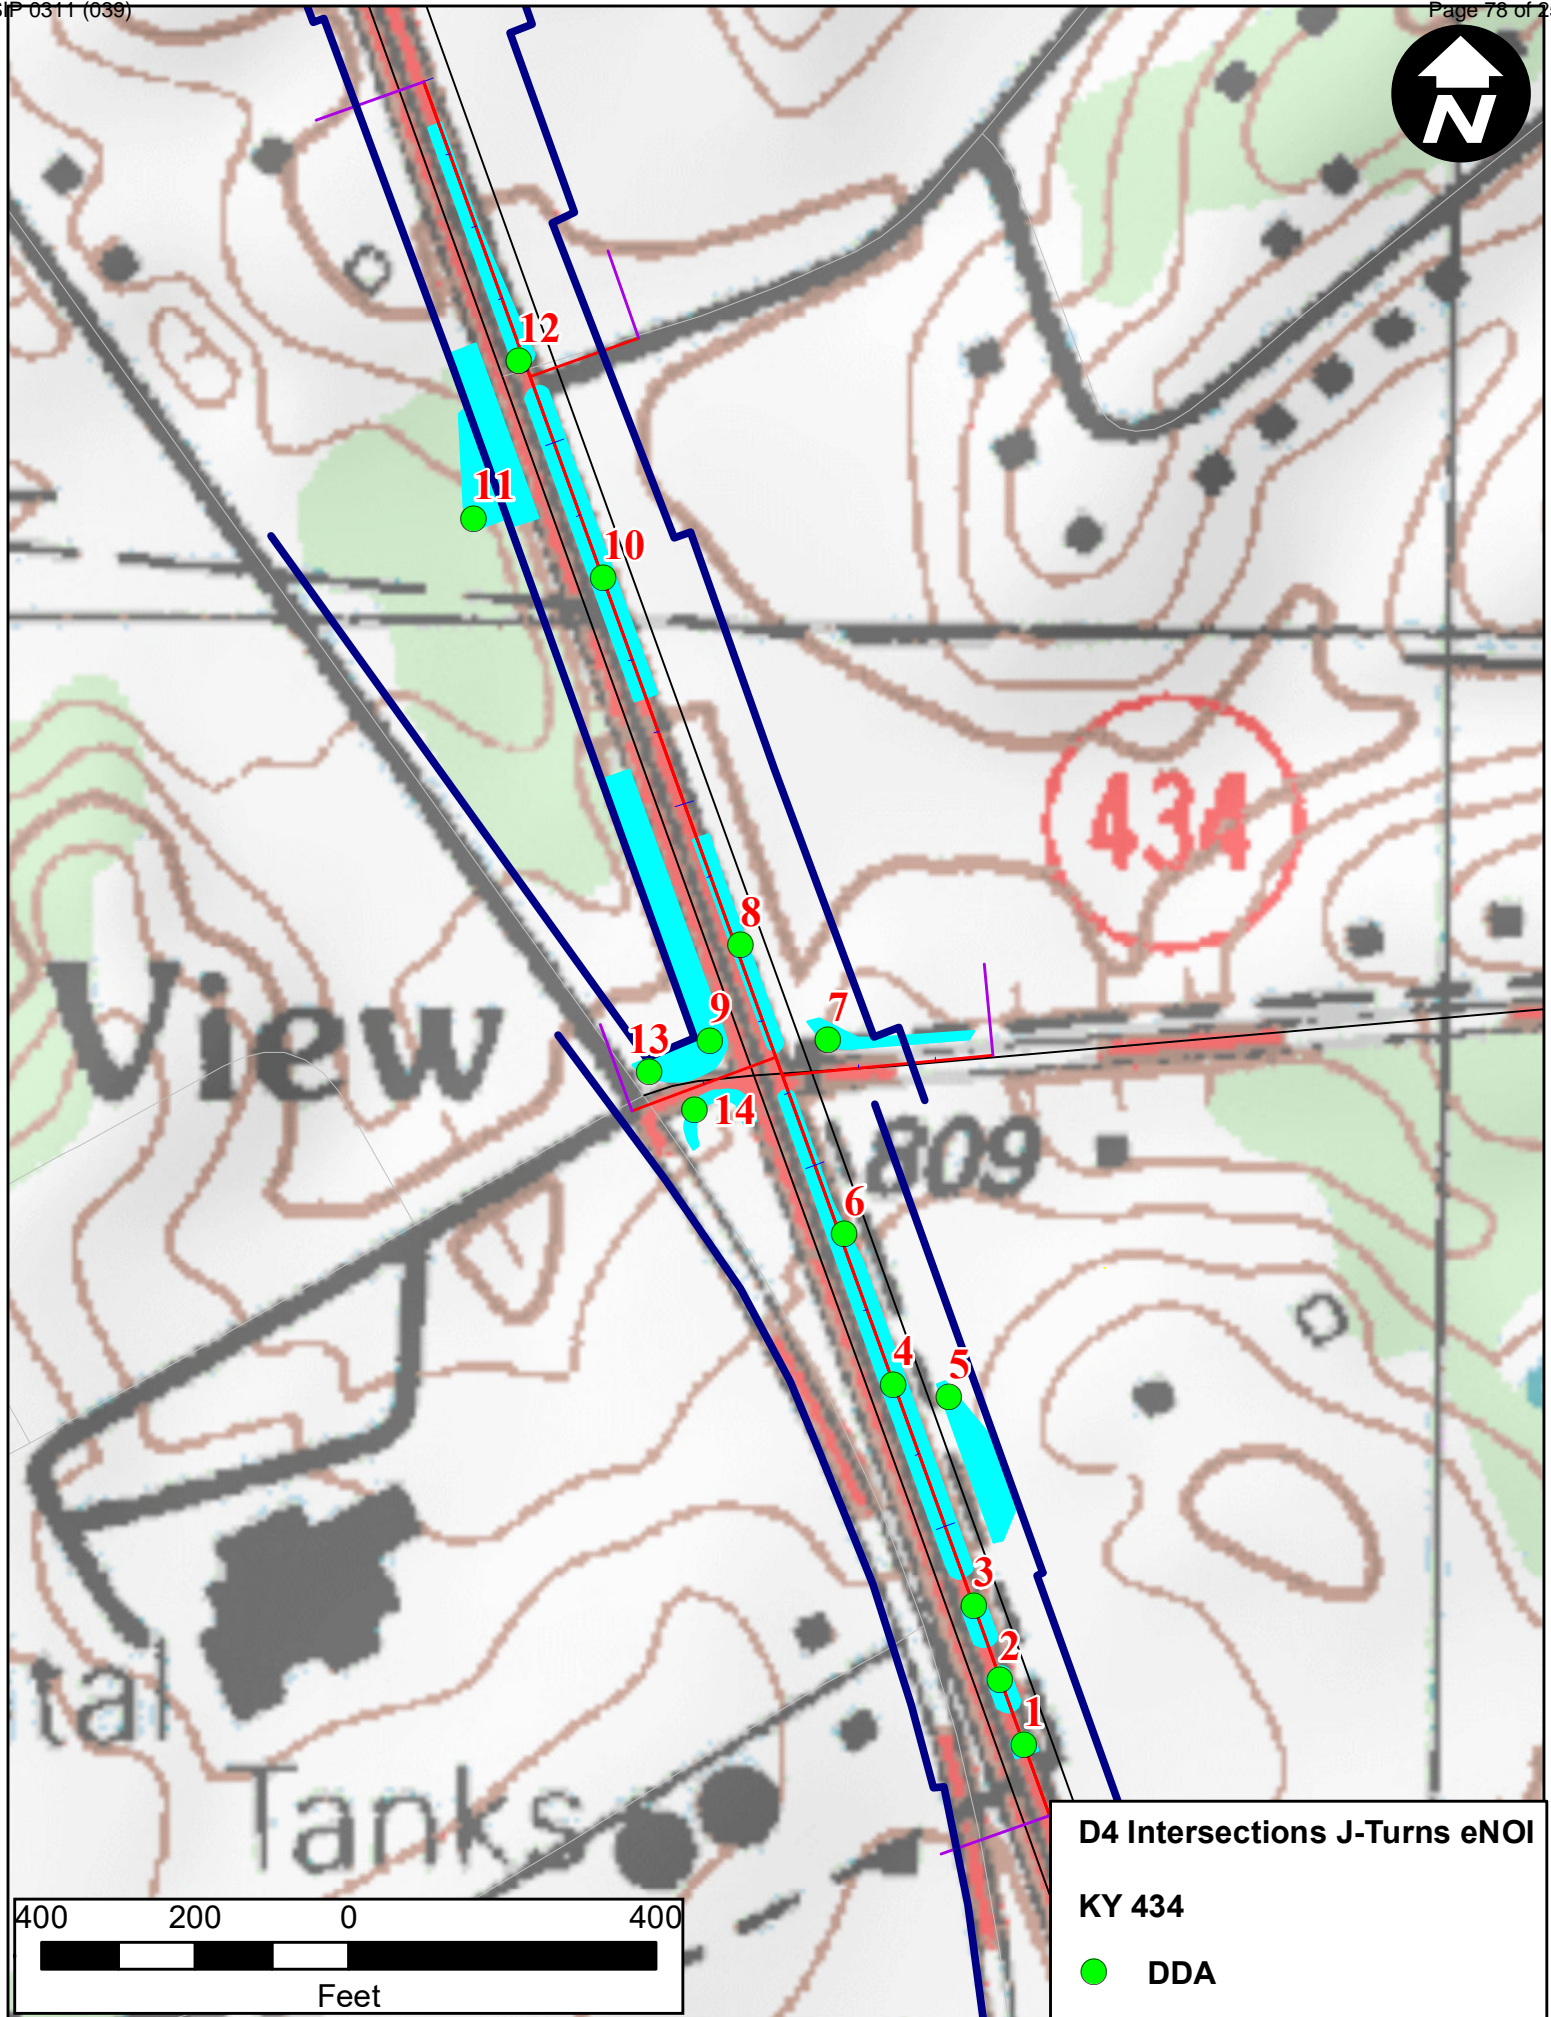
D4 Intersections J-Turns eNOI
KY 434
● DDA



D4 Intersections J-Turns eNOI

Blackjack

● DDA

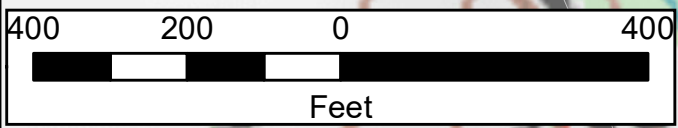


Overall Summary of Bid Items

Item	Description	Unit	US 31W @ KY 220	US 31W @ KY 434	US 31W @ Blackjack Rd	Project Total
3	CRUSHED STONE BASE	TON	1284	2051	1576	4911
100	ASPHALT SEAL AGGREGATE	TON	11.9	18.9	14.3	45.1
103	ASPHALT SEAL COAT	TON	1.4	2.3	1.7	5.4
190	LEVELING & WEDGING PG64-22	TON	2	2	2	6
214	CL3 ASPH BASE 1.00D PG64-22	TON	1335	2612	2139	6086
216	CL3 ASPH BASE 1.00D PG76-22	TON	442	852	708	2002
336	CL3 ASPH SURF 0.38A PG76-22	TON	219	424	357	1000
2101	CEM CONC ENT PAVEMENT-8 IN	SQ YD	140	--	--	140
24970EC	ASPHALT MATERIAL FOR TACK NON-TRACKING	TON	2.6	5	4.2	11.8
440	ENTRANCE PIPE-15 IN	LF	--	--	71	71
461	CULVERT PIPE-15 IN	LF	146	119	125	390
462	CULVERT PIPE-18 IN	LF	212	74	--	286
521	STORM SEWER PIPE-15 IN	LF	72	538	537	1147
522	STORM SEWER PIPE-18 IN	LF	265	433	38	736
524	STORM SEWER PIPE-24 IN	LF	10	9	--	19
1204	PIPE CULVERT HEADWALL-18 IN	EACH	--	1	--	1
1310	REMOVE PIPE	LF	306	268	546	1120
1432	SLOPED BOX OUTLET TYPE 1-15 IN	EACH	2	1	6	9
1433	SLOPED BOX OUTLET TYPE 1-18 IN	EACH	1	--	1	2
1434	SLOPED BOX OUTLET TYPE 1-24 IN	EACH	1	--	--	1
1456	CURB BOX INLET TYPE A	EACH	--	1	4	5
1487	CURB BOX INLET TYPE F	EACH	2	10	3	15
1511	DROP BOX INLET TYPE 5D	EACH	3	4	1	8
1584	CAP DROP BOX INLET	EACH	1	--	--	1
1585	REMOVE DROP BOX INLET	EACH	--	--	2	2
1650	JUNCTION BOX	EACH	--	1	--	1
1718	REMOVE INLET	EACH	2	2	--	4
2625	REMOVE HEADWALL	EACH	3	--	1	4
2690	SAFELOADING	CU YD	4.3	--	--	4.3
23822EC	CORE HOLE DRAINAGE BOX CON-15 IN	EACH	4	--	--	4
23952EC	DRAINAGE JUNCTION BOX TY B	EACH	1	--	--	1
78	CRUSHED AGGREGATE SIZE NO 2	TON	--	19	24	43
1000	PERFORATED PIPE-4 IN	LF	--	410	525	935
1010	NON-PERFORATED PIPE-4 IN	LF	--	10	8	18
1314	PLUG PIPE	EACH	--	1	--	1
1811	STANDARD CURB AND GUTTER MOD	LF	--	--	41	41
1885	LIP HEADER CURB	LF	90	--	--	90
1904	REMOVE CURB	LF	--	946	1303	2249
1917	STANDARD BARRIER MEDIAN TYPE 2	SQ YD	52	745	737	1534
1921	STANDARD BARRIER MEDIAN TYPE 4	SQ YD	630	155	173	958
2159	TEMP DITCH	LF	625	1120	979	2724
2160	CLEAN TEMP DITCH	LF	313	560	490	1363
2200	ROADWAY EXCAVATION	CU YD	1250	2928	4361	8539
2242	WATER	MGAL	37	32	29	98
2351	GUARDRAIL-STEEL W BEAM-S FACE	LF	--	475	--	475
2360	GUARDRAIL TERMINAL SECTION NO 1	EACH	--	1	--	1
2369	GUARDRAIL END TREATMENT TYPE 2A	EACH	--	1	--	1
2381	REMOVE GUARDRAIL	LF	--	495	--	495
2403	REMOVE CONCRETE MASONRY (FOR REMOVAL OF CONCRETE FLUME IN MEDIAN)	CU YD	--	1.7	--	1.7
2429	RIGHT-OF-WAY MONUMENT TYPE 1	EACH	--	4	--	4
2432	WITNESS POST	EACH	--	4	--	4
2483	CHANNEL LINING CLASS II	TON	--	180	--	180

Overall Summary of Bid Items

Item	Description	Unit	US 31W @ KY 220	US 31W @ KY 434	US 31W @ Blackjack Rd	Project Total
2545	CLEARING & GRUBBING (US 31W @ KY 220)	LS	1	--	--	1
2545	CLEARING & GRUBBING (US 31W @ KY 434)	LS	--	1	--	1
2545	CLEARING & GRUBBING (US 31W @ BLACKJACK)	LS	--	--	1	1
2562	TEMPORARY SIGNS	SQ FT	213	213	213	639
2585	EDGE KEY	LF	--	144	23	167
2600	FABRIC GEOTEXTILE TY IV FOR PIPE	SQ YD	911	1558	1840	4309
2650	MAINTAIN & CONTROL TRAFFIC (US 31W @ KY 220)	LS	1	--	--	1
2650	MAINTAIN & CONTROL TRAFFIC (US 31W @ KY 434)	LS	--	1	--	1
2650	MAINTAIN & CONTROL TRAFFIC (US 31W @ BLACKJACK)	LS	--	--	1	1
2671	PORTABLE CHANGEABLE MESSAGE SIGN	EACH	2	2	2	6
2676	MOBILIZATION FOR MILL & TEXT (US 31W @ KY 220)	LS	1	--	--	1
2676	MOBILIZATION FOR MILL & TEXT (US 31W @ KY 434)	LS	--	1	--	1
2676	MOBILIZATION FOR MILL & TEXT (US 31W @ BLACKJACK)	LS	--	--	1	1
2677	ASPHALT PAVE MILLING & TEXTURING	TON	52	12	15	79
2697	EDGE LINE RUMBLE STRIPS	LF	--	150	--	150
2701	TEMP SILT FENCE	LF	625	1120	979	2724
2703	SILT TRAP TYPE A	EACH	1	1	1	3
2704	SILT TRAP TYPE B	EACH	3	5	5	13
2705	SILT TRAP TYPE C	EACH	10	15	10	35
2706	CLEAN SILT TRAP TYPE A	EACH	1	1	1	3
2707	CLEAN SILT TRAP TYPE B	EACH	3	5	5	13
2708	CLEAN SILT TRAP TYPE C	EACH	10	15	10	35
2720	SIDEWALK-4 IN CONCRETE	SQ YD	--	--	21	21
2726	STAKING (US 31W @ KY 220)	LS	1	--	--	1
2726	STAKING (US 31W @ KY 434)	LS	--	1	--	1
2726	STAKING (US 31W @ BLACKJACK)	LS	--	--	1	1
2775	ARROW PANEL	EACH	2	2	2	6
3290	SIDEWALK RAMP TYPE 4	EACH	--	--	1	1
5950	EROSION CONTROL BLANKET	SQ YD	1288	951	840	3079
5952	TEMP MULCH	SQ YD	2788	6911	3966	13665
5953	TEMP SEEDING AND PROTECTION	SQ YD	2091	5183	2975	10249
5963	INITIAL FERTILIZER	TON	0.17	0.34	0.21	0.72
5964	MAINTENANCE FERTILIZER	TON	0.28	0.57	0.35	1.2
5985	SEEDING AND PROTECTION	SQ YD	4182	10083	5949	20214
5989	SPECIAL SEEDING CROWN VETCH	SQ YD	--	957	--	957
5992	AGRICULTURAL LIMESTONE	TON	3.41	6.84	4.21	14.46
6530	PAVE STRIPING REMOVAL-4 IN	LF	1902	1144	2037	5083
6568	PAVE MARKING-THERMO STOP BAR-24 IN	LF	--	89	--	89
6569	PAVE MARKING-THERMO CROSS-HATCH	SQ FT	114	319	--	433
6574	PAVE MARKING-THERMO CURV ARROW	EACH	13	19	21	53
6576	PAVE MARKING-THERMO ONLY	EACH	1	--	--	1
6598	PAVEMENT MARKING REMOVAL	SQ FT	233	279	247	759
10020NS	FUEL ADJUSTMENT	DOLL	3041	6088	5017	14146
10030NS	ASPHALT ADJUSTMENT	DOLL	7638	15291	12601	35530
20550ND	SAWCUT PAVEMENT	LF	1933	1832	2187	5952
21289ED	LONGITUDINAL EDGE KEY	LF	1811	3491	2731	8033
22861EN	HIGH STRENGTH GEOTEXTILE FABRIC TY V	SQ YD	--	156	198	354
23158ES505	DETECTABLE WARNINGS	SQ FT	--	--	20	20
23274EN11F	TURF REINFORCEMENT MAT 1	SQ YD	120	--	570	690
24489EC	INLAID PAVEMENT MARKER	EACH	33	48	77	158
24679ED	PAVE MARK THERMO CHEVRON	SQ FT	63	122	362	547
24814EC	PIPELINE INSPECTION	LF	672	1173	736	2581
24955ED	REMOVE SIGNAL EQUIPMENT	EACH	1	2	1	4
24995EC	PAVE STRIPING-SPRAY THERMO-6 IN W	LF	1411	3219	2944	7574
24996EC	PAVE STRIPING-SPRAY THERMO-6 IN Y	LF	1433	3555	3368	8356

CHEVRON PAVEMENT MARKINGS DETAIL

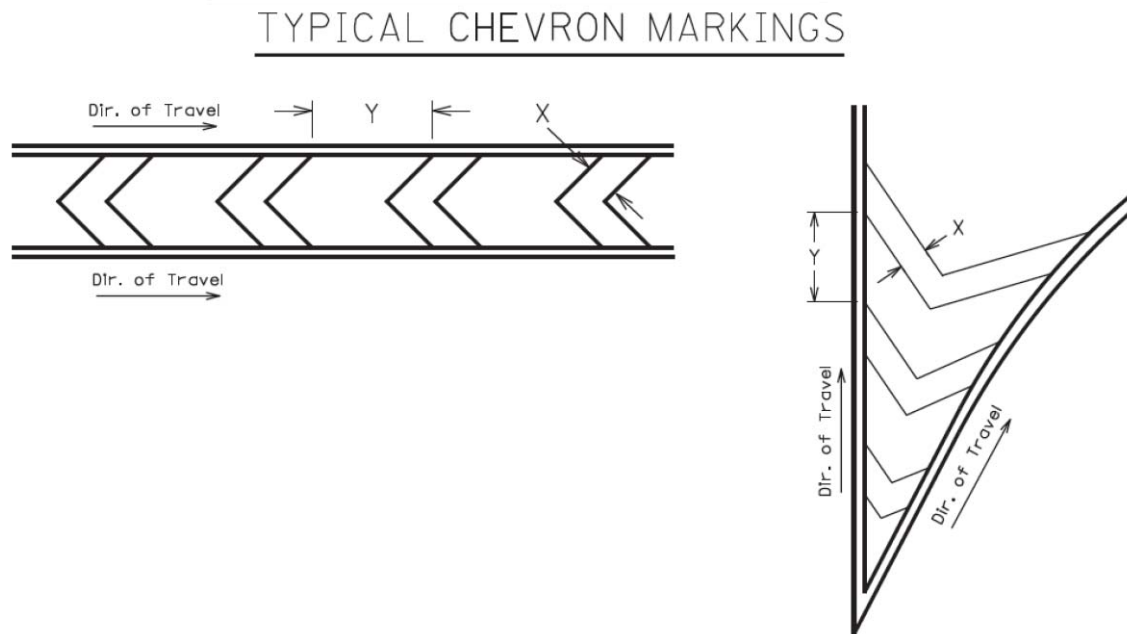

The chevron pavement marking width (X) and spacing (Y) will usually be specified in the plans. The width to spacing values usually have a ratio of 1:10. If the plans do not specify the width (X) and spacing (Y) the Engineer will provide the contractor with the X and Y values for each chevron installation. If necessary, the Engineer may obtain guidance from the District Traffic Engineer and/or the Division of Traffic Operations.

NOTE: Adjust the width and spacing of the chevron pavement markings as necessary so that a minimum of three (3) chevron markings are placed within the area being marked. The 1:10 ratio between width and spacing values should be maintained as much as possible.

Refer to Section 717 of the Standard Specifications for Road and Bridge Construction, current edition, for more information concerning Material and Construction specifications.


The Department will measure the finished in-place area of Chevron Pavement Markings in Square Feet. The Department will NOT measure overlaps or the void space between the chevrons. See Section 717.04 for additional measurement information.

When listed as a bid item, the Department will make payment for the completed and accepted quantities of Chevron Pavement Markings under the following:

<u>Code</u>	<u>Pay Item</u>	<u>Pay Unit</u>
24679ED	Pave Mark Thermo Chevron	Square Foot

CROSS-HATCH PAVEMENT MARKINGS DETAIL

TYPICAL CROSS-HATCH MARKINGS

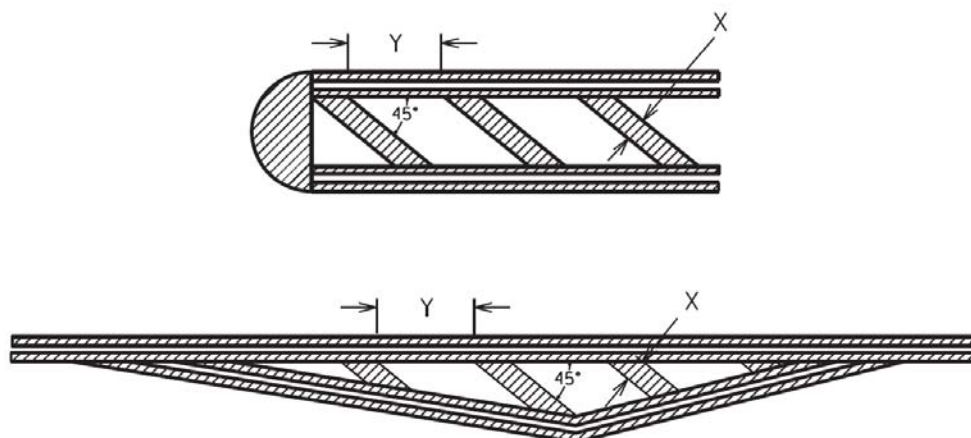

The cross-hatch pavement marking width (X) and spacing (Y) will usually be specified in the plans. The width to spacing values usually have a ratio of 1:10. If the plans do not specify the width (X) and spacing (Y) the Engineer will provide the contractor with the X and Y values for each cross-hatch installation. If necessary, the Engineer may obtain guidance from the District Traffic Engineer and/or the Division of Traffic Operations.

NOTE: Adjust the width and spacing of the cross-hatch pavement markings as necessary so that a minimum of three (3) cross-hatch markings are placed within the area being marked. The 1:10 ratio between width and spacing values should be maintained as much as possible.

Refer to Section 717 of the Standard Specifications for Road and Bridge Construction, current edition, for more information concerning Material and Construction specifications.



The Department will measure the finished in-place area of Cross-Hatch Pavement Markings in Square Feet. The Department will NOT measure overlaps or the void space between cross-hatching. See Section 717.04 for additional measurement information.

When listed in the bid items, the Department will make payment for the completed and accepted quantities of Cross-Hatch Pavement Markings under the following:


<u>Code</u>	<u>Pay Item</u>	<u>Pay Unit</u>
06569	Pave Marking-Thermo Cross-Hatch	Square Foot
23253ES717	Pave Mark TY 1 Tape Cross Hatch	Square Foot

Hardin County
Construction of J-Turns and Intersection Improvements
On US 31W Near KY 220
Item No. 4-9008.40

COUNTY OF	ITEM NO.
HARDIN	4-9008.40

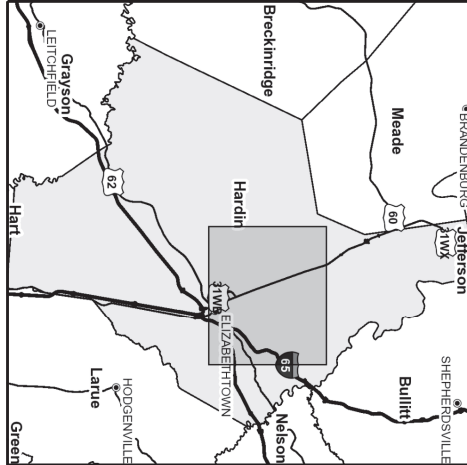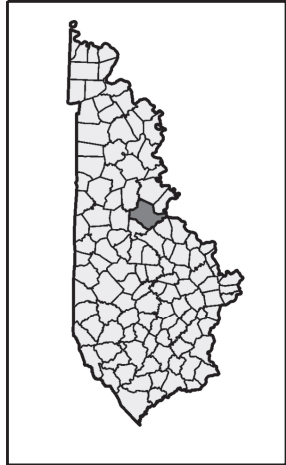


Commonwealth of Kentucky
DEPARTMENT OF HIGHWAYS
PLANS OF
PROPOSED PROJECT
HARDIN COUNTY
US 31W

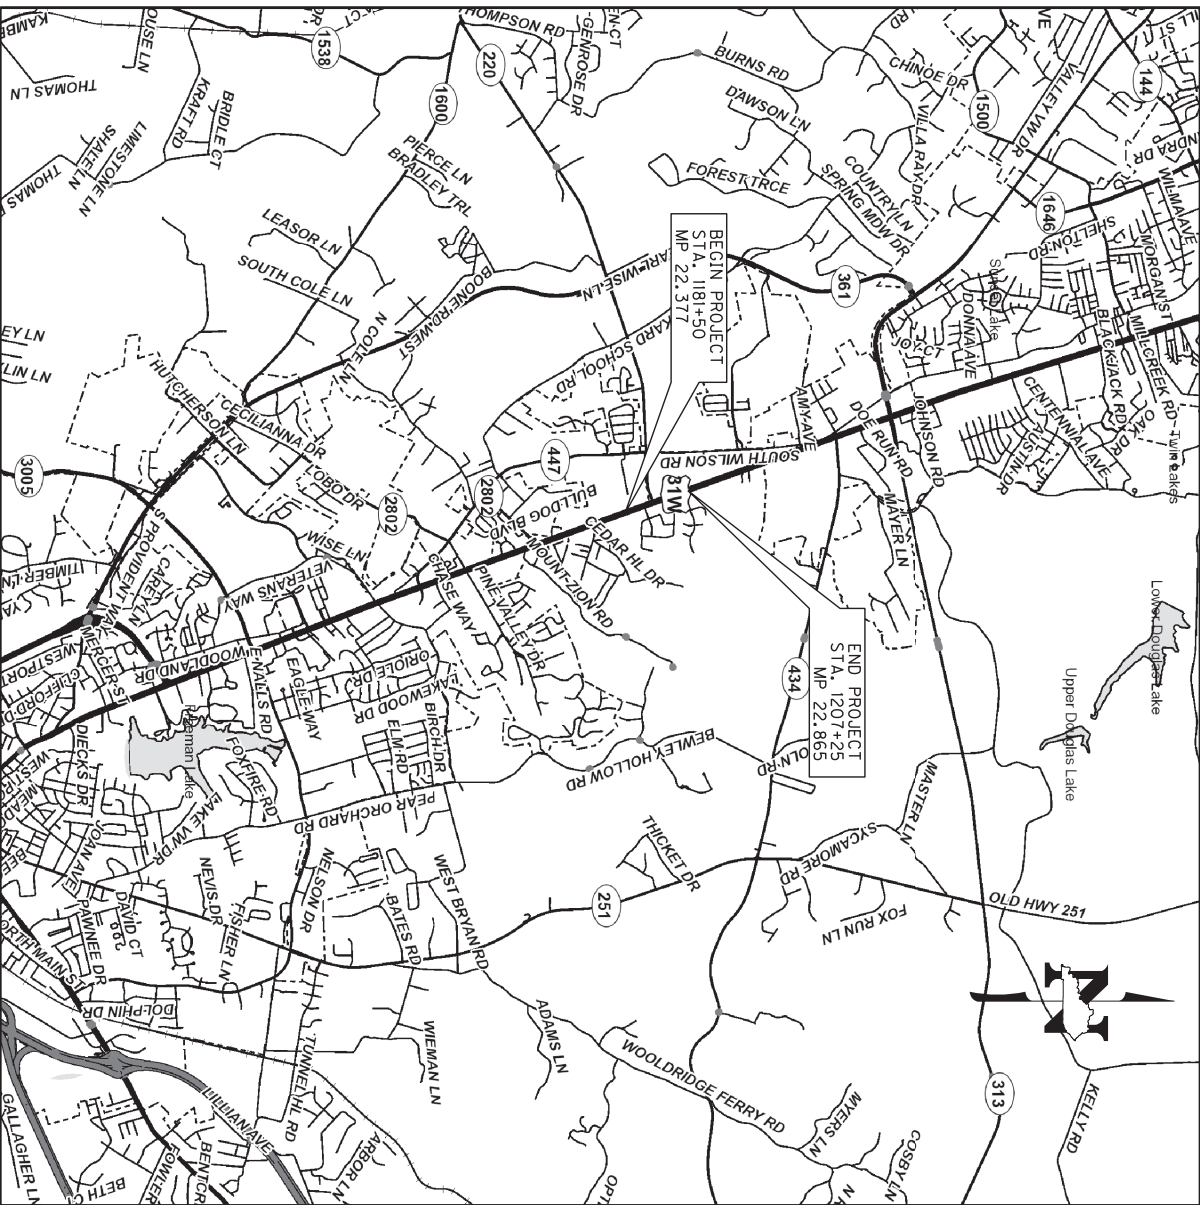

Power InRoads v8.11.9.397 E-SHEET NAME: USER: travis.m DATE PLOTTED: June 13, 2019 FILE NAME: D:\PW\WORKDIR\DM564847\TYPICAL KY220.DGN







TYPICAL SECTION AND DETAILS

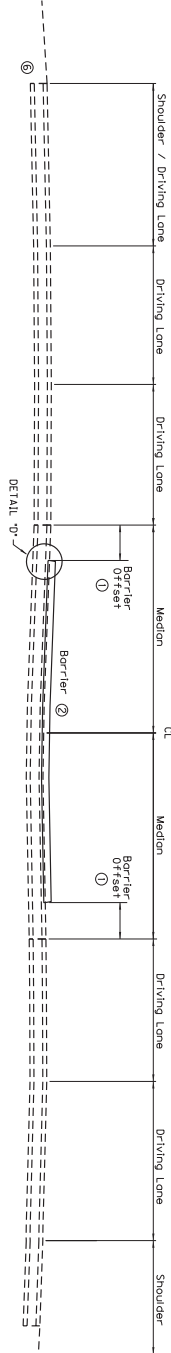

- ① 1.5" SURFACE
- ② 16.5" BASE
 - 3" DEPTH CLASS 3 ASPHALT SURFACE 0.38A PG 76-22
 - 3" DEPTH CLASS 3 ASPHALT BASE 1.00D PG 64-22
 - 3" DEPTH CLASS 3 ASPHALT BASE 1.00D PG 64-22
 - 3.5" DEPTH CLASS 3 ASPHALT BASE 1.00D PG 64-22
 - 4" COMPACTED DEPTH CRUSHED STONE BASE

US 31W BARRIER MEDIAN ON EXISTING PAVEMENT

- ① 3" TYPICAL - SEE PLANS AND DETAILS WHERE IT MAY VARY
- ② STANDARD BARRIER MEDIAN TYPE 4
- ③ SEE PLANS AND CROSS SECTIONS FOR LOCATION
- ④ SAW CUT TO BE A BID ITEM, PAVEMENT REMOVAL TO BE INCIDENTAL TO ROADWAY EXCAVATION (SEE CROSS SECTIONS)
- ⑤ ASPHALT SEAL COAT REQUIRED FROM OUTSIDE EDGE OF PAVED SHOULDER TO A POINT 2' DOWN THE DITCH OR FILL SLOPE.
- ⑥ 20 LB/5Y ASPHALT SEAL, ADORECAT (TWO APPLICATIONS).
- ⑦ BASED ON RECORD PLANS, THE EXISTING PAVEMENT DEPTH IS APPROXIMATELY 18.75" THICK. THE PROPOSED PAVEMENT DESIGN AS SHOWN IS 18" IF FIELD ADJUSTMENTS MAY BE MADE BY THE ENGINEER TO BEST MATCH THAT THICKNESS.
- ⑧ ENTRANCE RECONSTRUCTION PAVEMENT TO MATCH MAINLINE FULL DEPTH PAVEMENT
- ⑨ STA. 1203+50 TO STA. 1205+50
- ⑩ SEE CROSS SECTIONS FOR SIDE SLOPES AND DITCH ELEVATIONS
- ⑪ SEE PLANS AND DETAILS WHERE IT MAY VARY.
- ⑫ MATCH EXISTING DRIVING LANE BUT NOT LESS THAN 2.000'

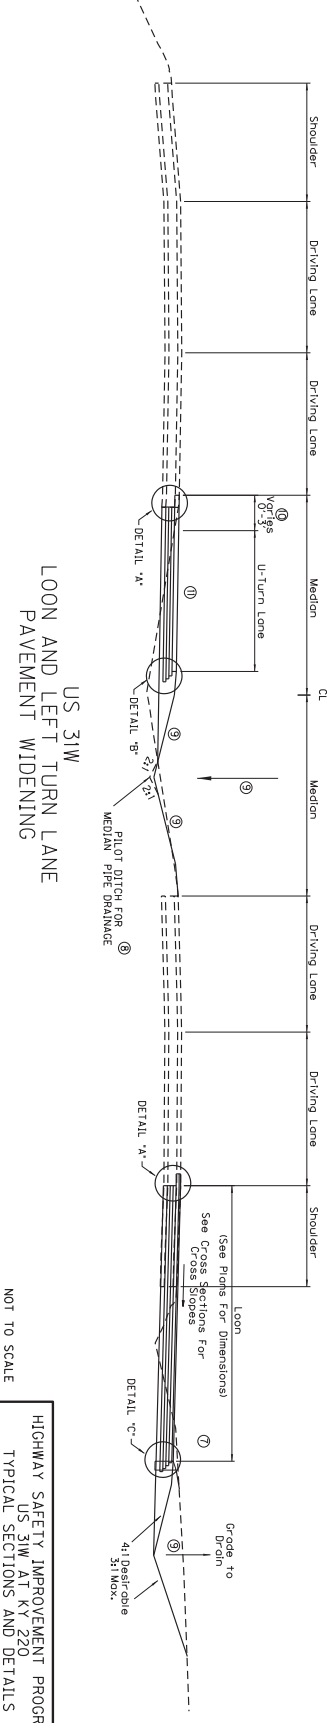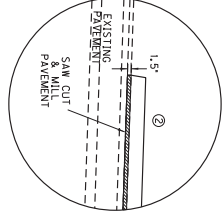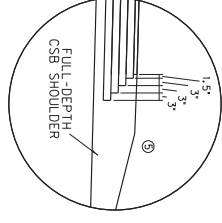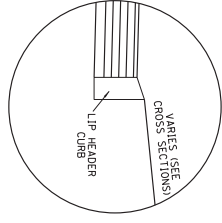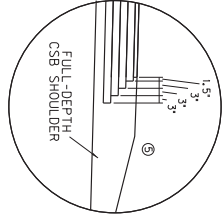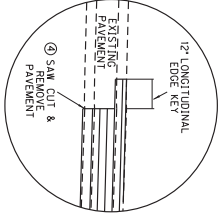

US 31W LOON AND LEFT TURN LANE PAVEMENT WIDENING

NOT TO SCALE


HIGHWAY SAFETY IMPROVEMENT PROGRAM
US 31W AT KY 220
TYPICAL SECTIONS AND DETAILS

COUNTY OF	ITEM NO.	SHEET NO.
HARDIN	4-9008.40	




Power InRoads v8.11.9.397 E-SHEET NAME: USER: travis-m DATE PLOTTED: June 13, 2019 FILE NAME: D:\PW\WORKDIR\DM564847\TYPICAL KY220.DGN

TYPICAL SECTION AND DETAILS

COUNTY OF	ITEM NO.	SHEET NO.
HARDIN	4-9008-40	

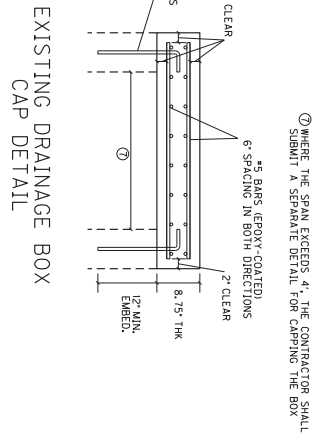

PROPOSED DRAINAGE INLETS AND BARRIER CONSTRUCTION





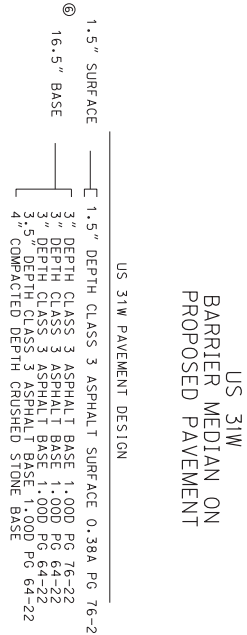
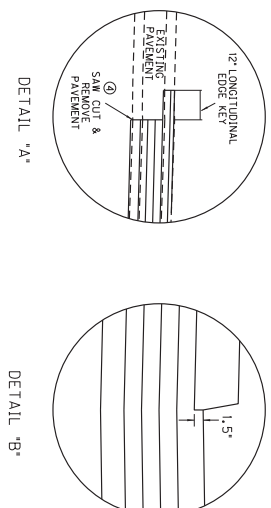
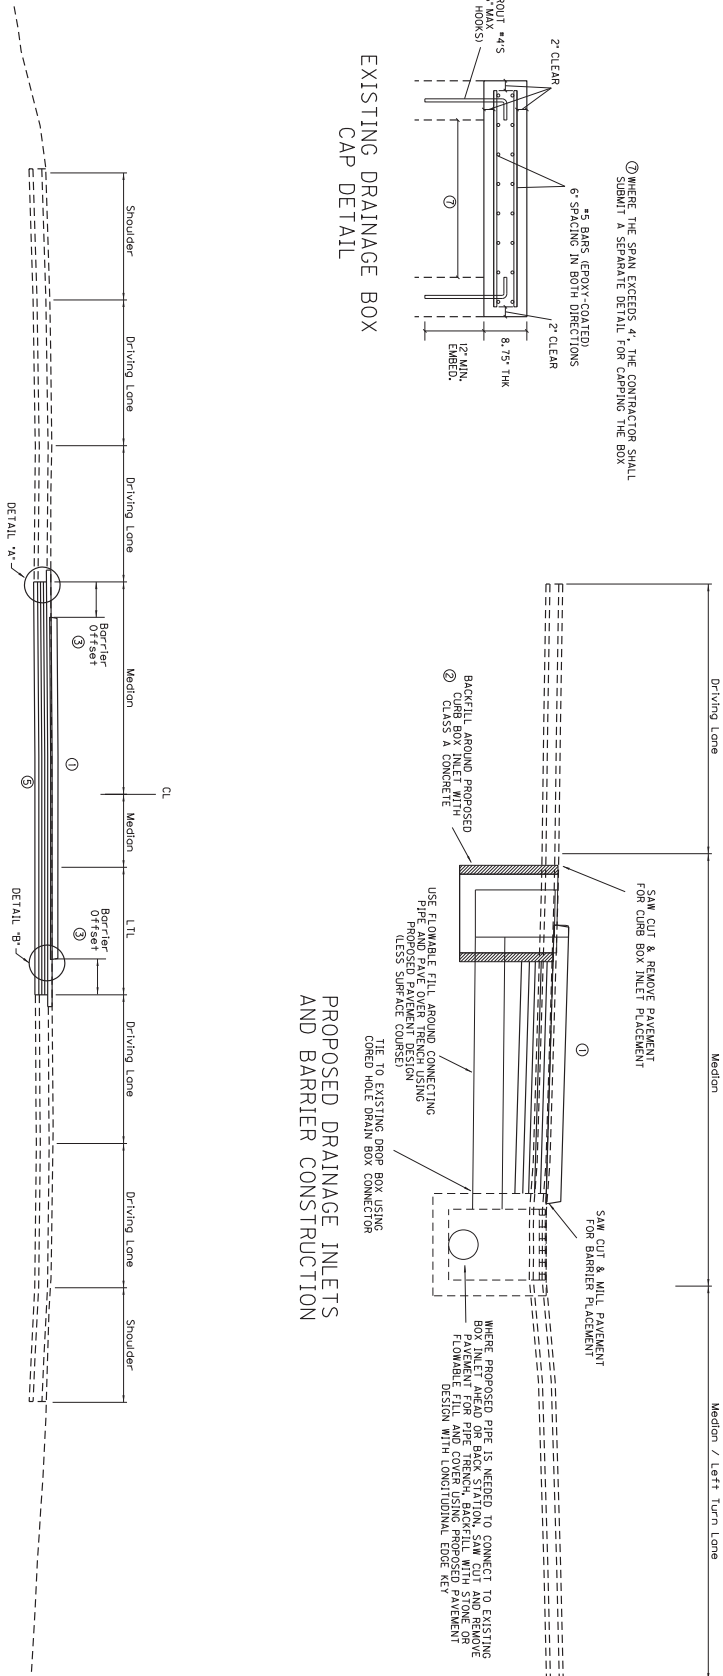


- ① STANDARD BARRIER MEDIAN TYPE 2 ON EXISTING PAVEMENT & TYPE 2 ON NEW PAVEMENT
- ② CONCRETE QUANTITIES TO BE INCIDENTAL TO BID ITEM ON CURB BOX INLETS
- ③ TYPICAL - SEE PLANS AND DETAILS WHERE IT MAY VARY
- ④ SAW CUT TO BE A BID ITEM PAVEMENT REMOVAL (SEE CROSS SECTIONS)
- ⑤ AT THE DISCRETION OF THE ENGINEER, PERFORATED PIPE MAY BE REQUIRED AT MEDIAN CROSSOVERS DRAIN TO BE INSTALLED OUTSIDE OF OTHER TYPICAL SECTIONS FOR DETAILS.
- ⑥ BASED ON RECORD PLANS, THE EXISTING PAVEMENT DEPTH IS APPROXIMATELY 18" THICK. THE PROPOSED PAVEMENT DESIGN THICKNESS TO BE SIGNIFICANTLY DIFFERENT. ADJUSTMENTS MAY BE MADE BY THE ENGINEER TO BEST MATCH THAT THICKNESS.

NOT TO SCALE
HIGHWAY SAFETY IMPROVEMENT PROJECT
US 31W AT KY 220
TYPICAL SECTIONS AND DETAILS

TYPICAL SECTION AND DETAILS

COUNTY OF	ITEM NO.	SHEET NO.
HARDIN	4-9008.40	

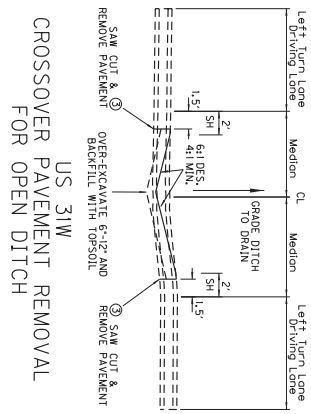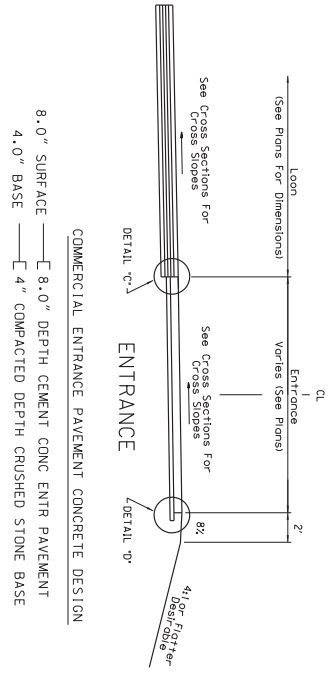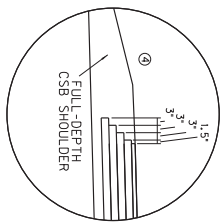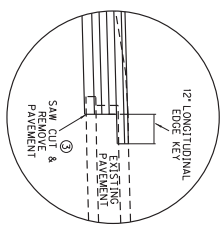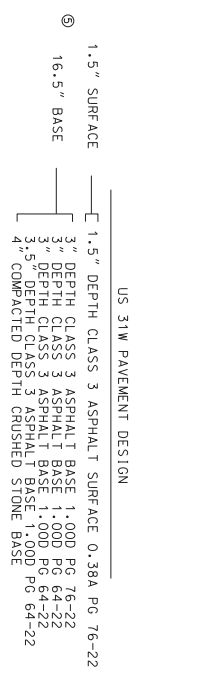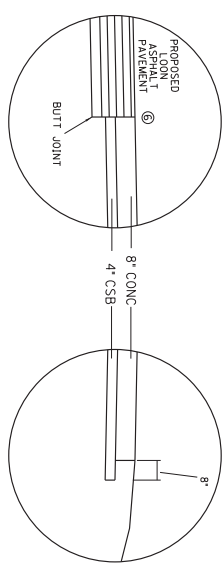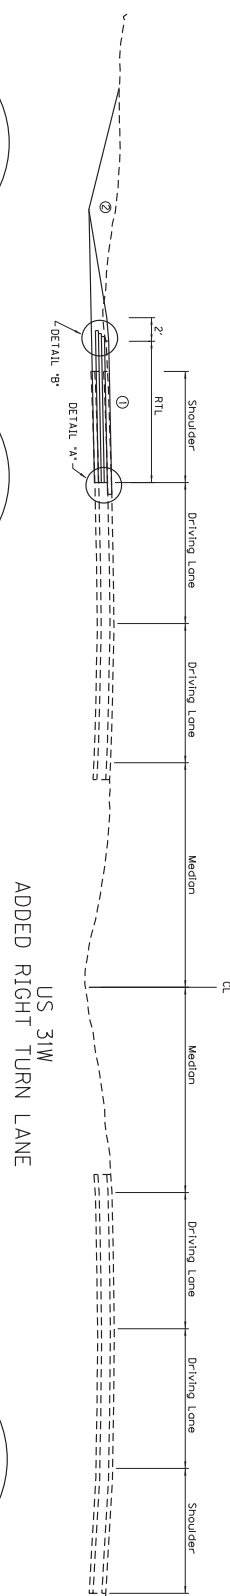

- ① MATCH EXISTING DRIVING LANE BUT NOT LESS THAN 2.00X
- ② SEE CROSS SECTIONS FOR SIDE SLOPES AND DITCH ELEVATIONS
- ③ SAW CUT TO BE A BID ITEM PAVEMENT REMOVAL TO BE INCIDENTAL TO ROADWAY EXCAVATION (SEE CROSS SECTIONS)
- ④ ASPHALT SEAL COAT REQUIRED FROM OUTSIDE EDGE OF PAVED SHOULDER TO INSIDE EDGE OF DITCH OR FULL SLOPE. 20 LB/5Y ASPHALT SEAL AGGREGATE (TWO APPLICATIONS).
- ⑤ BASED ON RECORD PLANS, THE EXISTING PAVEMENT DEPTH IS APPROXIMATELY 15.75\"/>

HIGHWAY SAFETY IMPROVEMENT PROJECT
US 31W AT KY 220
TYPICAL SECTIONS AND DETAILS
NOT TO SCALE

GENERAL SUMMARY

ITEM	DESCRIPTION	UNIT	TOTAL PROJECT
1886	UR ADDRESS CURB	LF	89
1917	STANDARD BARRIER MEDIAN TY 2	SO.YD	53
1921	STANDARD BARRIER MEDIAN TY 4	SO.YD	630
2159	TEMPORARY DITCH	LF	625
2160	CLEAN TEMPORARY DITCH	LF	313
2200	ROADWAY EXCAVATION	CU.YD	1250
2242	WATER	MG GAL	37
2545	CLEANING AND GRUBBING	LS	1
2562	TEMPORARY SIGNS	SQ.FT	213
2600	FABRIC/GEOTEXTILE TYRE W/FOR PIPE	SO.YD	911
2650	MAINTAIN AND CONTROL TIERIFIC	LS	1
2671	PORTABLE CHANGABLE MESSAGE SIGNS	EACH	2
2676	MOBILIZATION FOR MAIL & TEXT	LS	1
2677	ASPHALT PAVE MILLING & TEXTURING	TON	52
2701	TEMPORARY SILT FENCE	LF	625
2703	SILT TRAP TYPE A	EACH	1
2704	SILT TRAP TYPE B	EACH	3
2706	CLEAN SILT TRAP TYPE A	EACH	10
2707	CLEAN SILT TRAP TYPE B	EACH	3
2708	CLEAN SILT TRAP TYPE C	EACH	10
2726	STAKING	LS	1
2775	ARROW PAWEL	EACH	2
5950	EROSION CONTROL BLANKET	SO.YD	1288
5952	TEMPORARY MULCH	SO.YD	2788
5953	TEMP SEEDING AND PROTECTION	TON	2091
5954	MAINTENANCE FERTILIZER	TON	0.28
5985	SEEDING AND PROTECTION	SO.YD	4182
5992	AGRICULTURAL LIMESTONE	TON	3.41
6530	PAVEMENT STRIPING REMOVAL 4 INCH	LF	1902
6569	PAVEMENT MARKING THERMO CROSS-HATCH	SO.FT	114
6574	PAVEMENT MARKING THERMO CURVE ARROW	EACH	13
6576	PAVEMENT MARKING THERMO "OW"*	EACH	1
6577	PAVEMENT MARKING REMOVAL	CU.YD	233
6578	FILL PATCH MARKING REMOVAL	DOLLAR	7638
1003ONS	ASPHALT ADJUSTMENT	DOLLAR	7638
2055OND	SAW CUT PAVEMENT	LF	1933
21398RD	LONGITUDINAL EDGE KEY	LF	1811
24498RC	INLAND PAVEMENT MARKERS	EACH	33
24678DC	PAVE MARK THERMO CHEVRON	SO.FT	63
24838DC	PREPARE INSPECTOR	LF	672
24958SD	REMOVE SIGNAL EQUIPMENT	EACH	141
24968SD	REMOVE SIGNAL EQUIPMENT	LF	141
24988C	PAVE STRIPING STRAY THERMO 6 IN Y	LF	1433
25228RTJF	TIRE REINFORCEMENT MAT 1	SO.YD	120

PAVING AREAS

ITEM	LEFT TURN & U-TURN LANES ⓐ	LOONS & RIGHT TURN LANES ⓑ	ENTRANCES	TOTAL PROJECT		
				ENTRANCES	TOTAL PROJECT	SQUARE YARDS
1.5" CL 3 ASPHALT SURFACE 0.38A PG 76-22	1551	1105		2656		
3.0" CL 3 ASPHALT BASE 1.00D PG 76-32	1564	1112		2676		
3.0" CL 3 ASPHALT BASE 1.00D PG 64-22	1467	1056		2523		
3.5" CL 3 ASPHALT BASE 1.00D PG 64-22	1483	1070		2553		
3.5" CL 3 ASPHALT BASE 1.00D PG 64-22	1510	1085		2595		
4.0" CRUSHED STONE BASE	1541	1101		2789		
LEVELING & WEDGING PG 64-22	10	10		20		
ASPHALT SEAL COAT	372	224		596		
ASPHALT SEAL AGGREGATE	372	224		596		
ASPHALT MATERIAL FOR TACK NON-TRACKING	6055	4343		10398		

PAVING QUANTITIES


ITEM CODE	ITEM	UNIT	LEFT TURN & U-TURN LANES ⓐ	LOONS & RIGHT TURN LANES ⓑ	ENTRANCES	TOTAL PROJECT
336	CL 3 ASPHALT SURFACE 0.38A PG 76-22	TON	128	91		219
216	CL 3 ASPHALT BASE 1.00D PG 76-32	TON	258	183		442
214	CL 3 ASPHALT BASE 1.00D PG 64-22	TON	776	560		1335
2101	CEM CONC CRT PAVEMENT 8 IN	SO.YD		140		140
3	CRUSHED STONE BASE	TON	772	474		1284
103	ASPHALT SEAL COAT	TON	0.9	0.5		1.4
100	ASPHALT SEAL AGGREGATE	TON	7.4	4.5		11.9
24978DC	ASPHALT MATERIAL FOR TACK NON-TRACKING	TON	1.5	1.1		2.6
190	LEVELING & WEDGING PG 64-22	TON	1	1		2

- APPROXIMATELY 0.85 ACRES
- FOR PREPARATION OF STANDARD BARRIER MEDIAN TYPE 4 CONSTRUCTION
- FOR THE REMOVAL OF ALL STRIPING AND MARKING THAT WILL CONFLICT WITH FUTURE PROPOSED TRAFFIC PATTERNS OR PROPOSED MARKINGS
- FOR ALL LOCATIONS OF PAVEMENT MILLING, WIDENING, OR REPLACEMENT (SEE ALSO TYPICAL SECTIONS AND DETAILS)
- FOR ALL LOCATIONS OF PAVEMENT WIDENING OR REPLACEMENT (SEE ALSO TYPICAL SECTIONS AND DETAILS)
- FOR CONTROLLING DUST CAUSED BY MAINTAINING TRAFFIC ONLY; ESTIMATED AT 75 MGAL PER MILE
- EARTHWORK QUANTITIES ARE APPROXIMATE AND FOR INFORMATION ONLY
- EARTHWORK QUANTITIES:
 - COMMON EMBANKMENT 1250 CY
 - COMMON CUT 282 CY
- TO INCLUDE REMOVAL OF POLES, EQUIPMENT AND CONCRETE BASES, CONCRETE BASES TO BE REMOVED TO 12 INCHES BELOW EXISTING GROUND LINE, DELIVER TO VALLEY ROAD, GIBSON TWP, ELIZABETH TOWN, KY 42701
- BEFORE DELIVERING, CONTACT JAKE RIGGS: (270) 401-8132
- PROJECT QUANTITY PROGRAMED BASED ON PERCENTAGE OF ASPHALT FROM TOTAL ASPHALT OF KI 220, KI 234, AND BLACKBARK ROAD PROJECTS

HIGHWAY SAFETY IMPROVEMENT PROJECT
US 31W AT KY 220
GENERAL SUMMARY

COUNTY OF HARDIN
ITEM NO. 4-9008.40
SHEET NO.

POWER INROADS v8.11.9.397
E-SHEET NAME: USER: tyrovs-m DATE PLOTTED: June 20, 2019
FILE NAME: D:\PW\WORKDIR\DM564846\KY220 GENERAL SUMMARY.DGN

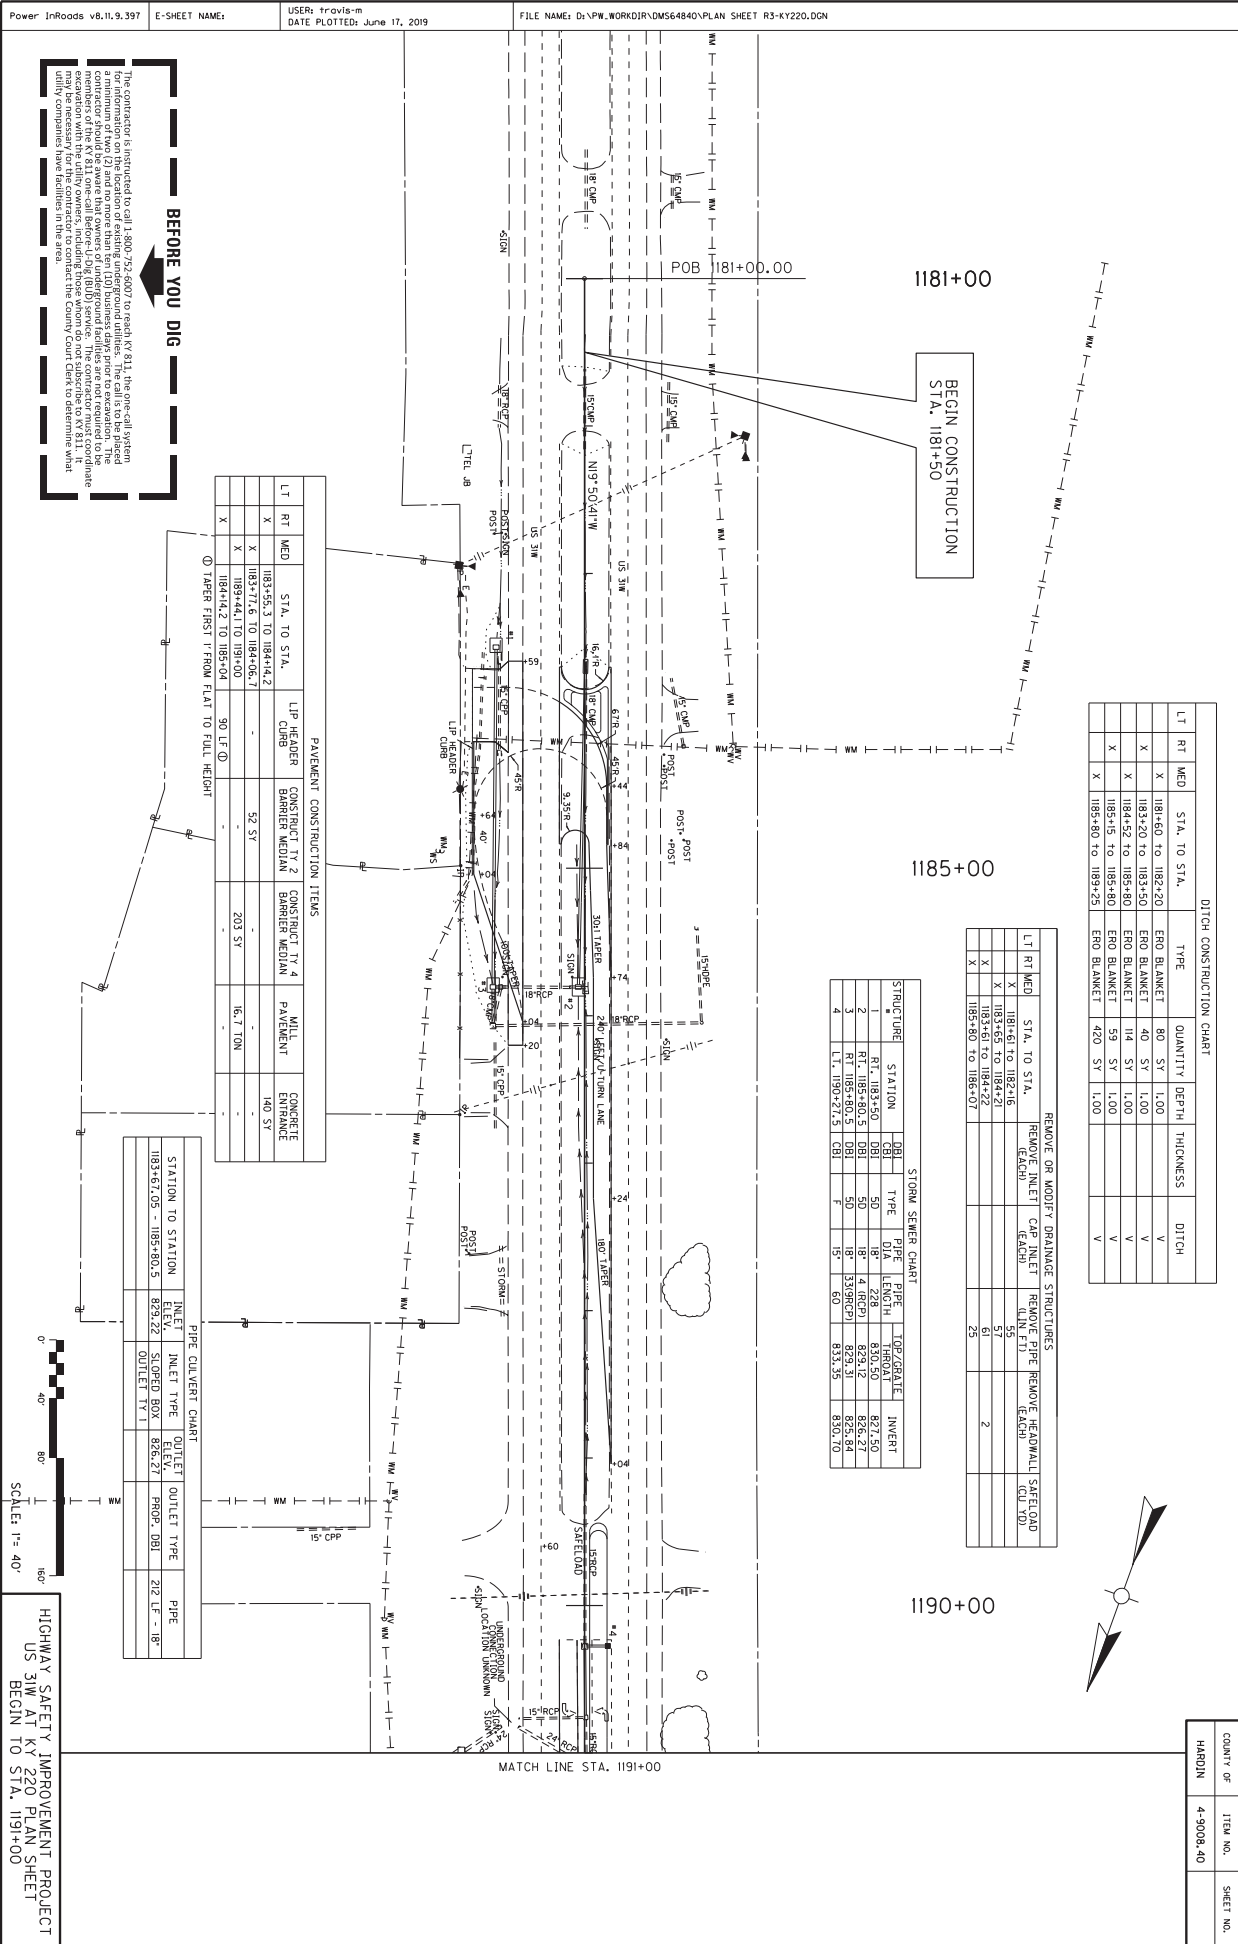

BEFORE YOU DIG

The contractor is instructed to call 1-800-752-6007 to reach KY 811. The one-call system is a minimum of two (2) and no more than ten (10) business days prior to excavation. The contractor should advise the utility owners of any proposed excavation and obtain their consent. The contractor should also advise the utility owners of any proposed excavation and obtain their consent. The contractor should also advise the utility owners of any proposed excavation and obtain their consent. The contractor should also advise the utility owners of any proposed excavation and obtain their consent.

LT	RT	MED	STA. TO STA.	LIP HEADER CURB	CONSTRUCT TY 2 BARRIER MEDIAN	CONSTRUCT TY 4 BARRIER MEDIAN	WHL PAVEMENT	CONCRETE ENTRANCE
X	X	X	1183+55.3 TO 1184+4.2					
X	X	X	1183+71.6 TO 1184+06.7	52 SY				
X	X	X	1183+44.1 TO 1191+00		203 SY		16.7 TON	
X	X	X	1184+4.2 TO 1185+04	90 LF				

① TAPER FIRST 'V' FROM FLAT TO FULL HEIGHT

STATION TO STATION	INLET	INLET TYPE	OUTLET	OUTLET TYPE	PIPE
1183+67.05 - 1185+80.5	829.22	SLOPED BOX	826.27	PROP. DBL	27" LF - 18"
		OUTLET TY 1			

STRUCTURE	STATION	DBL	DBL	TYPE	PIPE	TOP/GRATE	INVERT
1	RT, 1183+50	DBL	50	18"	4 (RCP)	829.12	826.27
2	RT, 1185+80.5	DBL	50	18"	4 (RCP)	829.31	826.84
3	RT, 1185+80.5	DBL	50	18"	4 (RCP)	829.31	826.84
4	LT, 1185+21.5	DBL	15	60"		835.35	830.10


LT	RT	MED	STA. TO STA.	REMOVE INLET (EACH)	CAP INLET (EACH)	REMOVE PIPE (LN FT)	REMOVE HEADWALL SAFELAND (CY YD)
X	X	X	1181+61 TO 1182+16	53		53	
X	X	X	1183+61 TO 1184+22	61		61	
X	X	X	1185+80 TO 1186+07	25		25	

LT	RT	MED	STA. TO STA.	TYPE	QUANTITY	DEPTH	THICKNESS	DITCH
X	X	X	1181+60 TO 1182+20	ENO BLANKET	80 SY	1.00		V
X	X	X	1183+20 TO 1183+50	ENO BLANKET	40 SY	1.00		V
X	X	X	1184+52 TO 1185+80	ENO BLANKET	114 SY	1.00		V
X	X	X	1185+15 TO 1185+80	ENO BLANKET	59 SY	1.00		V
X	X	X	1185+80 TO 1189+25	ENO BLANKET	420 SY	1.00		V

HIGHWAY SAFETY IMPROVEMENT PROJECT
US 31W AT KY 220 PLAN SHEET
BEGIN TO STA. 1191+00

COUNTY OF
HARDIN
ITEM NO.
4-9008.40
SHEET NO.

Power InRoads v8.11.9.397 E-SHEET NAME: USER: travis-m DATE PLOTTED: December 3, 2018 FILE NAME: D:\PW_WORKDIR\DM564840\PLAN SHEET R4-KY220.DGN

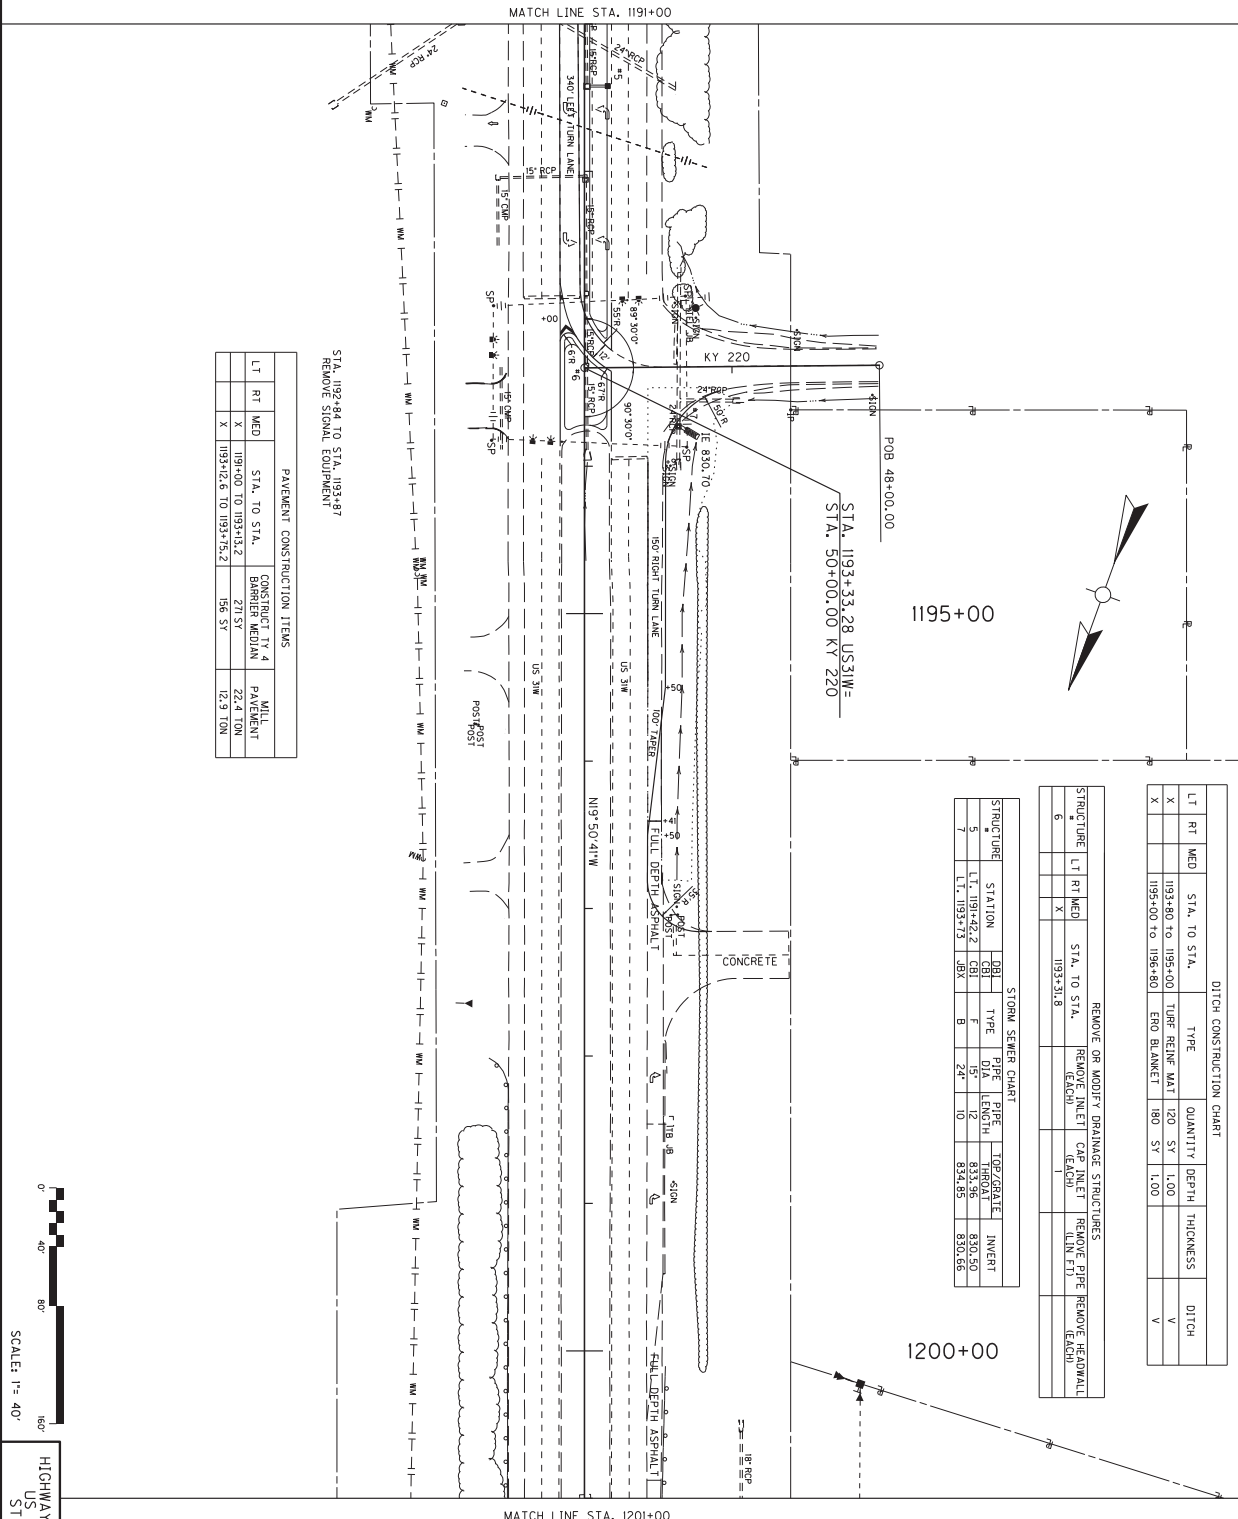

STA. 1192+84 TO STA. 1193+87
REMOVE SIGNAL EQUIPMENT

LT	RT	MED	STA. TO STA.	CONSTRUCT	TY	PAVEMENT
X			1194+00 TO 1193+15.2	271 SY	4	22.4 TON
X			1193+12.6 TO 1193+15.2	156 SY		12.9 TON

PAVEMENT CONSTRUCTION ITEMS

REMOVE OR MODIFY DRAINAGE STRUCTURES


STRUCTURE	LT	RT	MED	STA. TO STA.	REMOVE INLET (EACH)	CAP INLET (EACH)	REMOVE PIPE (EACH)	REMOVE HEADWALL (EACH)
6			X	1193+31.8		1		

STORM SEWER CHART

STRUCTURE	STATION	RT	TYPE	PIPE DIA.	LENGTH	TOP/2821E	INVERT
5	L.I. 1191+42.2	CB	F	15"	12'	833.96	830.50
7	L.I. 1193+73	ABX	B	24"	10'	834.85	830.66

DITCH CONSTRUCTION CHART

LT	RT	MED	STA. TO STA.	TYPE	QUANTITY	DEPTH	THICKNESS	DITCH
X			1193+80 TO 1193+00	TURF REINF MAT	120 ST	1.00		V
X			1195+00 TO 1194+80	ERO BLANKET	180 ST	1.00		V

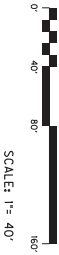


HIGHWAY SAFETY IMPROVEMENT PROJECT
US 31W AT KY 220 PLAN SHEET
STA. 1191+00 TO STA. 1201+00

COUNTY OF	ITEM NO.	SHEET NO.
HARDIN	4-9008.40	

Power InRoads v8.11.9.397 E-SHEET NAME: USER: jody-b DATE PLOTTED: December 3, 2018 FILE NAME: D:\PW_WORKDIR\DM564840\PLAN SHEET R5-KY220.DGN

MATCH LINE STA. 1201+00

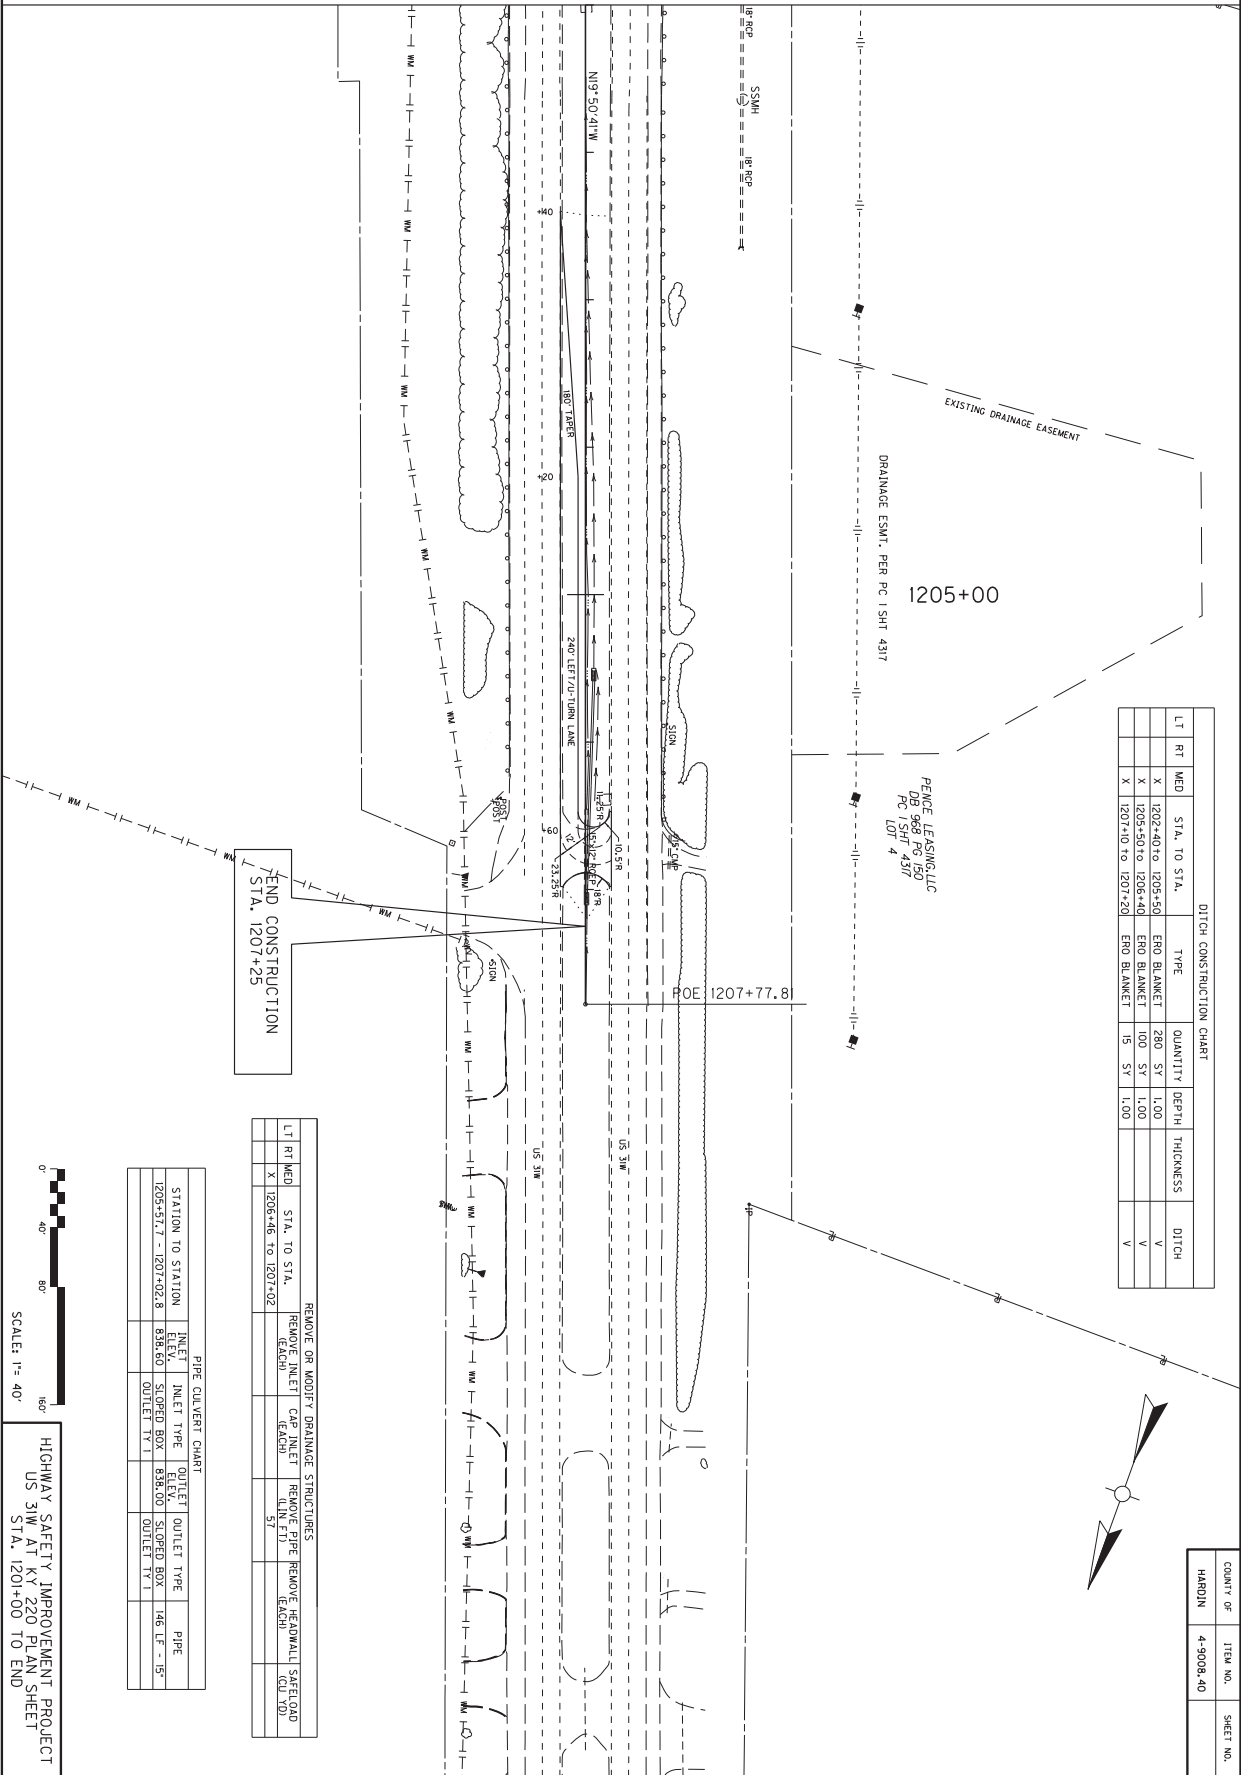

DITCH CONSTRUCTION CHART

LT	RT	MED	STA. TO STA.	TYPE	QUANTITY	DEPTH	THICKNESS	DITCH
		X	1202+40 to 1205+50	ENO BLANKET	280 SY	1.00		V
		X	1205+50 to 1206+40	ENO BLANKET	100 SY	1.00		V
		X	1201+10 to 1201+20	ENO BLANKET	10 SY	1.00		V

END CONSTRUCTION
STA. 1207+25

REMOVE OR MODIFY DRAINAGE STRUCTURES

LT	RT	MED	STA. TO STA.	REMOVE DITCH	REMOVE CATCH	REMOVE MANHOLE	REMOVE STRUCTURE
		X	1206+46 to 1207+02			57	


PIPE CULVERT CHART

STATION TO STATION	INLET ELEV.	INLET TYPE	OUTLET ELEV.	OUTLET TYPE	PIPE
1205+51.7 - 1207+02.8	838.80	SLOPED BOX	838.00	SLOPED BOX	146 LF - 15"
		OUTLET TY 1		OUTLET TY 1	




HIGHWAY SAFETY IMPROVEMENT PROJECT
US 31W AT KY 220 PLAN SHEET
STA. 1201+00 TO END

COUNTY OF	ITEM NO.	SHEET NO.
HARDIN	4-9008.40	

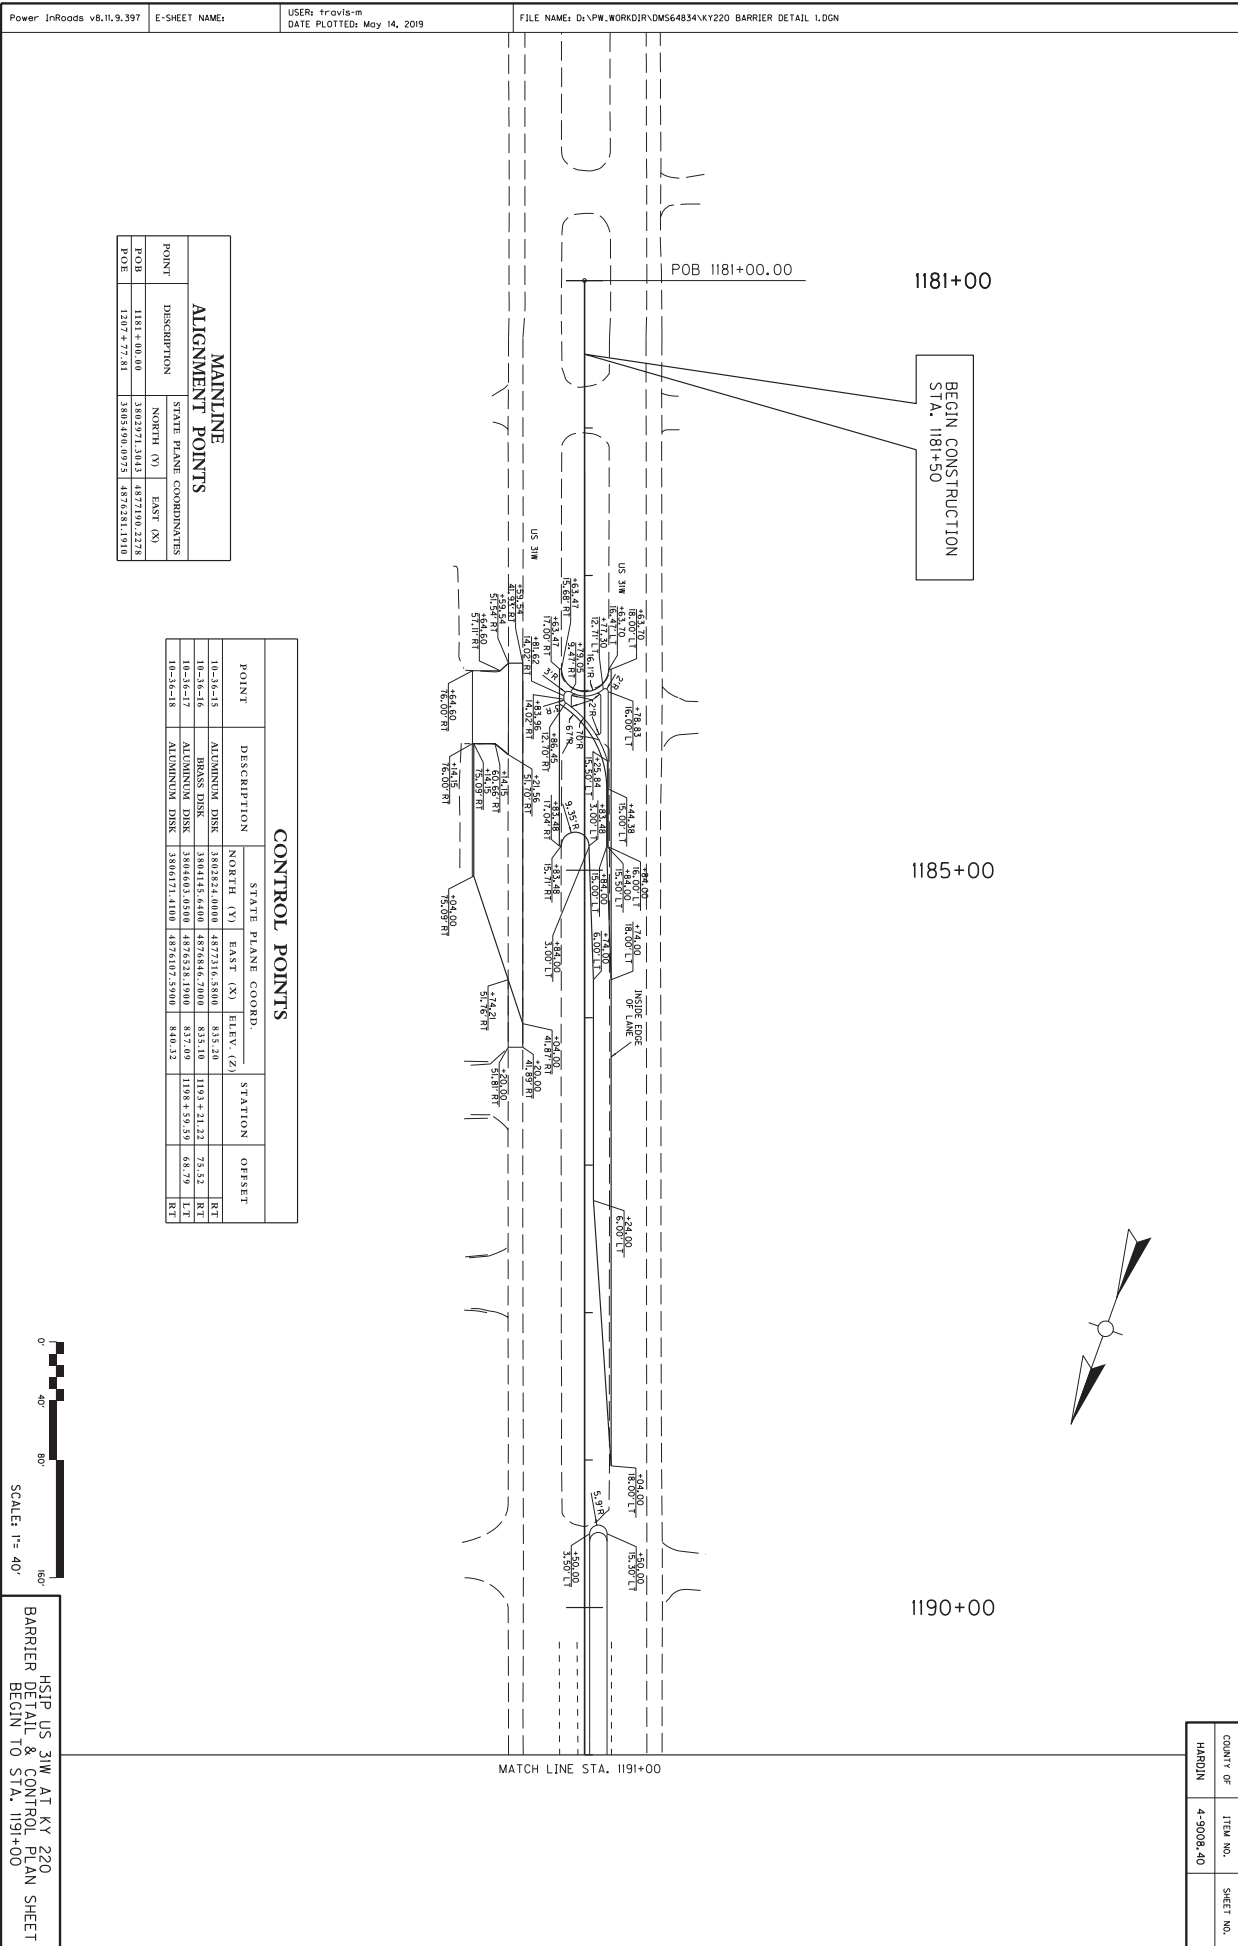

MAINLINE ALIGNMENT POINTS			
POINT	DESCRIPTION	NORTH (N)	EAST (E)
POB	1181+00.00	3802971.5843	4872190.2228
POE	1207+27.51	3805490.0975	4872281.1910


CONTROL POINTS						
POINT	DESCRIPTION	NORTH (N)	EAST (E)	ELEV. (Z)	STATION	OFFSET
10-16-45	ALUMINUM DISK	3802321.0000	4872116.5800	835.20		RT
10-16-46	BROSS DISK	3804142.6400	4872846.2000	835.40	1193+21.22	RT
10-16-47	ALUMINUM DISK	3804603.0500	4872528.1900	837.09	1198+59.59	L.T
10-16-48	ALUMINUM DISK	3804171.4100	4872107.2900	840.32		RT

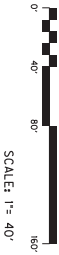

HSIP US 31W AT KY 220
BARRIER DETAIL & CONTROL PLAN SHEET
BEGIN TO STA. 1191+00


COUNTY OF	ITEM NO.	SHEET NO.
HARDIN	4-9008.40	

Power InRoads v8.11.9.397 E-SHEET NAME: USER: travis-m DATE PLOTTED: June 17, 2019 FILE NAME: D:\PW\WORKDIR\DM564834\KY220 BARRIER DETAIL 2.DGN

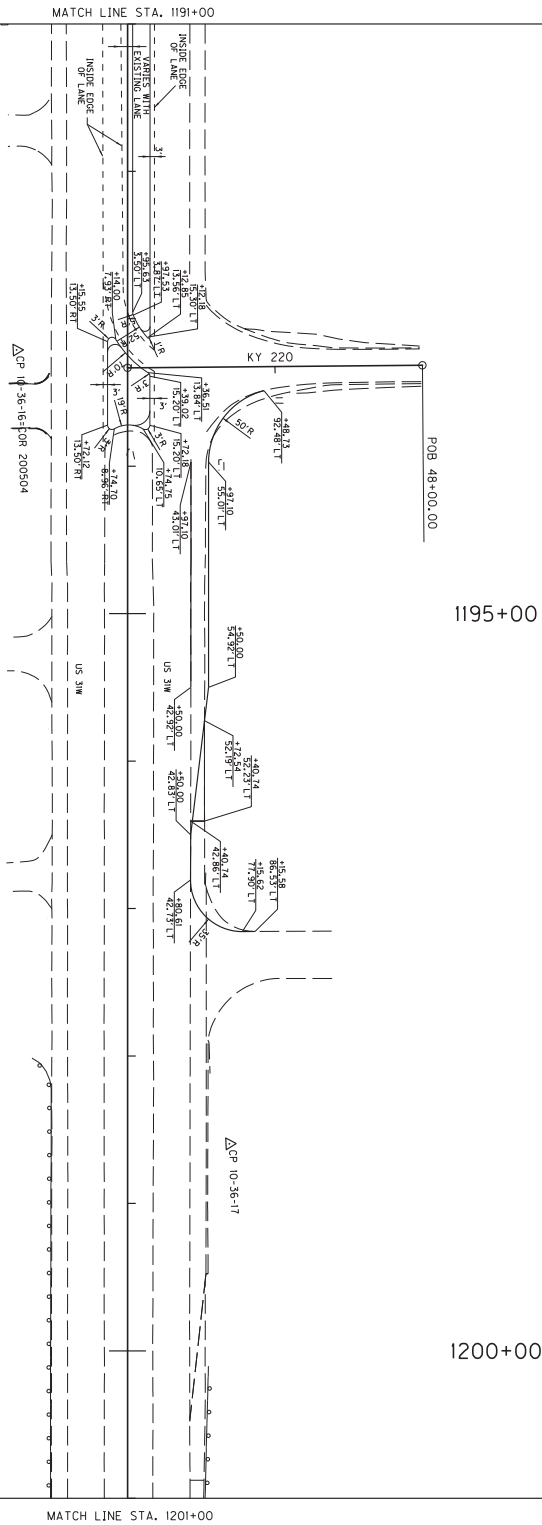

MAINLINE ALIGNMENT POINTS			
POINT	DESCRIPTION	STATE PLANE COORDINATES	
		NORTH (Y)	EAST (X)
POB	1181+00.00	3802971.3043	4877190.2278
POE	1207+77.81	3805490.0975	4876281.1910
KY 220			
POB	48+00.00	3804001.5098	4876584.0361
POE	50+00.00	3804131.3429	4876771.5528

CONTROL POINTS						
POINT	DESCRIPTION	STATE PLANE COORD.			STATION	OFFSET
		NORTH (Y)	EAST (X)	ELEV. (Z)		
10-36-15	ALDWINSON DSK	3802824.0000	4877316.5800	835.30	1193+21.22	75.52 RT
10-36-16	BIRNAS DSK	3804145.6400	4876846.7000	835.10	1193+21.22	75.52 RT
10-36-17	ALDWINSON DSK	3804603.0500	4876528.1900	837.09	1198+50.59	68.79 LT
10-36-18	ALDWINSON DSK	3806171.4100	4876107.5900	840.32		

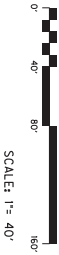


HSIP US 31W AT KY 220
BARRIER DETAIL & CONTROL PLAN SHEET
STA. 1191+00 TO STA. 1201+00

COUNTY OF	ITEM NO.	SHEET NO.
HARDIN	4-9008.40	

Power InRoads v8.11.9.397 E-SHEET NAME: USER: travis-m DATE PLOTTED: August 30, 2018 FILE NAME: D:\PW_WORKDIR\DM564834\KY220 BARRIER DETAIL 3.DGN

MATCH LINE STA. 1201+00

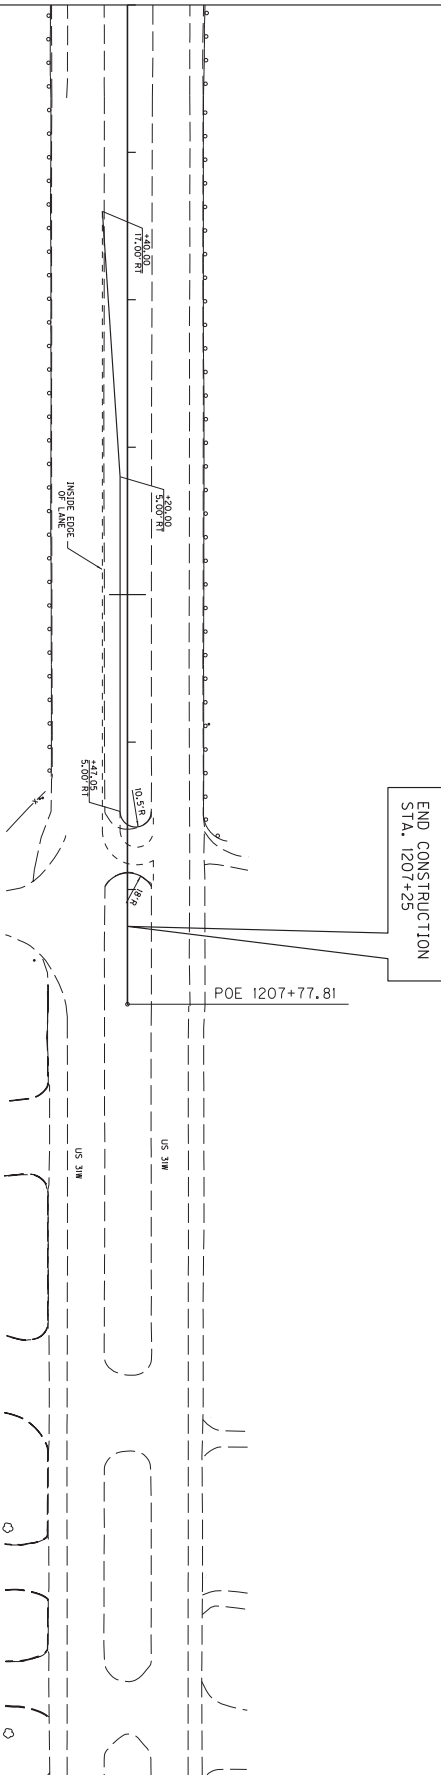

1205+00


MAINLINE ALIGNMENT POINTS			
POINT	DESCRIPTION	STATE PLANE COORDINATES	
		NORTH (N)	EAST (E)
POB	1181+10.00	3802971.3043	4877190.2278
POE	1207+77.81	3802490.0975	4876281.1910

CONTROL POINTS			
POINT	DESCRIPTION	STATE PLANE COORD.	STATION
		NORTH (N) EAST (E) ELEV. (Z)	
10+56.15	ALIGNMENT DISK	3802824.0000 4877216.5800	833.26
10+56.16	BARRIS DISK	3804145.6400 4876846.7000	833.10
10+56.17	ALIGNMENT DISK	3804603.0500 4876528.1900	837.09
10+56.18	ALIGNMENT DISK	3806771.4100 4876107.5900	840.33



HSIP US 31W AT KY 220
BARRIER DETAIL & CONTROL PLAN SHEET
STA. 1201+00 TO END

COUNTY OF	ITEM NO.	SHEET NO.
HARDIN	4-9008.40	

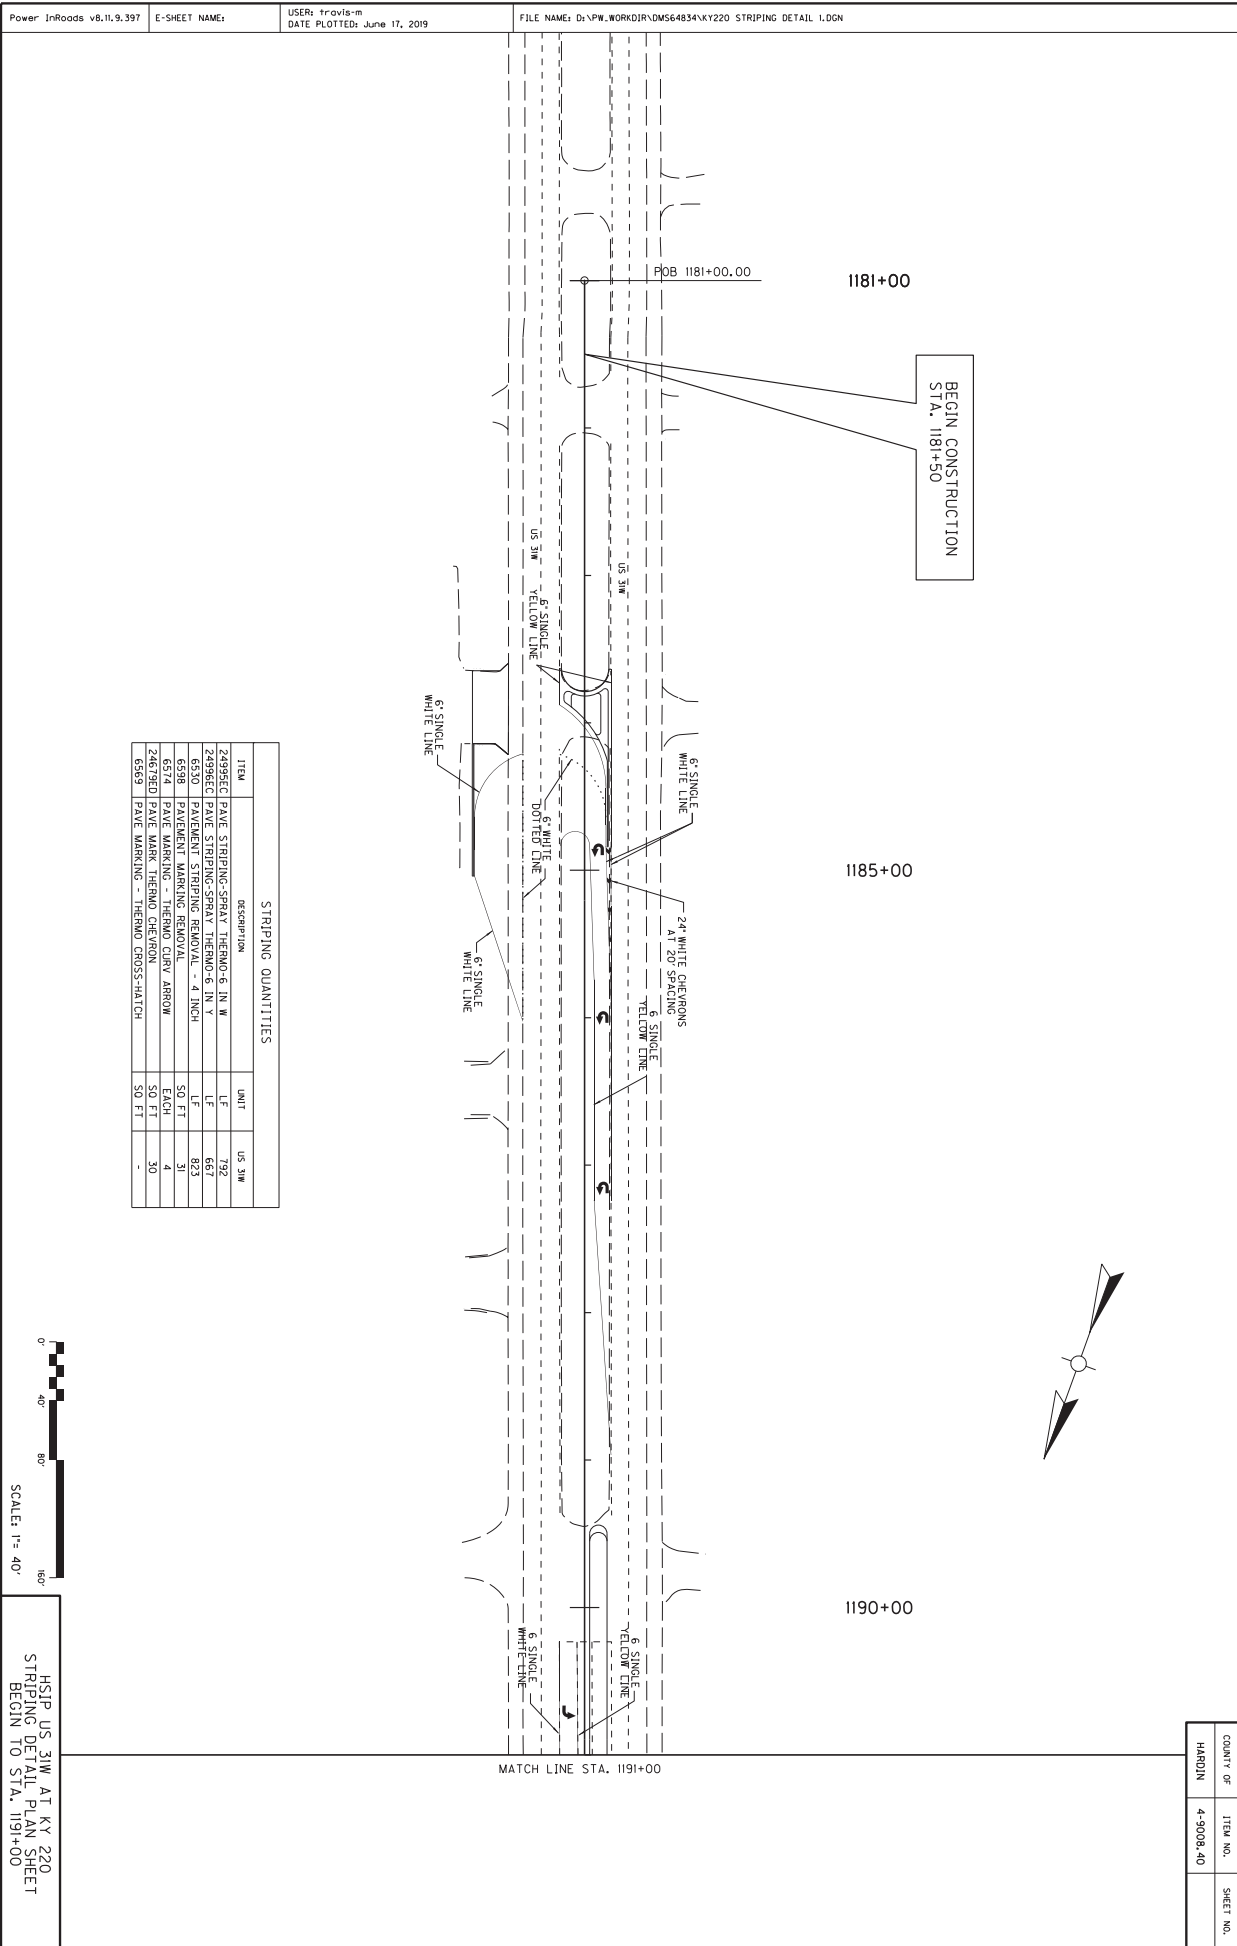

STRIPING QUANTITIES

ITEM	DESCRIPTION	UNIT	US 31W
Z4998EC	PAVE STRIPING-SPRAY THERMO-6 IN W	LF	792
Z4998EC	PAVE STRIPING-SPRAY THERMO-6 IN Y	LF	667
6530	PAVEMENT STRIPING THERMO - 4 INCH	LF	823
6530	PAVEMENT STRIPING THERMO - 4 INCH	50 FT	4
6572	PAVE MARKING THERMO CURB ARROW	EACH	2
Z2679ED	PAVE MARK THERMO CHEVRON	50 FT	30
6569	PAVE MARKING - THERMO CROSS-HATCH	50 FT	-




HSIP US 31W AT KY 220
STRIPING DETAIL PLAN SHEET
BEGIN TO STA. 1191+00

COUNTY OF	ITEM NO.	SHEET NO.
HARDIN	4-9008.40	


Power InRoads v8.11.9.397 E-SHEET NAME: USER: travis-m DATE PLOTTED: June 17, 2019 FILE NAME: D:\PW_WORKDIR\DM564834\KY220 STRIPING DETAIL 1.DGN

Power InRoads v8.11.9.397 E-SHEET NAME: USER: travis-m DATE PLOTTED: August 30, 2018 FILE NAME: D:\PW_WORKDIR\DM564834\KY220 STRIPING DETAIL 2.DGN

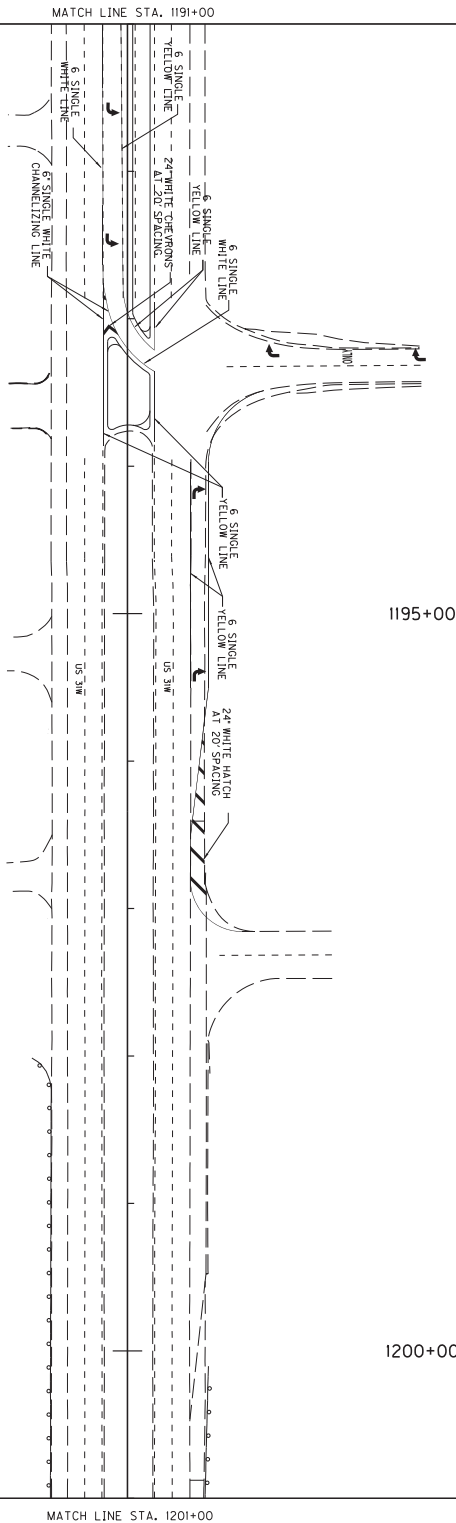

STRIPING QUANTITIES

ITEM	DESCRIPTION	UNIT	US 31W
24895EC	PAVE STRIPING-SPRAY THERMO-6 IN. W	LF	379
24896EC	PAVE STRIPING-SPRAY THERMO-6 IN. Y	LF	330
6550	PAVEMENT STRIPING REMOVE - 4 INCH	LF	664
6551	PAVEMENT STRIPING REMOVE - 6 INCH	LF	202
6574	PAVE MARKING - THERMO CURVE ARROW	EACH	6
6576	PAVE MARKING - THERMO ONLY	EACH	1
24679ED	PAVE MARK THERMO CHEVRON	50 FT	33
6569	PAVE MARKING - THERMO CROSS-MATCH	50 FT	114

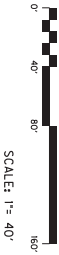

COUNTY OF	ITEM NO.	SHEET NO.
HARDIN	4-9008.40	

HSIP US 31W AT KY 220
STRIPING DETAIL PLAN SHEET
STA. 1191+00 TO STA. 1201+00

Power InRoads v8.11.9.397 E-SHEET NAME: USER: travis-m DATE PLOTTED: August 30, 2018 FILE NAME: D:\PW\WORKDIR\DM564834\KY220 STRIPING DETAIL 3.DGN



MATCH LINE STA. 1201+00

1205+00

STRIPING QUANTITIES


ITEM	DESCRIPTION	UNIT	US 31W
Z4995EC	PAVE STRIPING-SPRAY THERMO 6 IN W	LF	240
Z4995EC	PAVE STRIPING-SPRAY THERMO 6 IN W	LF	435
6530	PAVEMENT STRIPING REMOVAL - 4 INCH	LF	415
6530	PAVEMENT STRIPING REMOVAL - 4 INCH	SQ FT	3
6574	PAVE MARKING - THERMO CURV ARROW	EACH	-
6576	PAVE MARKING - THERMO CONV Y	EACH	-
Z4679E01	PAVE MARK THERMO CHEVRON	SQ FT	-
6569	PAVE MARKING - THERMO CROSS-HATCH	SQ FT	-

END CONSTRUCTION
STA. 1207+25

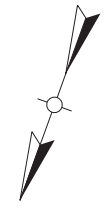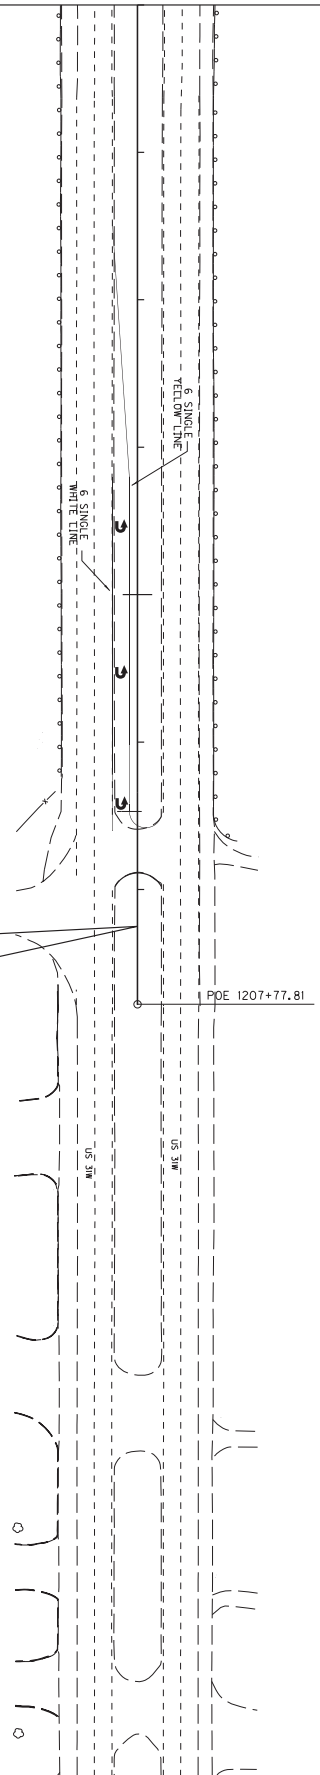

COUNTY OF	ITEM NO.	SHEET NO.
HARDIN	4-9008.40	

HSIP US 31W AT KY 220
STRIPING DETAIL PLAN SHEET
STA. 1201+00 TO END

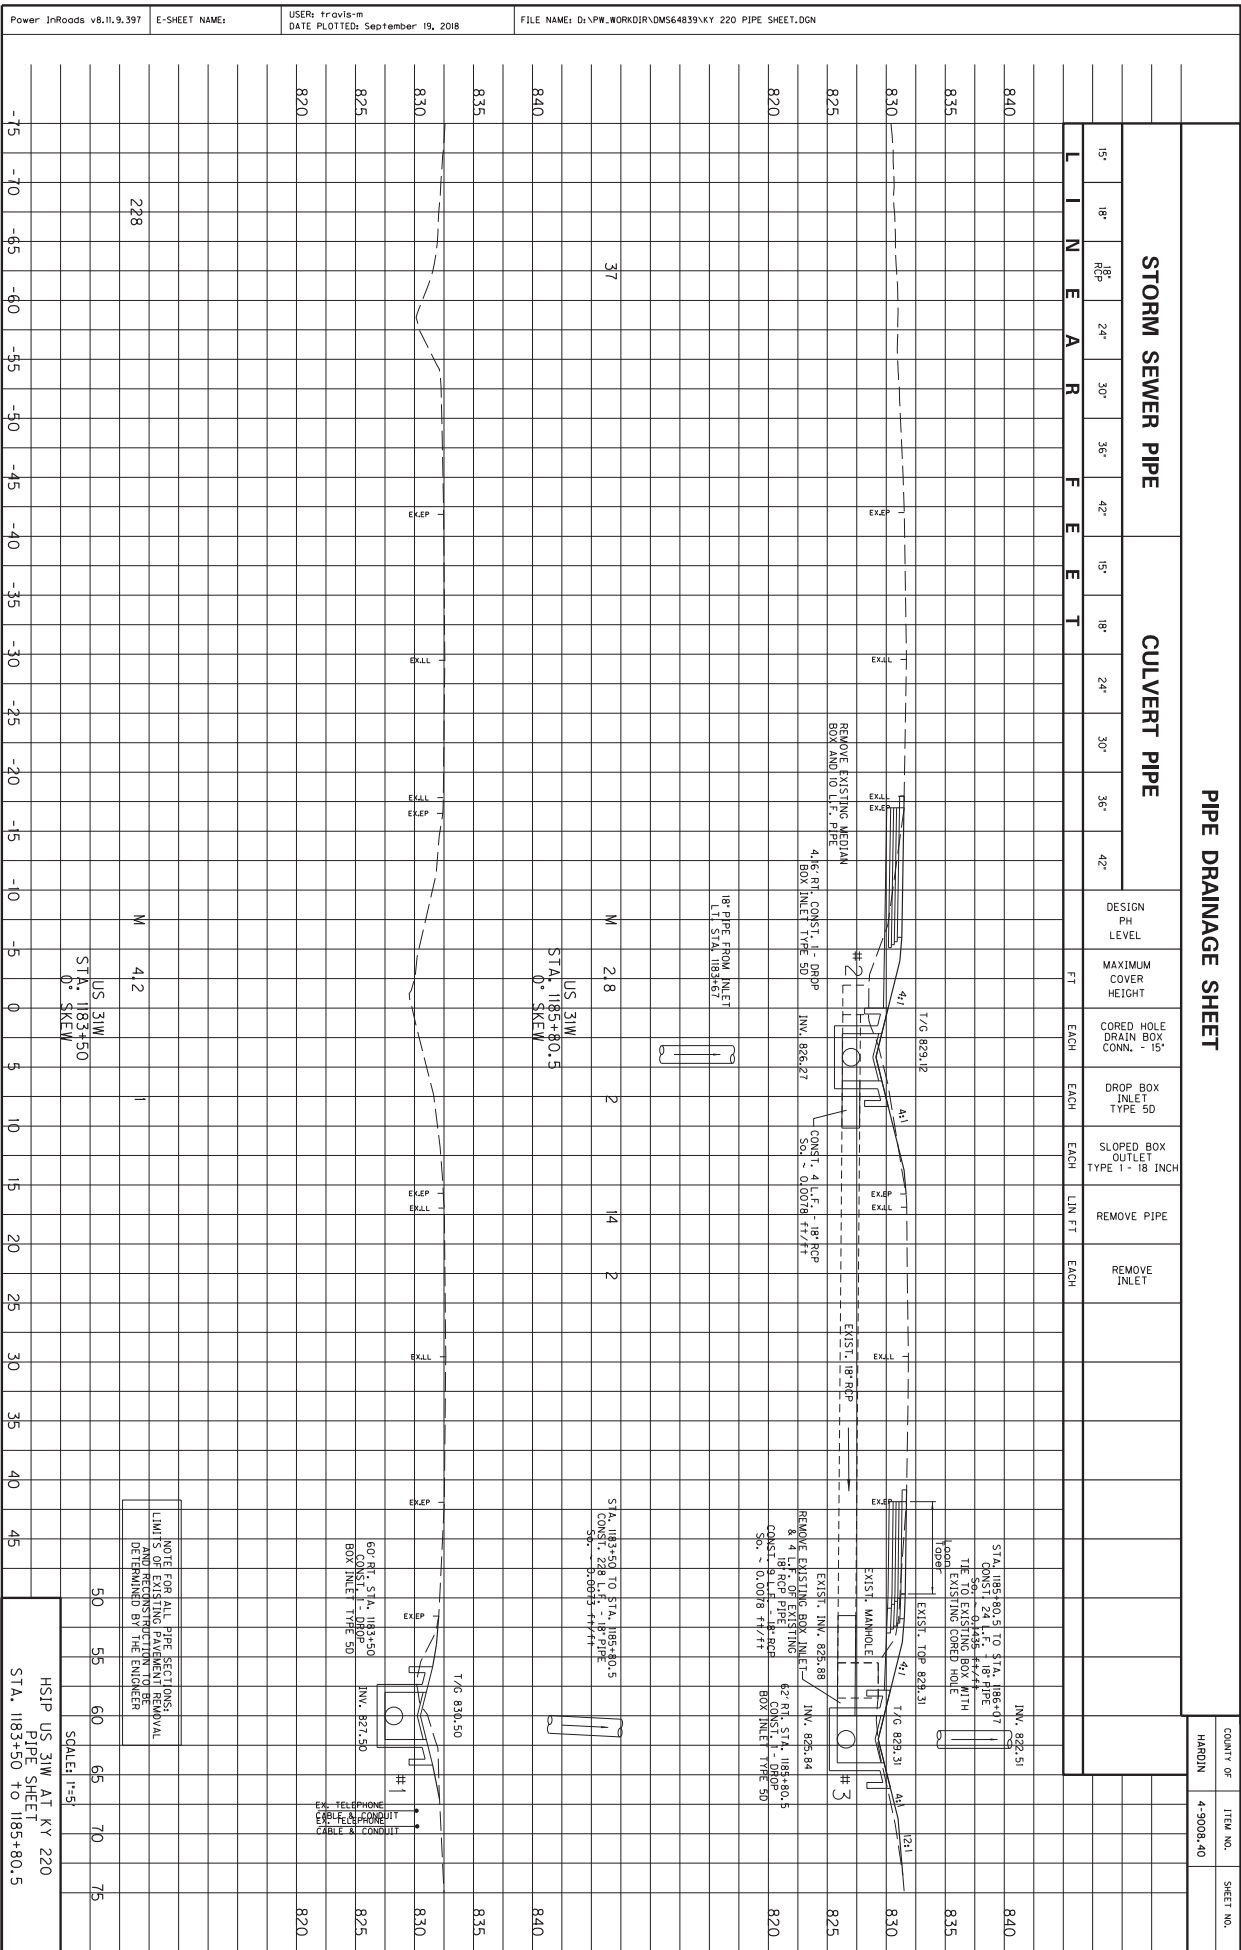

PIPE DRAINAGE SHEET

STORM SEWER PIPE

CULVERT PIPE

LINE	PIPE	FEET	DESIGN PH LEVEL	MAXIMUM COVER HEIGHT	CORED HOLE DRAIN BOX CONN. - 15"	DROP BOX INLET TYPE 5D	SLOPED BOX OUTLET TYPE 1 - 18 INCH	REMOVE PIPE	REMOVE INLET
15"	18"	15'							
18"	18"	24'							
30"	18"	30'							
36"	18"	42'							
42"	18"	15'							
18"	18"	24'							
30"	18"	30'							
36"	18"	42'							


COUNT OF	ITEM NO.	SHEET NO.
HARDIN	4-9008-40	


NOTE FOR ALL PIPE SECTIONS, LIMITS OF EXISTING PAVEMENT REMOVAL ARE SHOWN BY THE ENGINEER.

SCALE: 1"=5'

HSIP US 31W AT KY 220
PIPE SHEET
STA. 1183+50 TO 1185+80.5

Power InRoads v8.11.9.397 E-SHEET NAME: USER: travis-m DATE PLOTTED: September 19, 2018 FILE NAME: D:\PW\WORKDIR\DM564839\KY 220 PIPE SHEET.DGN

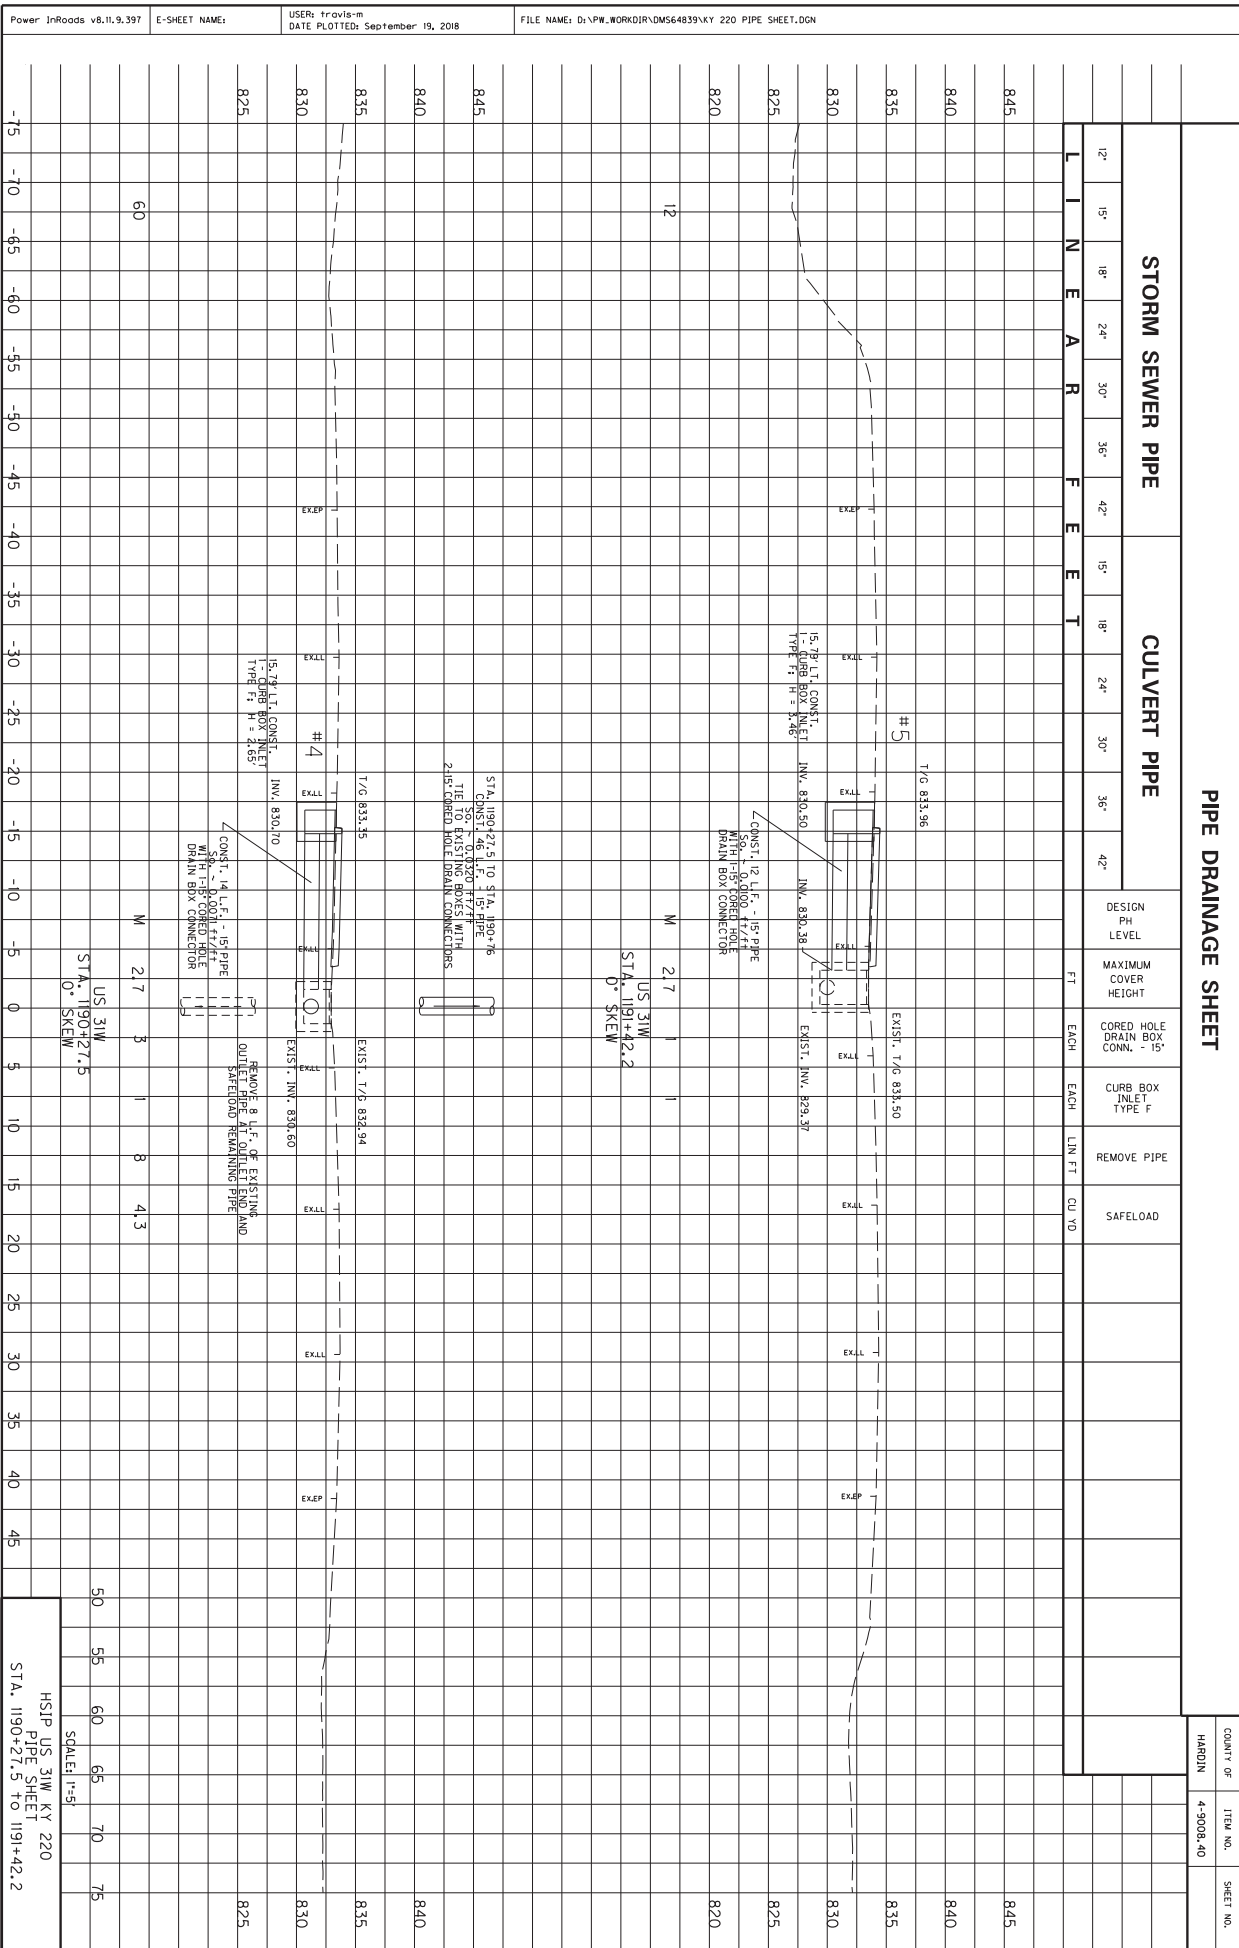


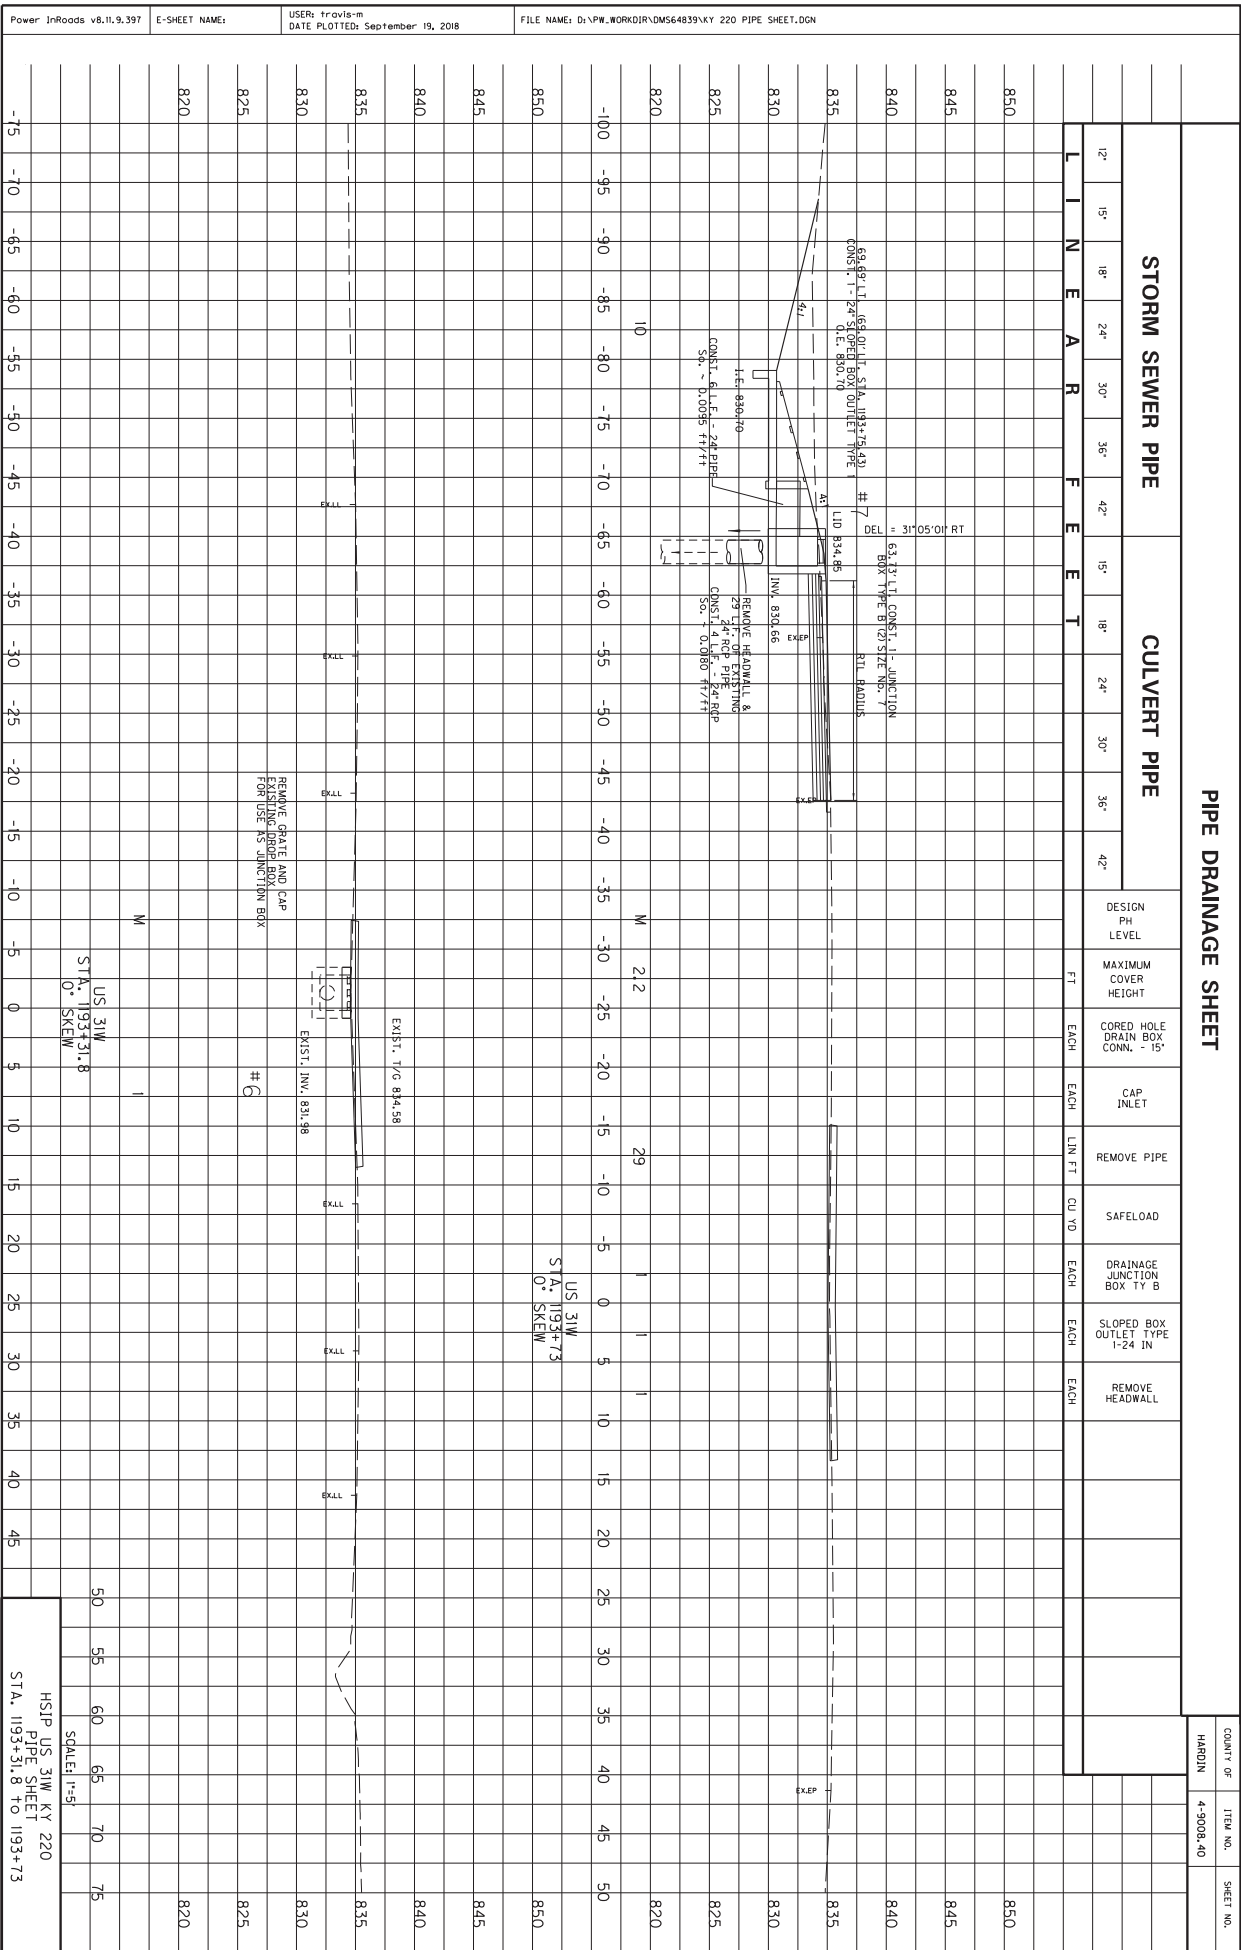


Power InRoads v8.11.9.397 E-SHEET NAME:

USER: travis-m
DATE PLOTTED: September 19, 2018


FILE NAME: D:\PW\WORKDIR\DM564839\KY 220 PIPE SHEET.DGN

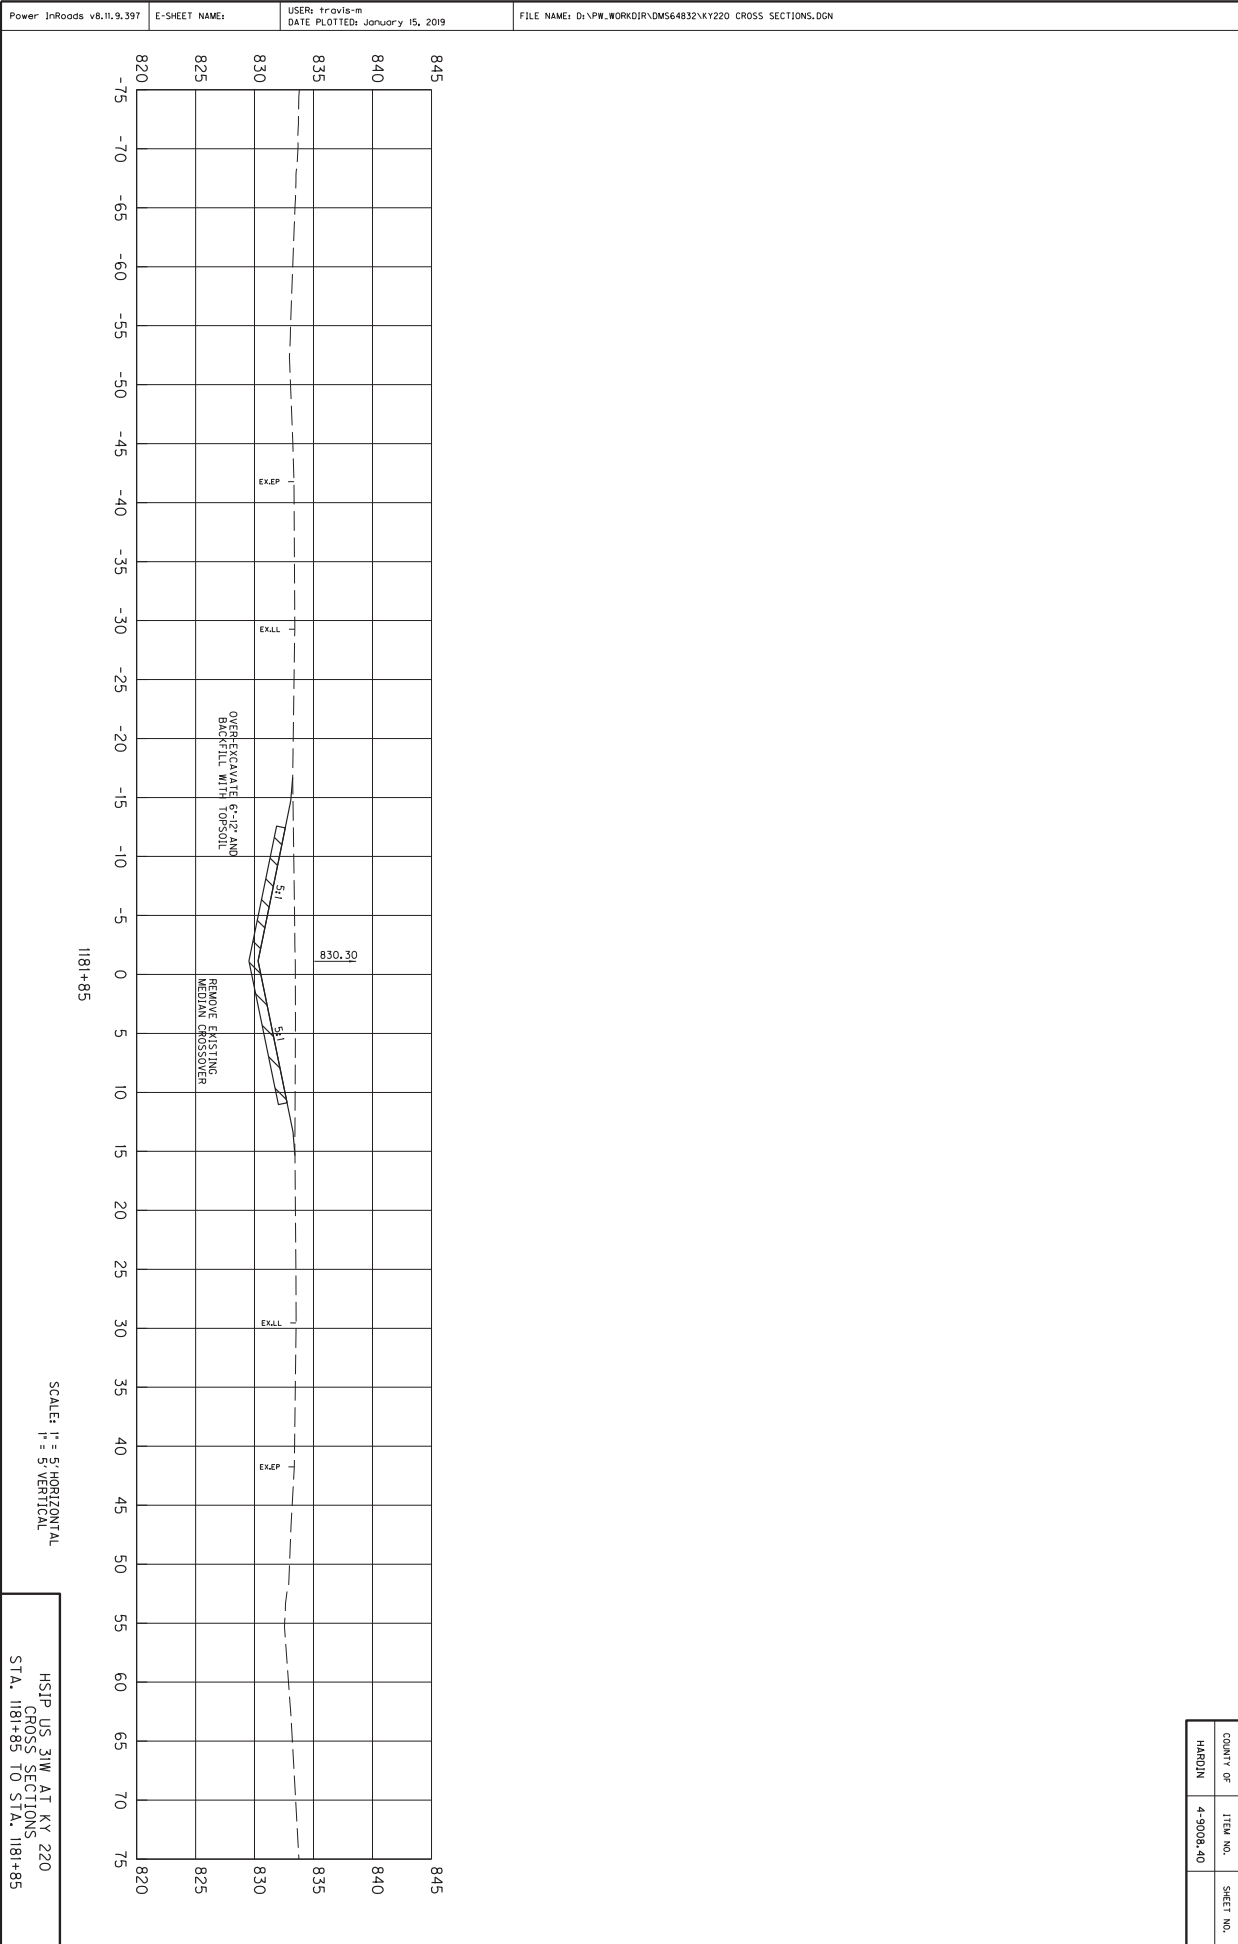



HSIP US 31W AT KY 220
 CROSS SECTIONS
 STA. 1181+85 TO STA. 1181+85

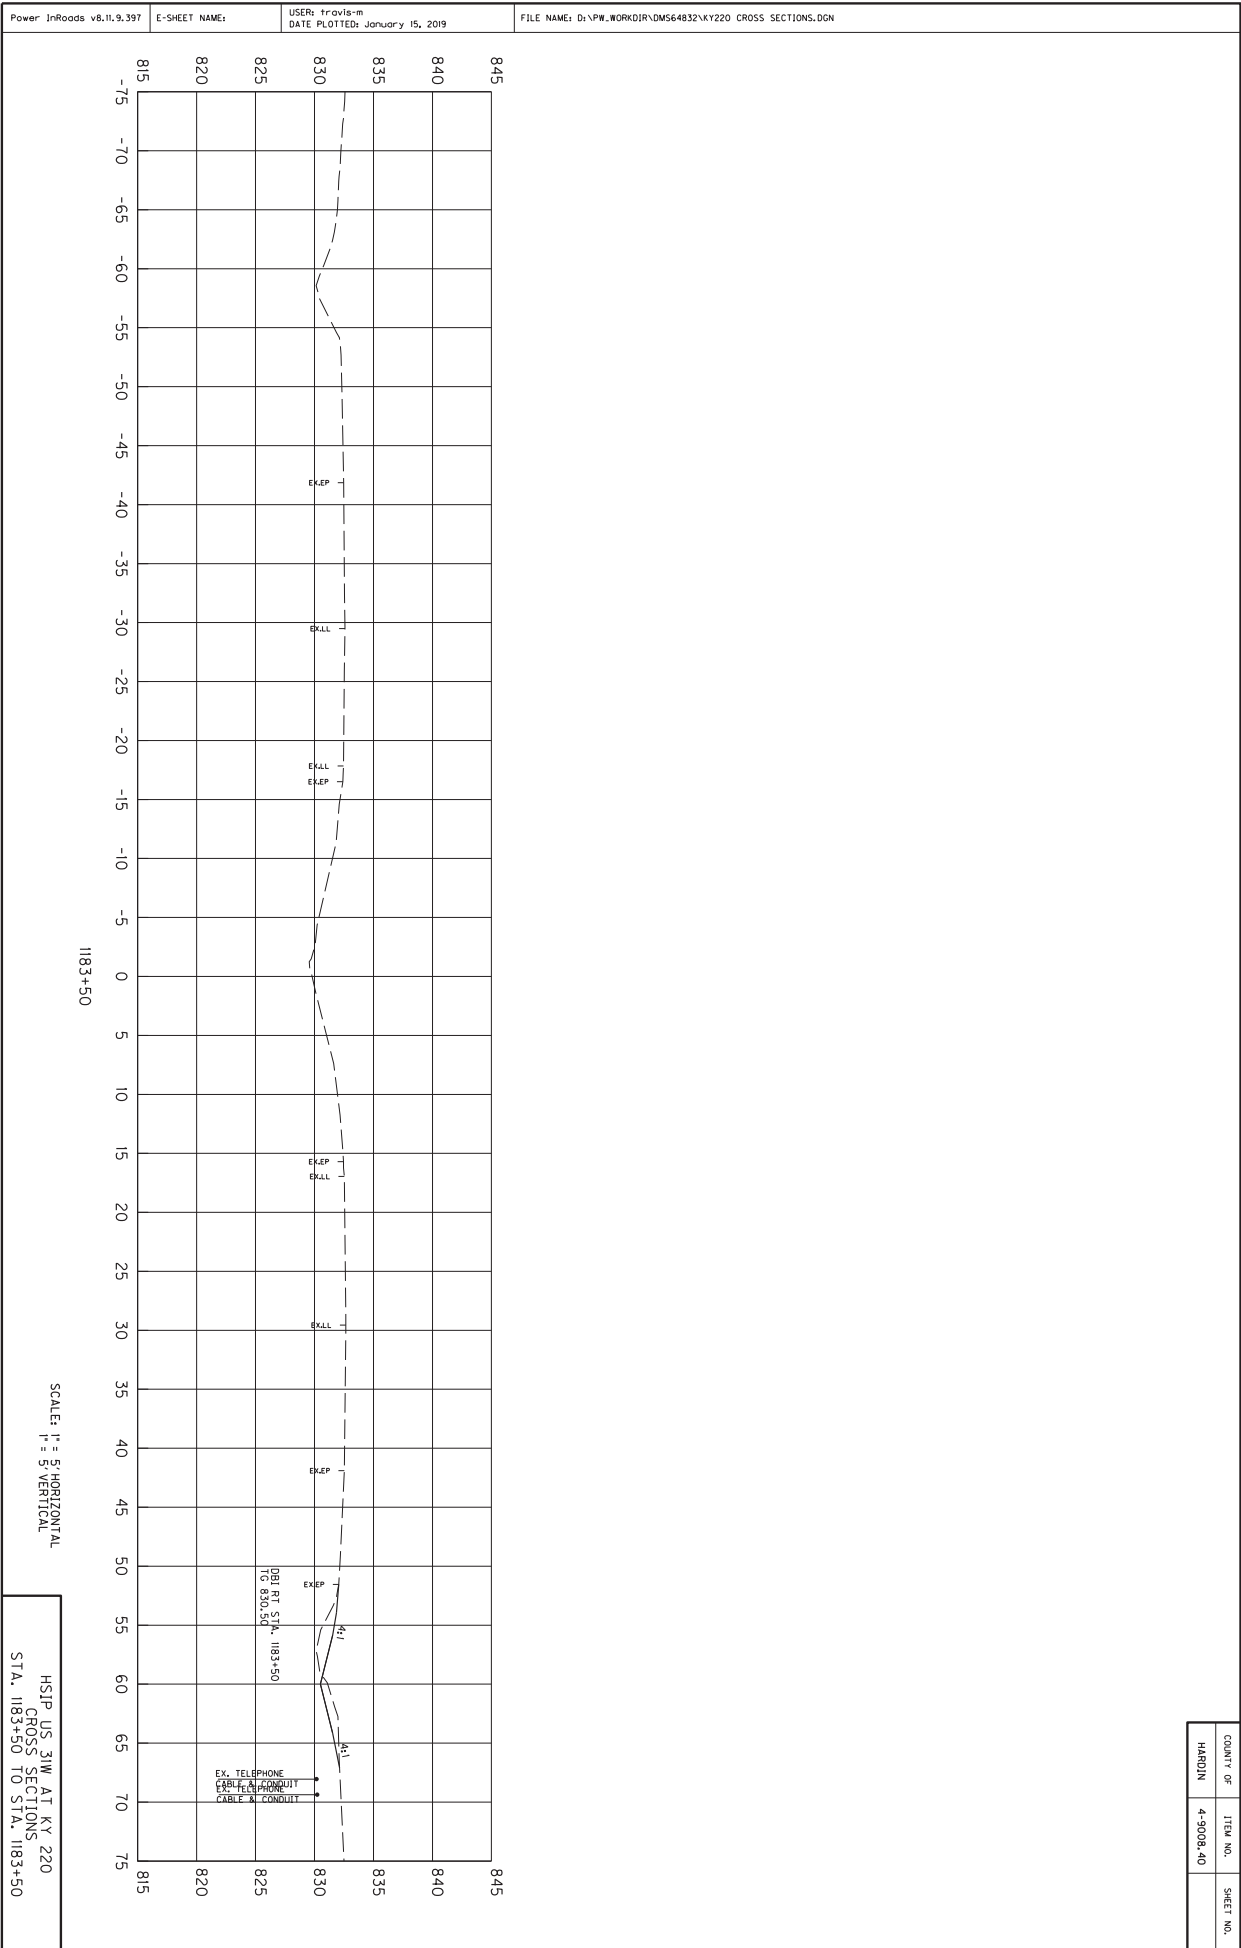

COUNTY OF	ITEM NO.	SHEET NO.
HARDIN	4-9008.40	

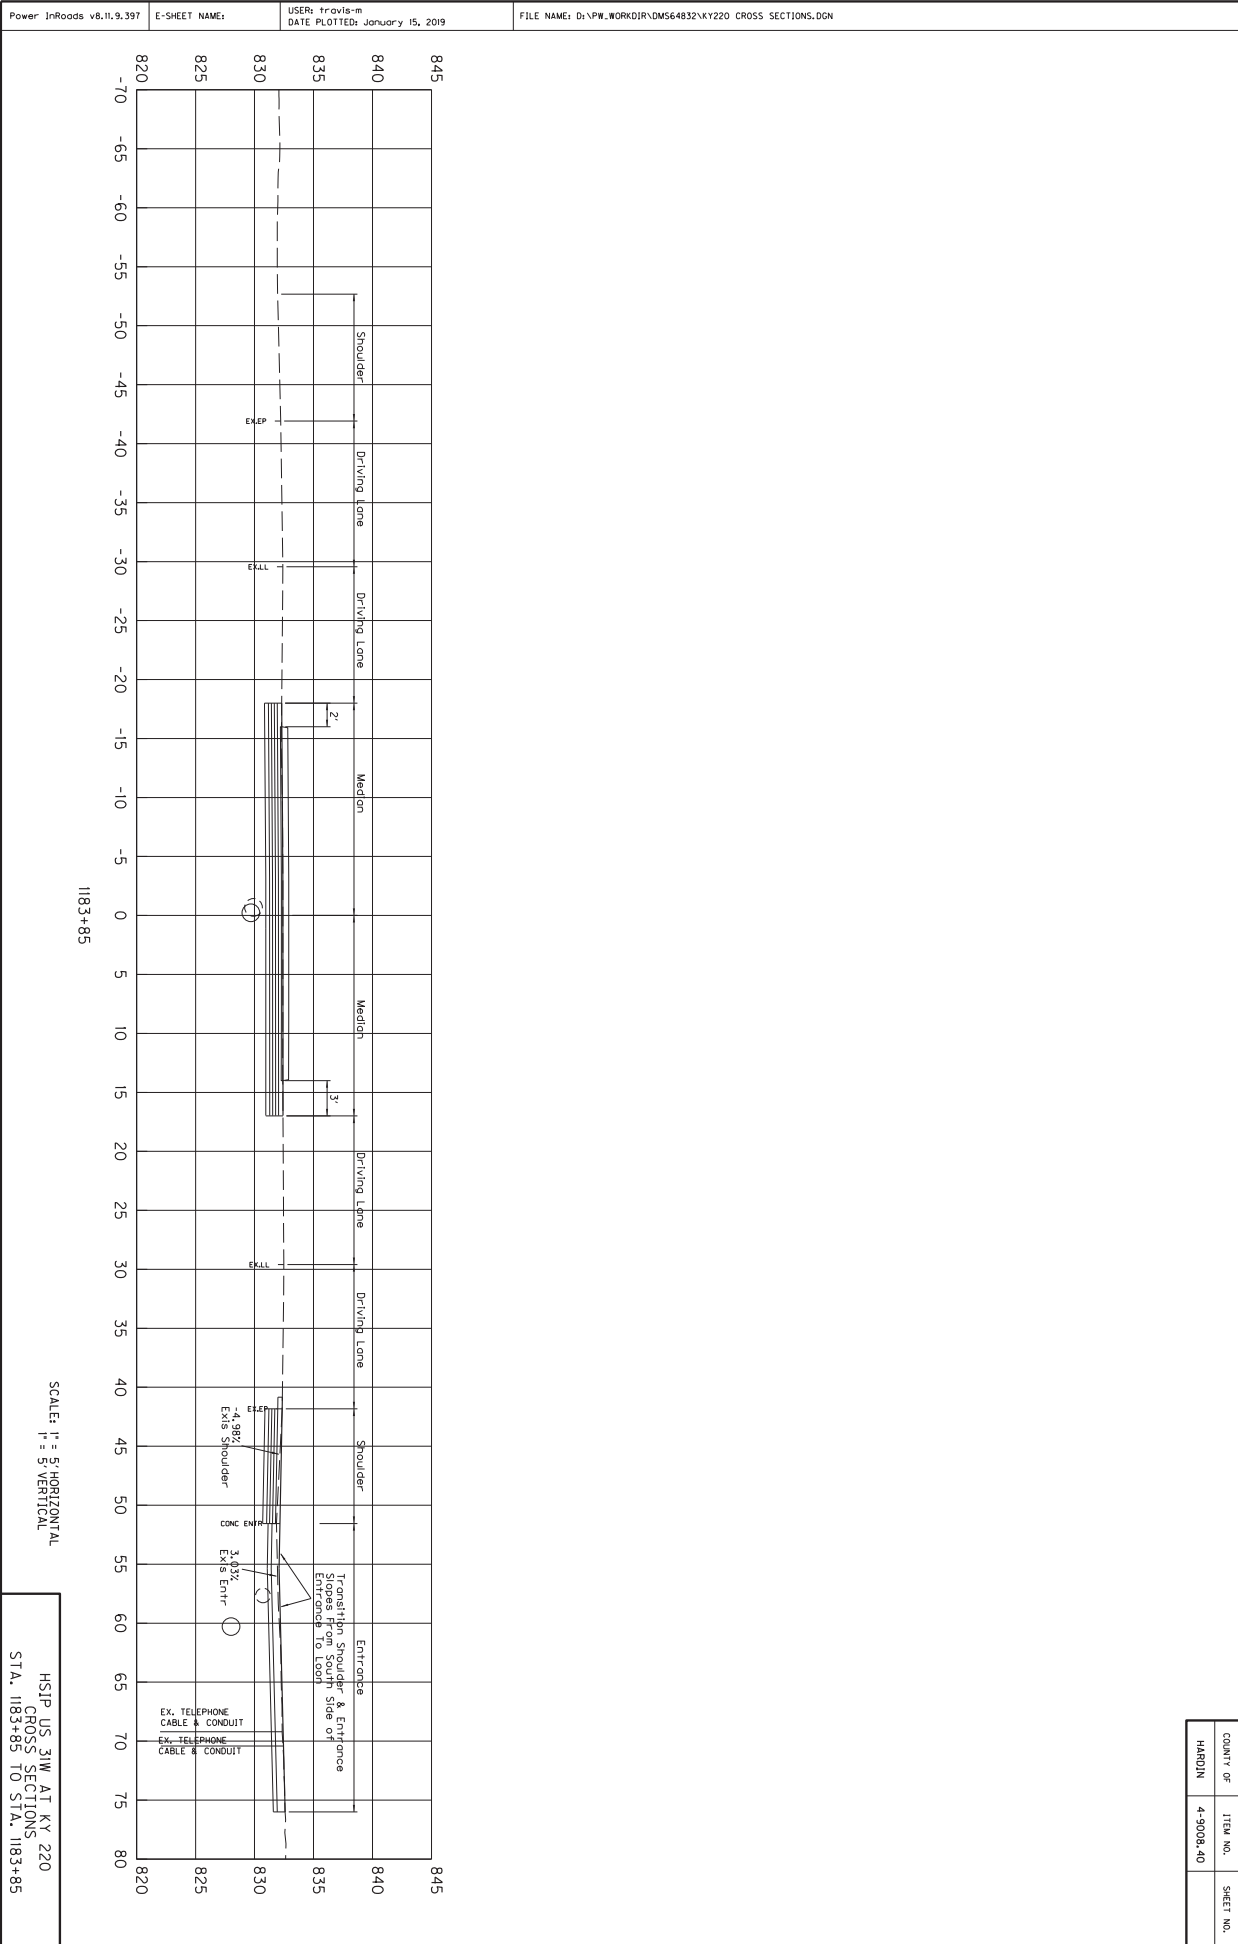

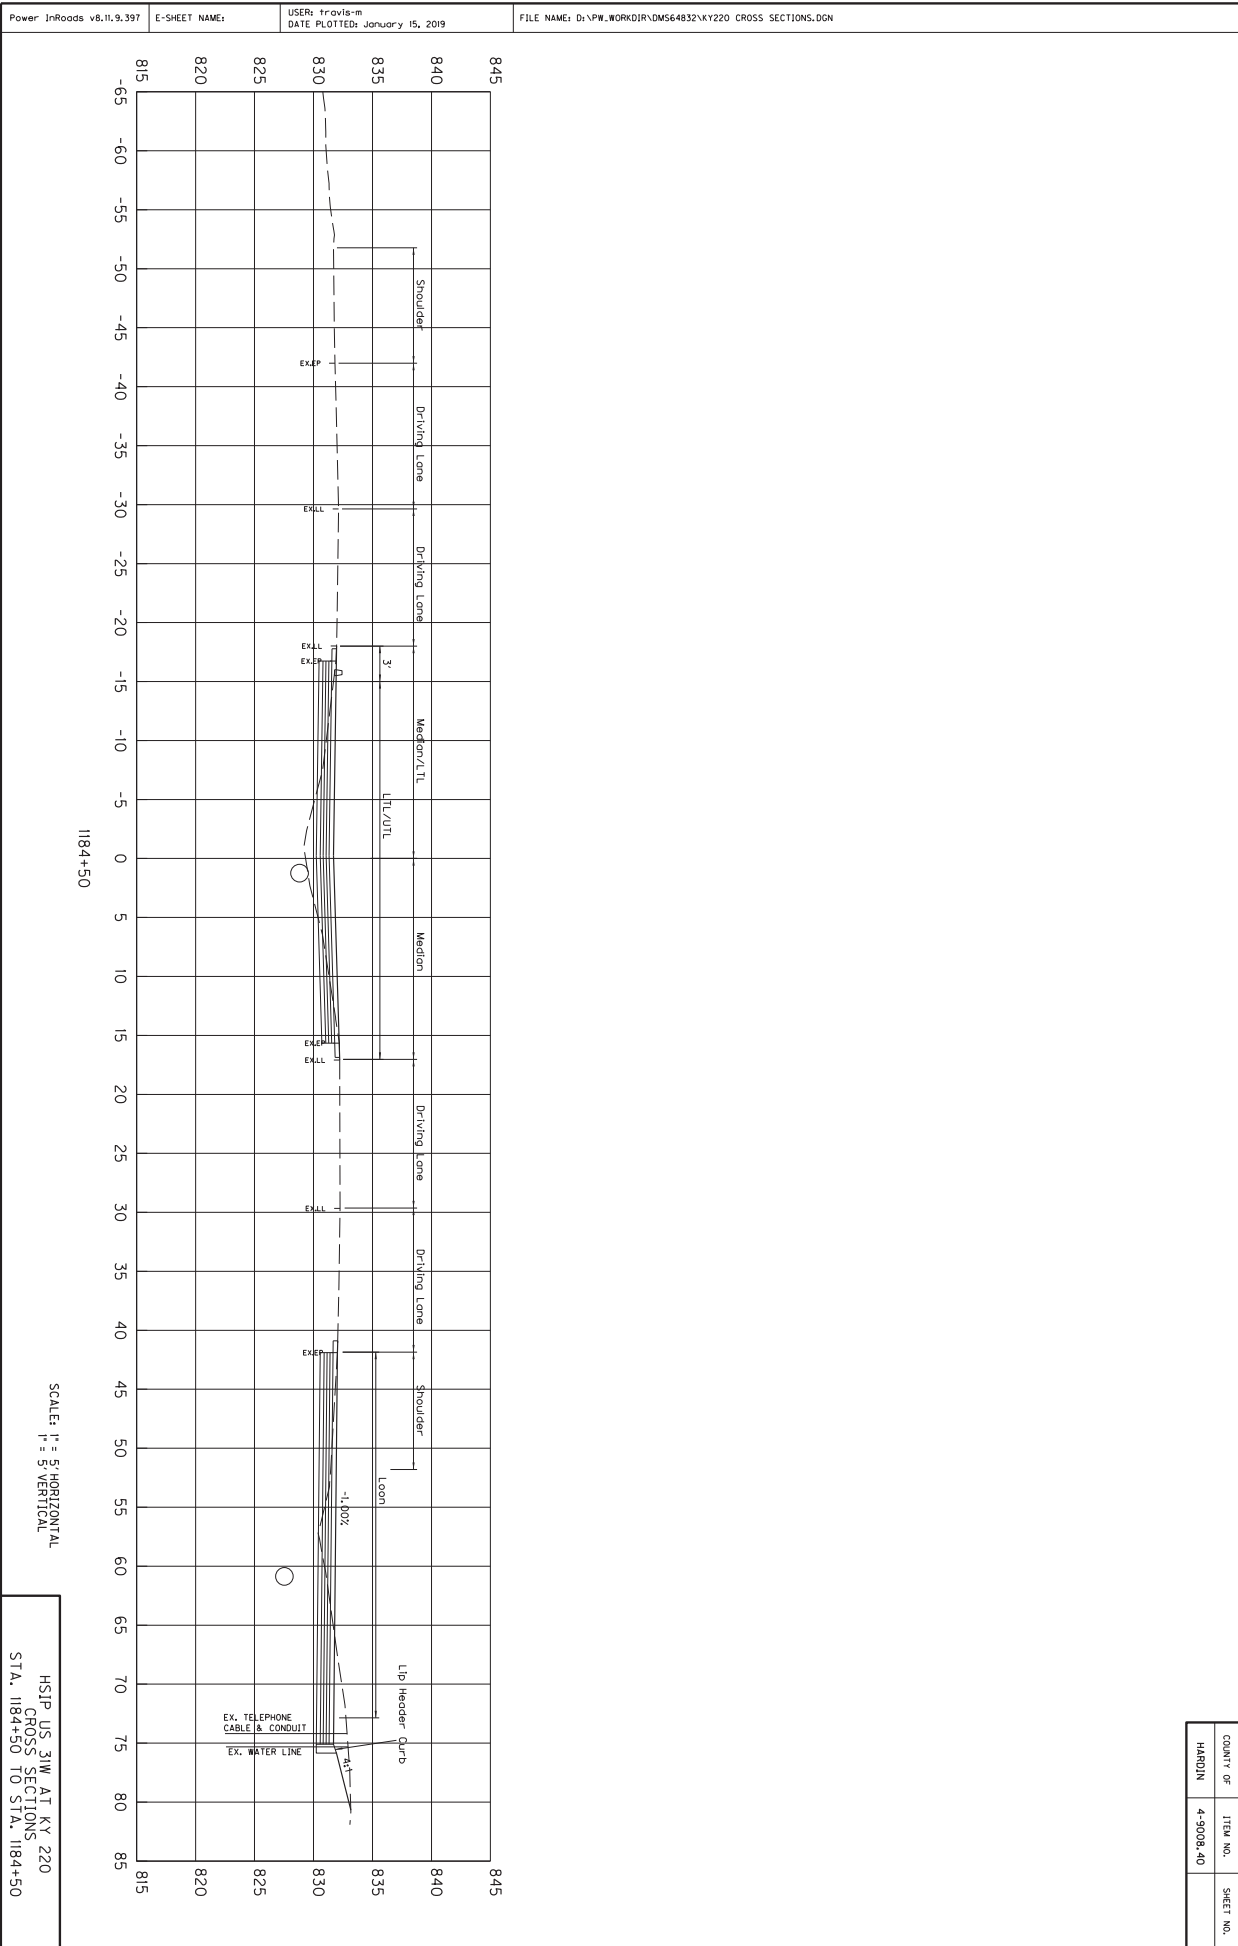

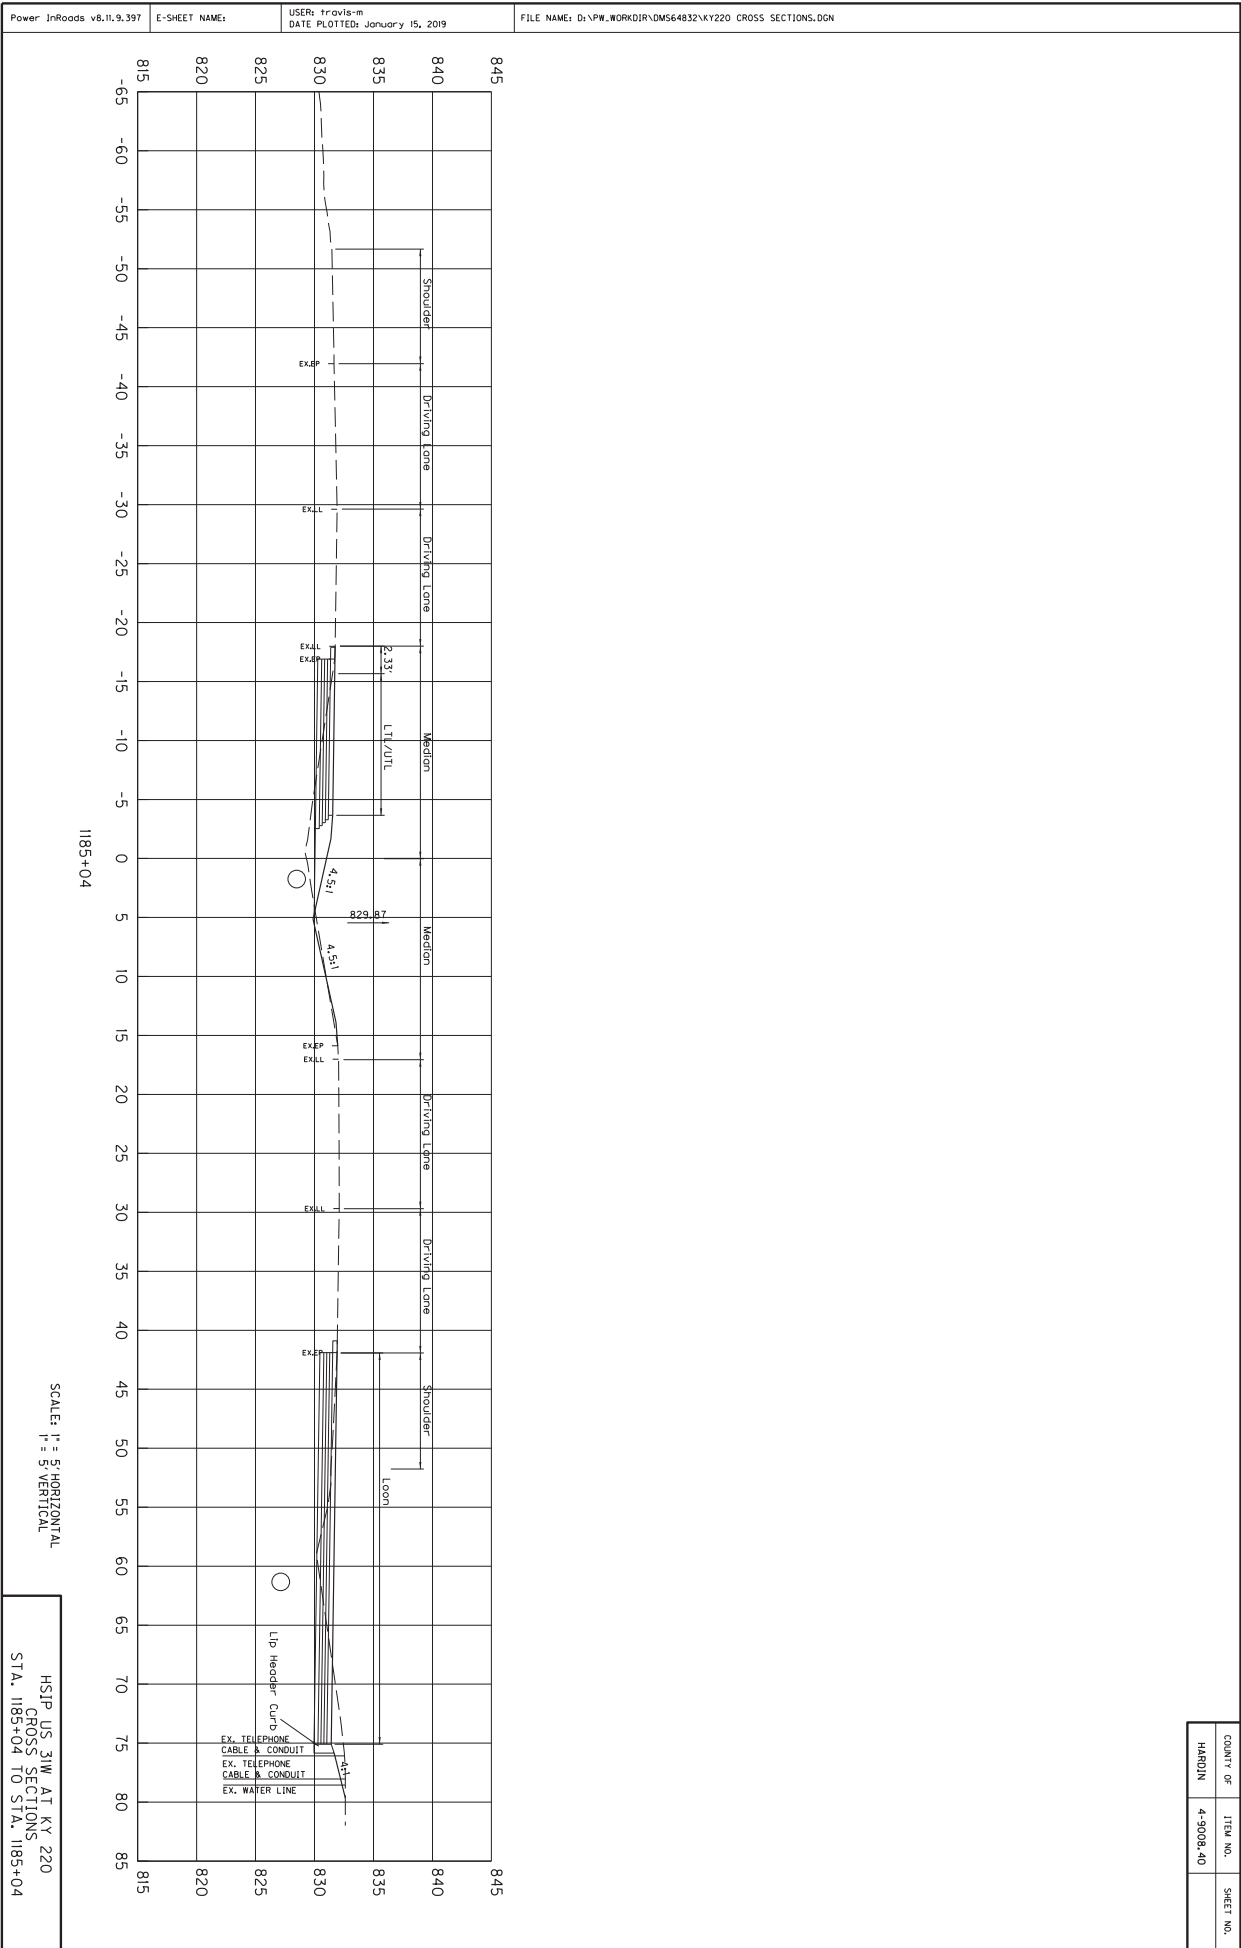



1185+04


SCALE: H = 5' HORIZONTAL
V = 5' VERTICAL

HSIP US 31W AT KY 220 CROSS SECTIONS STA. 1185+04 TO STA. 1185+04

COUNTY OF	ITEM NO.	SHEET NO.
HARDIN	4-9008.40	

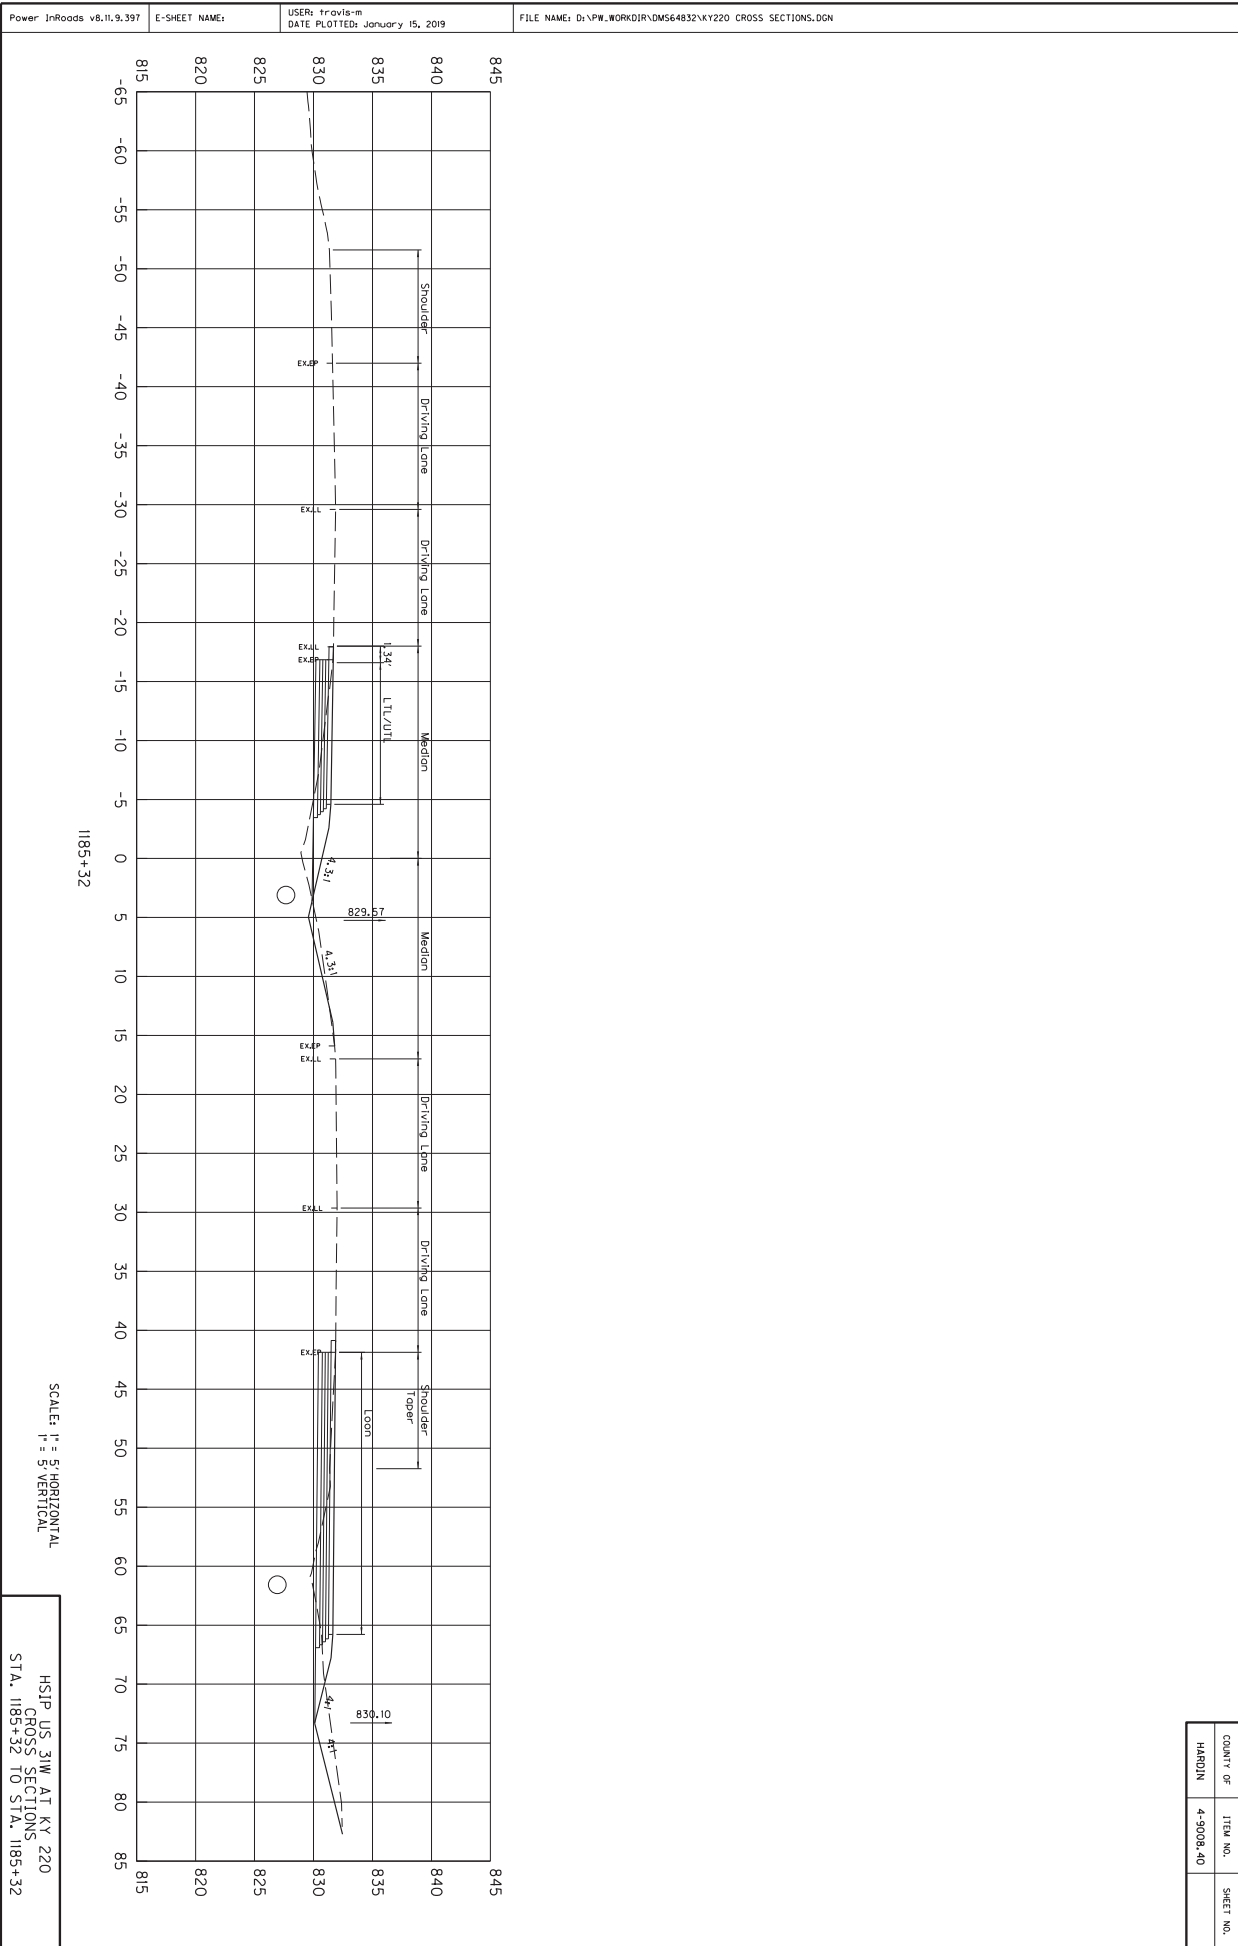

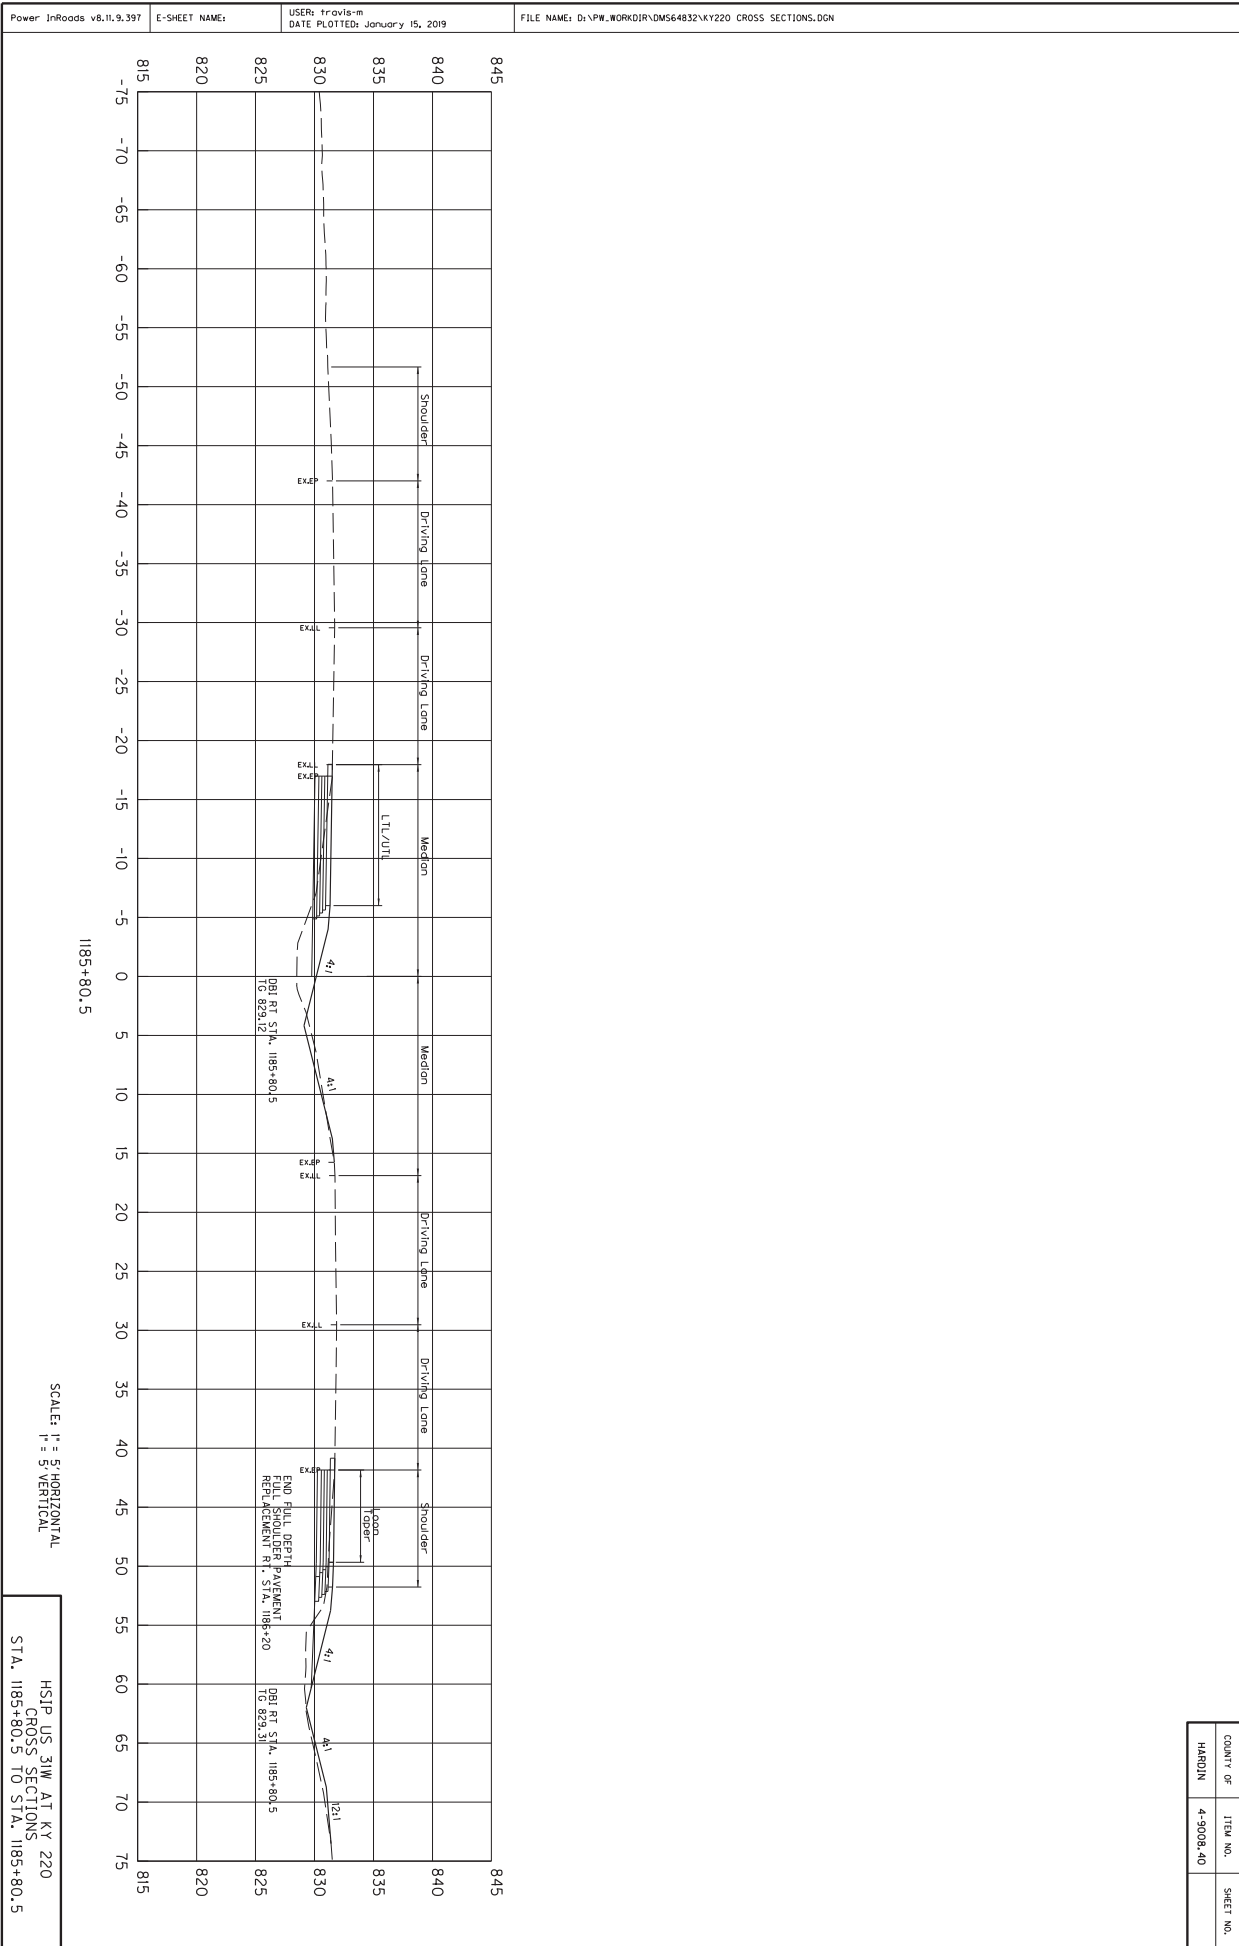


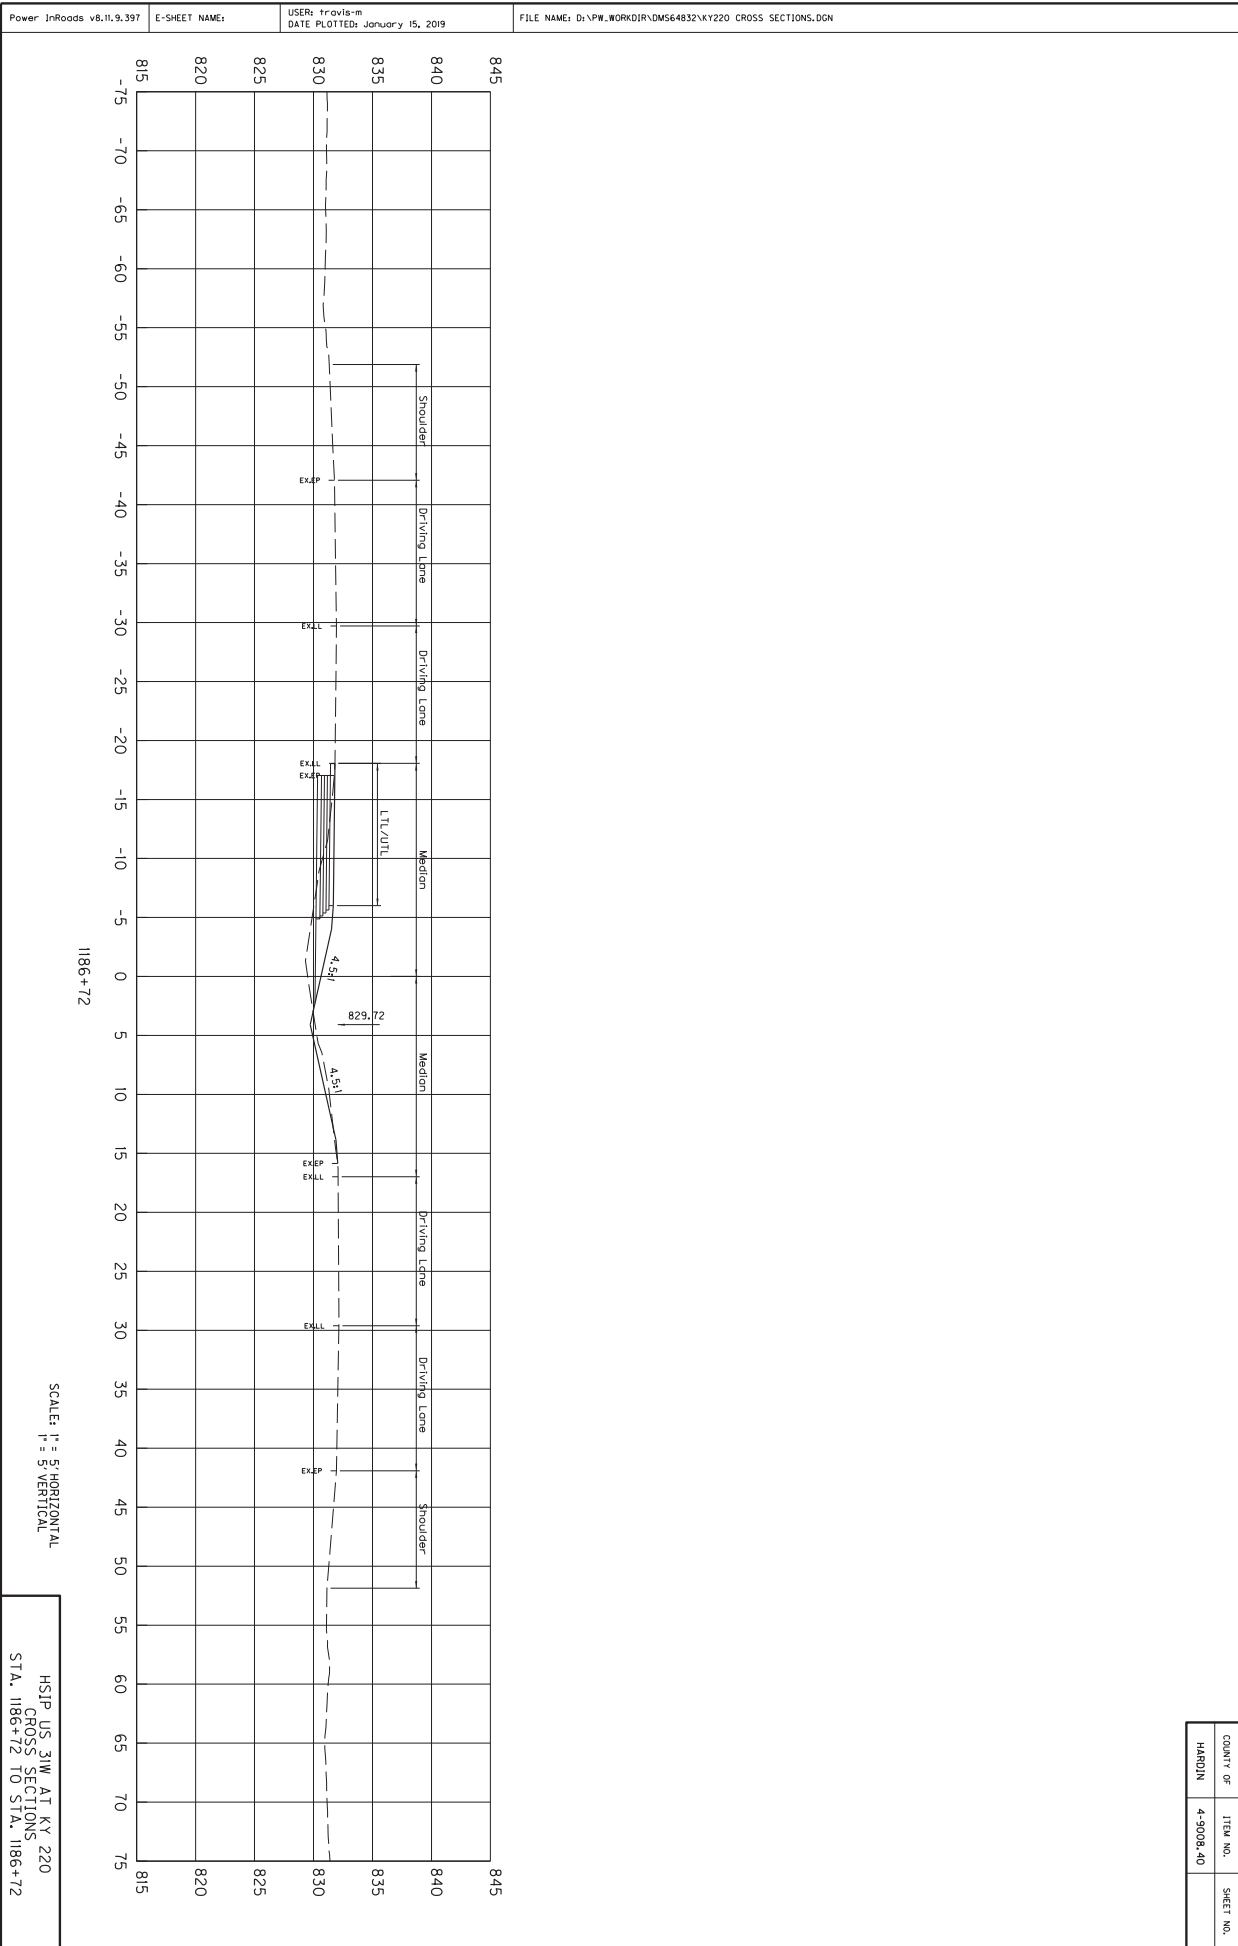



SCALE: H = 5' HORIZONTAL
V = 5' VERTICAL


HSIP US 31W AT KY 220
CROSS SECTIONS
STA. 1186+72 TO STA. 1186+72


COUNTY OF	ITEM NO.	SHEET NO.
HARDIN	4-9008.40	

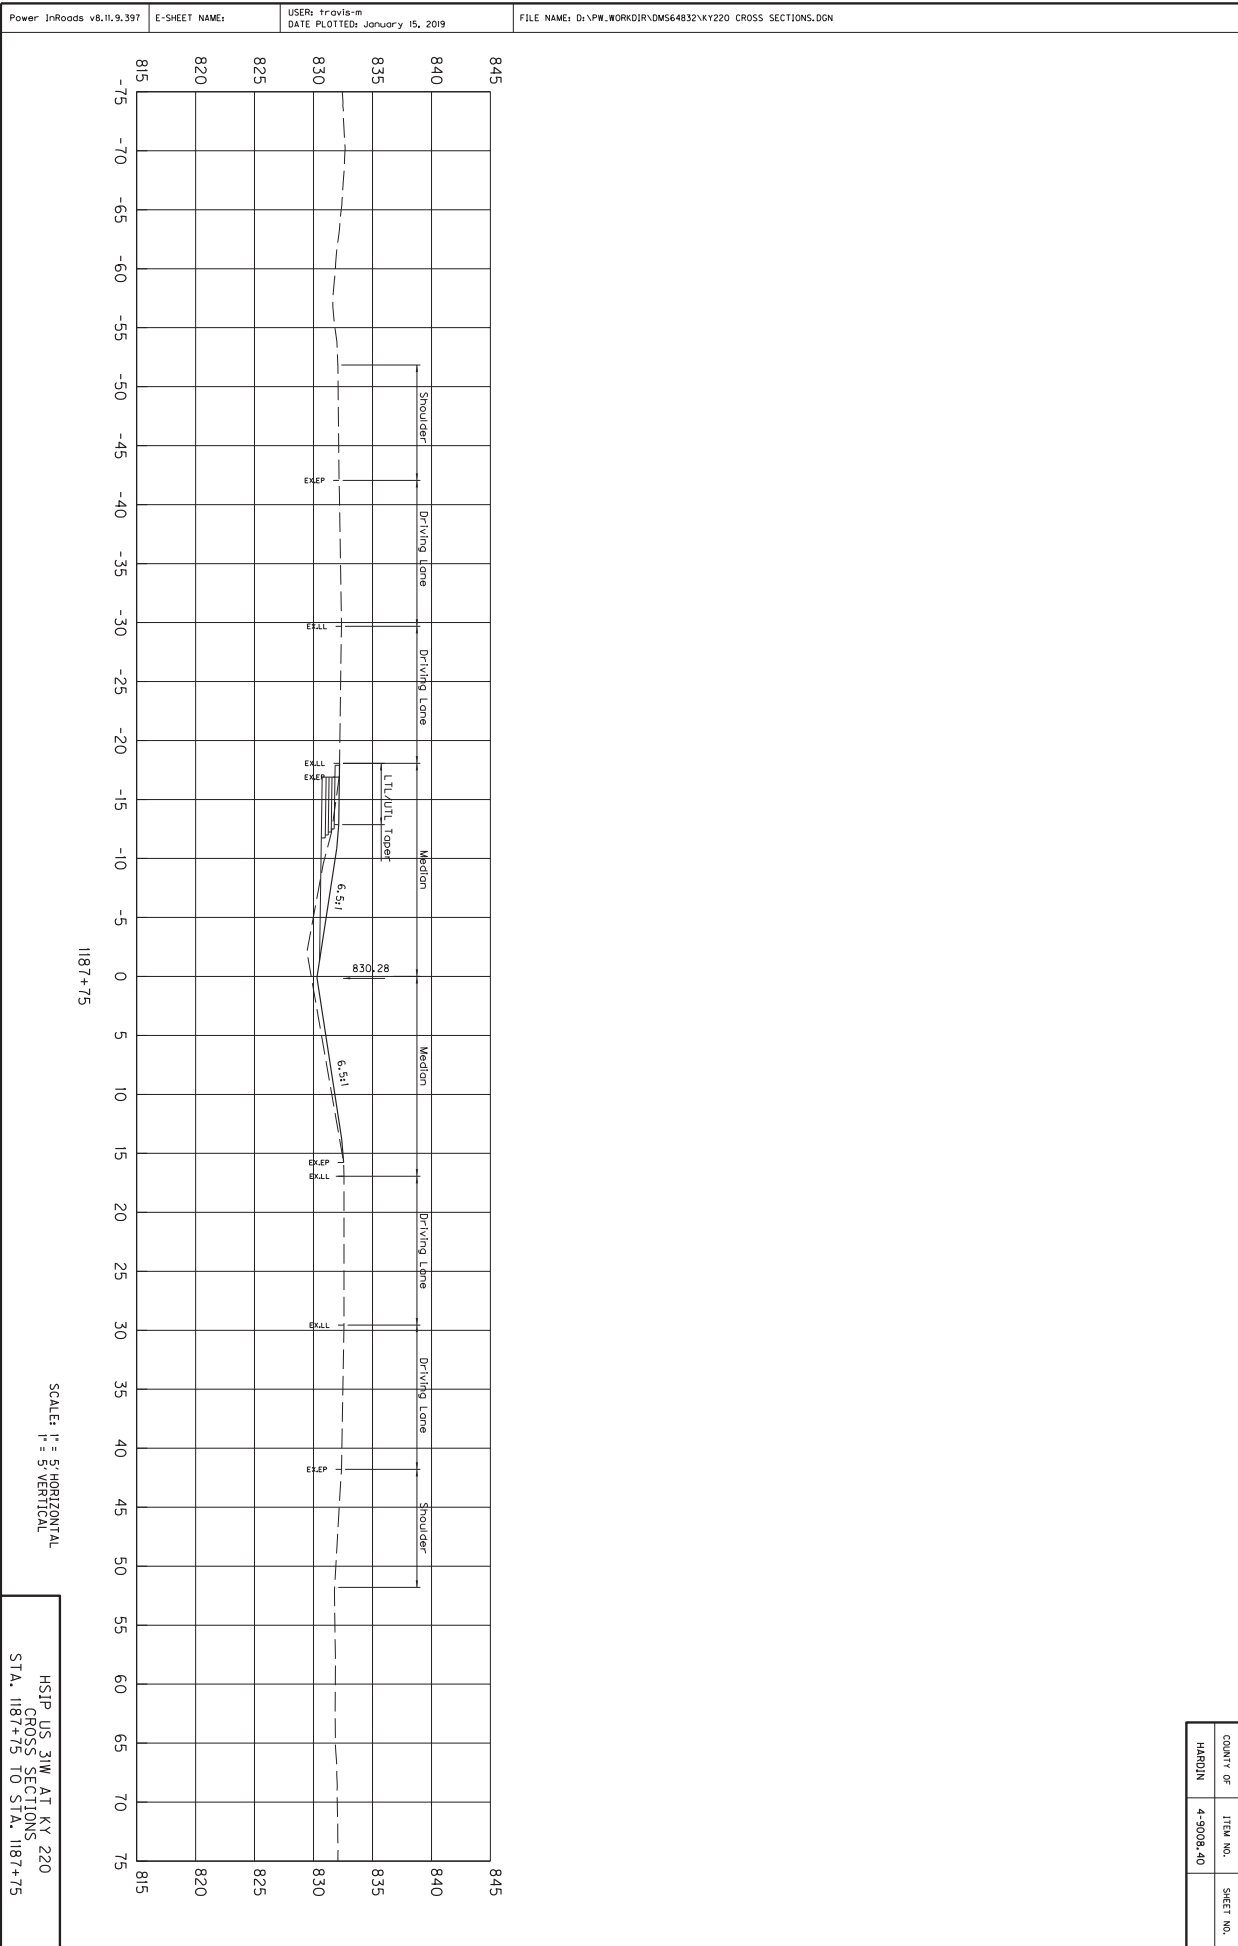


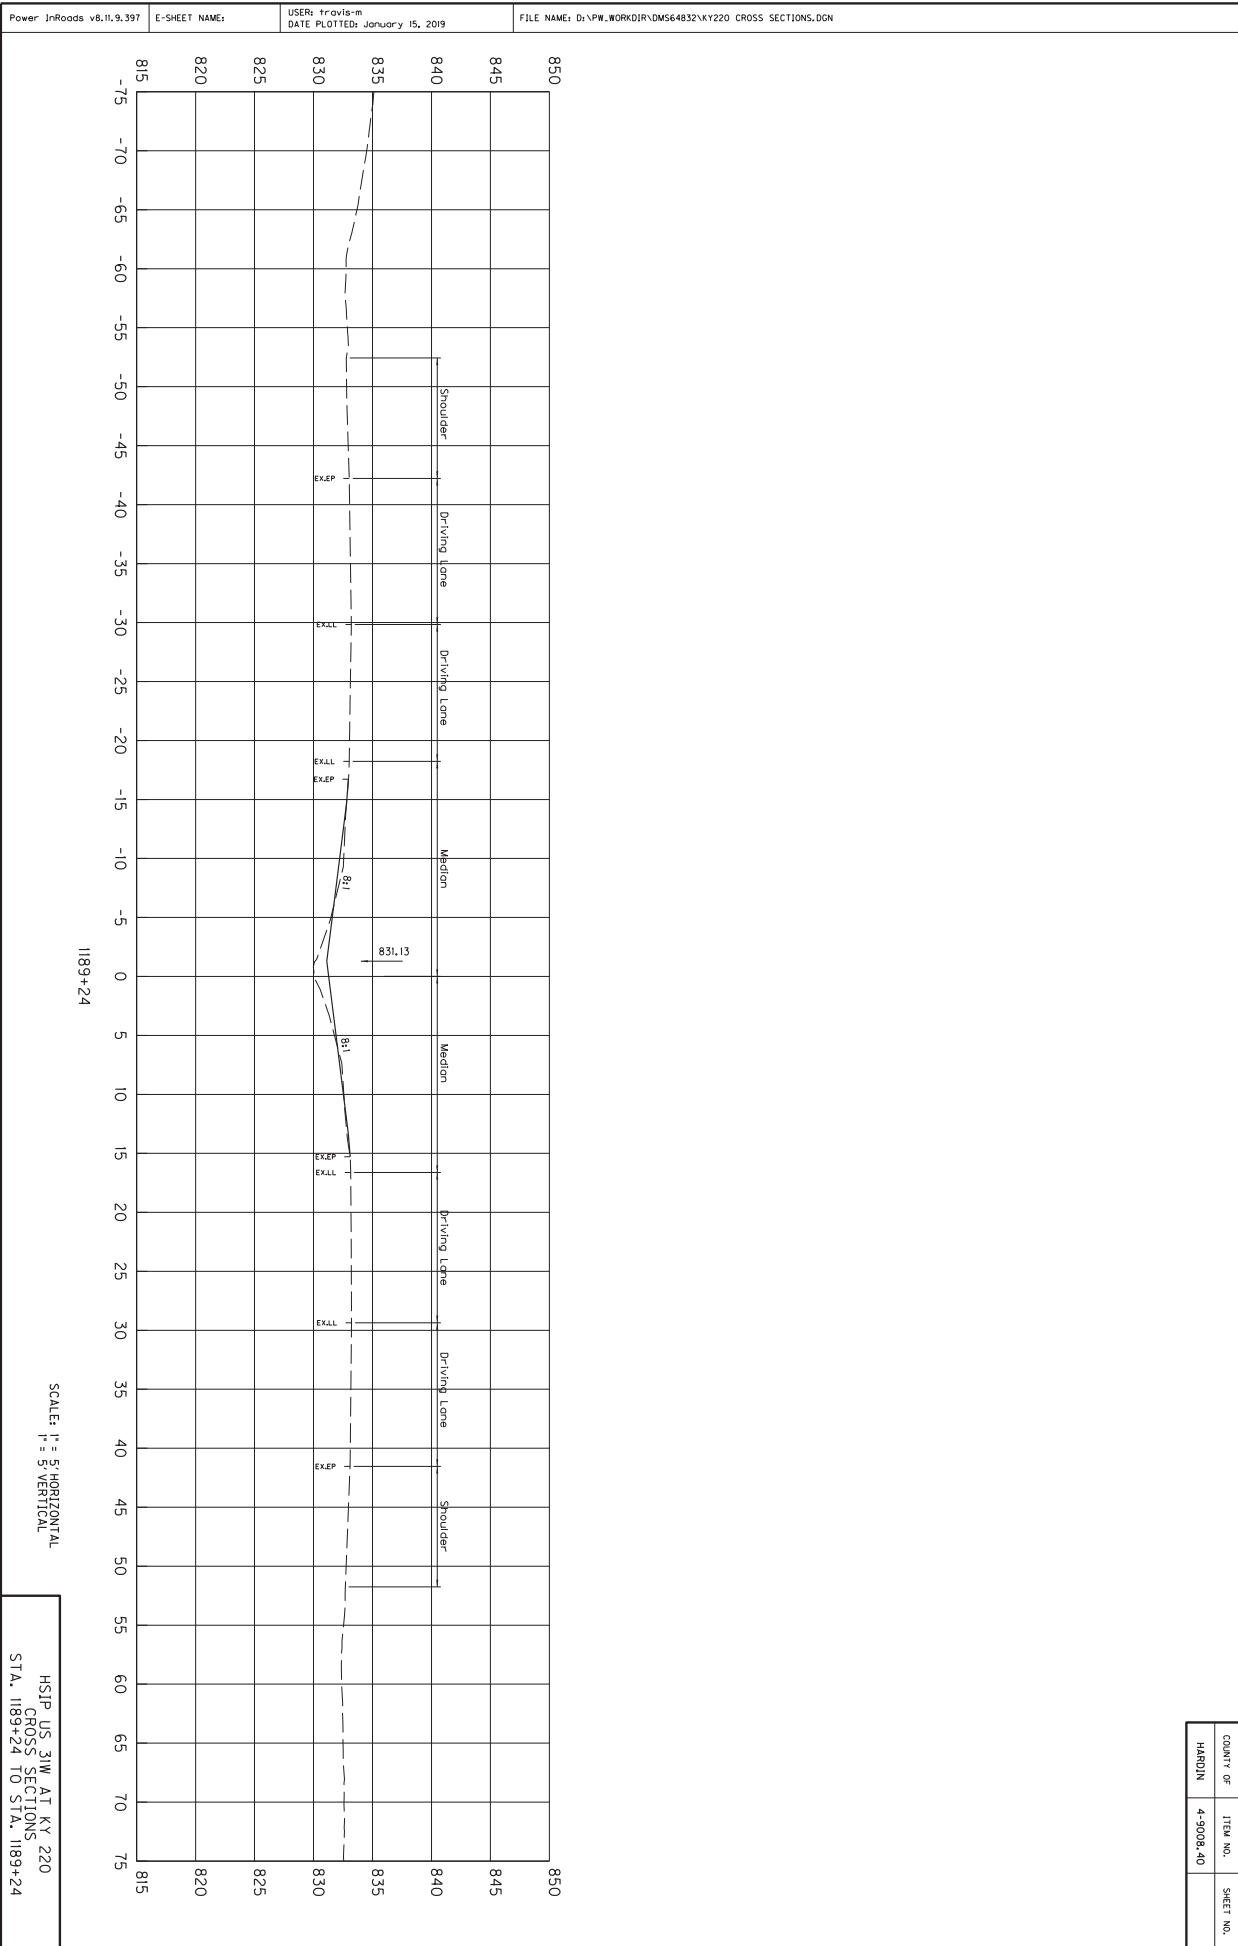


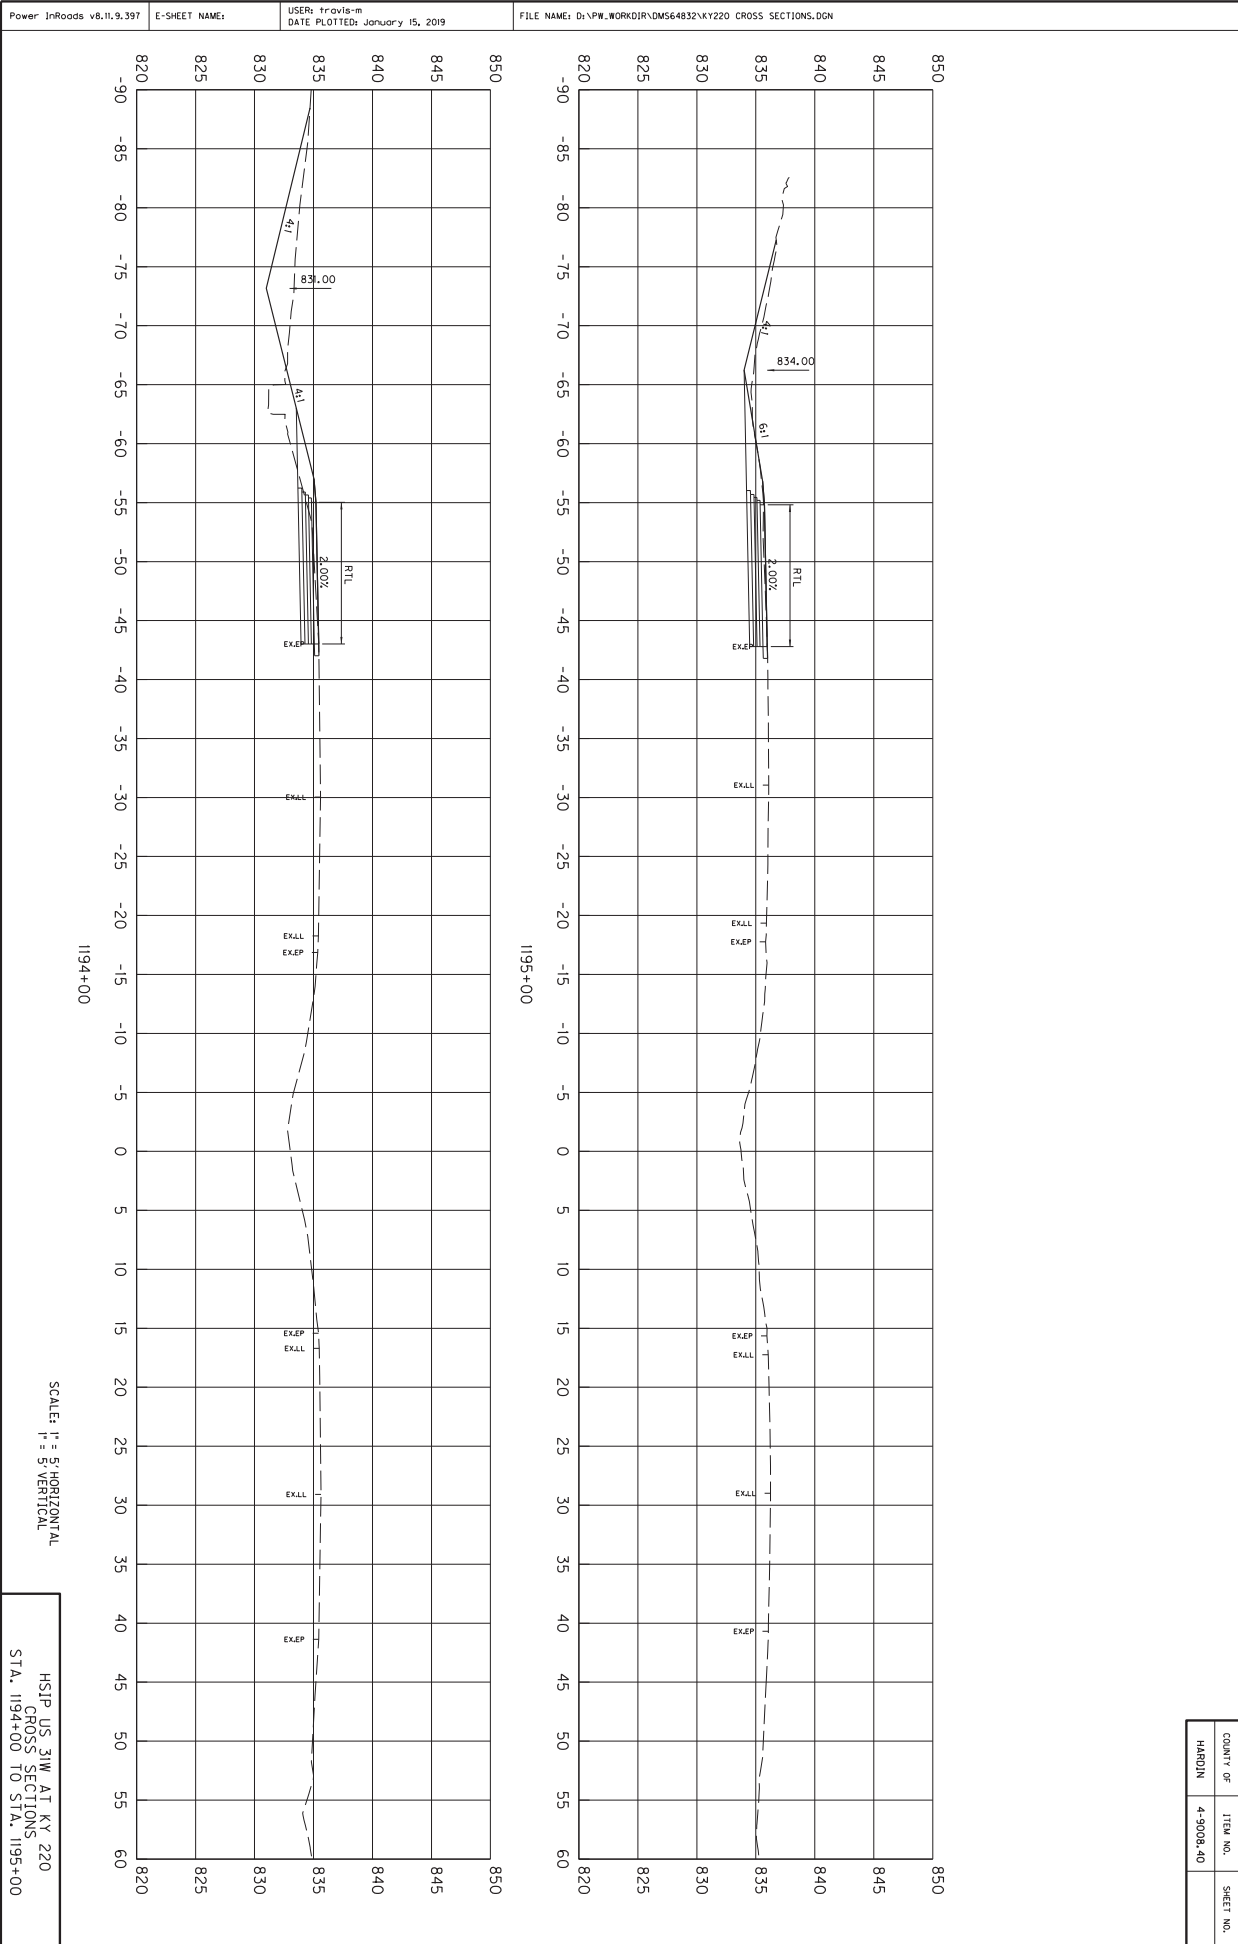


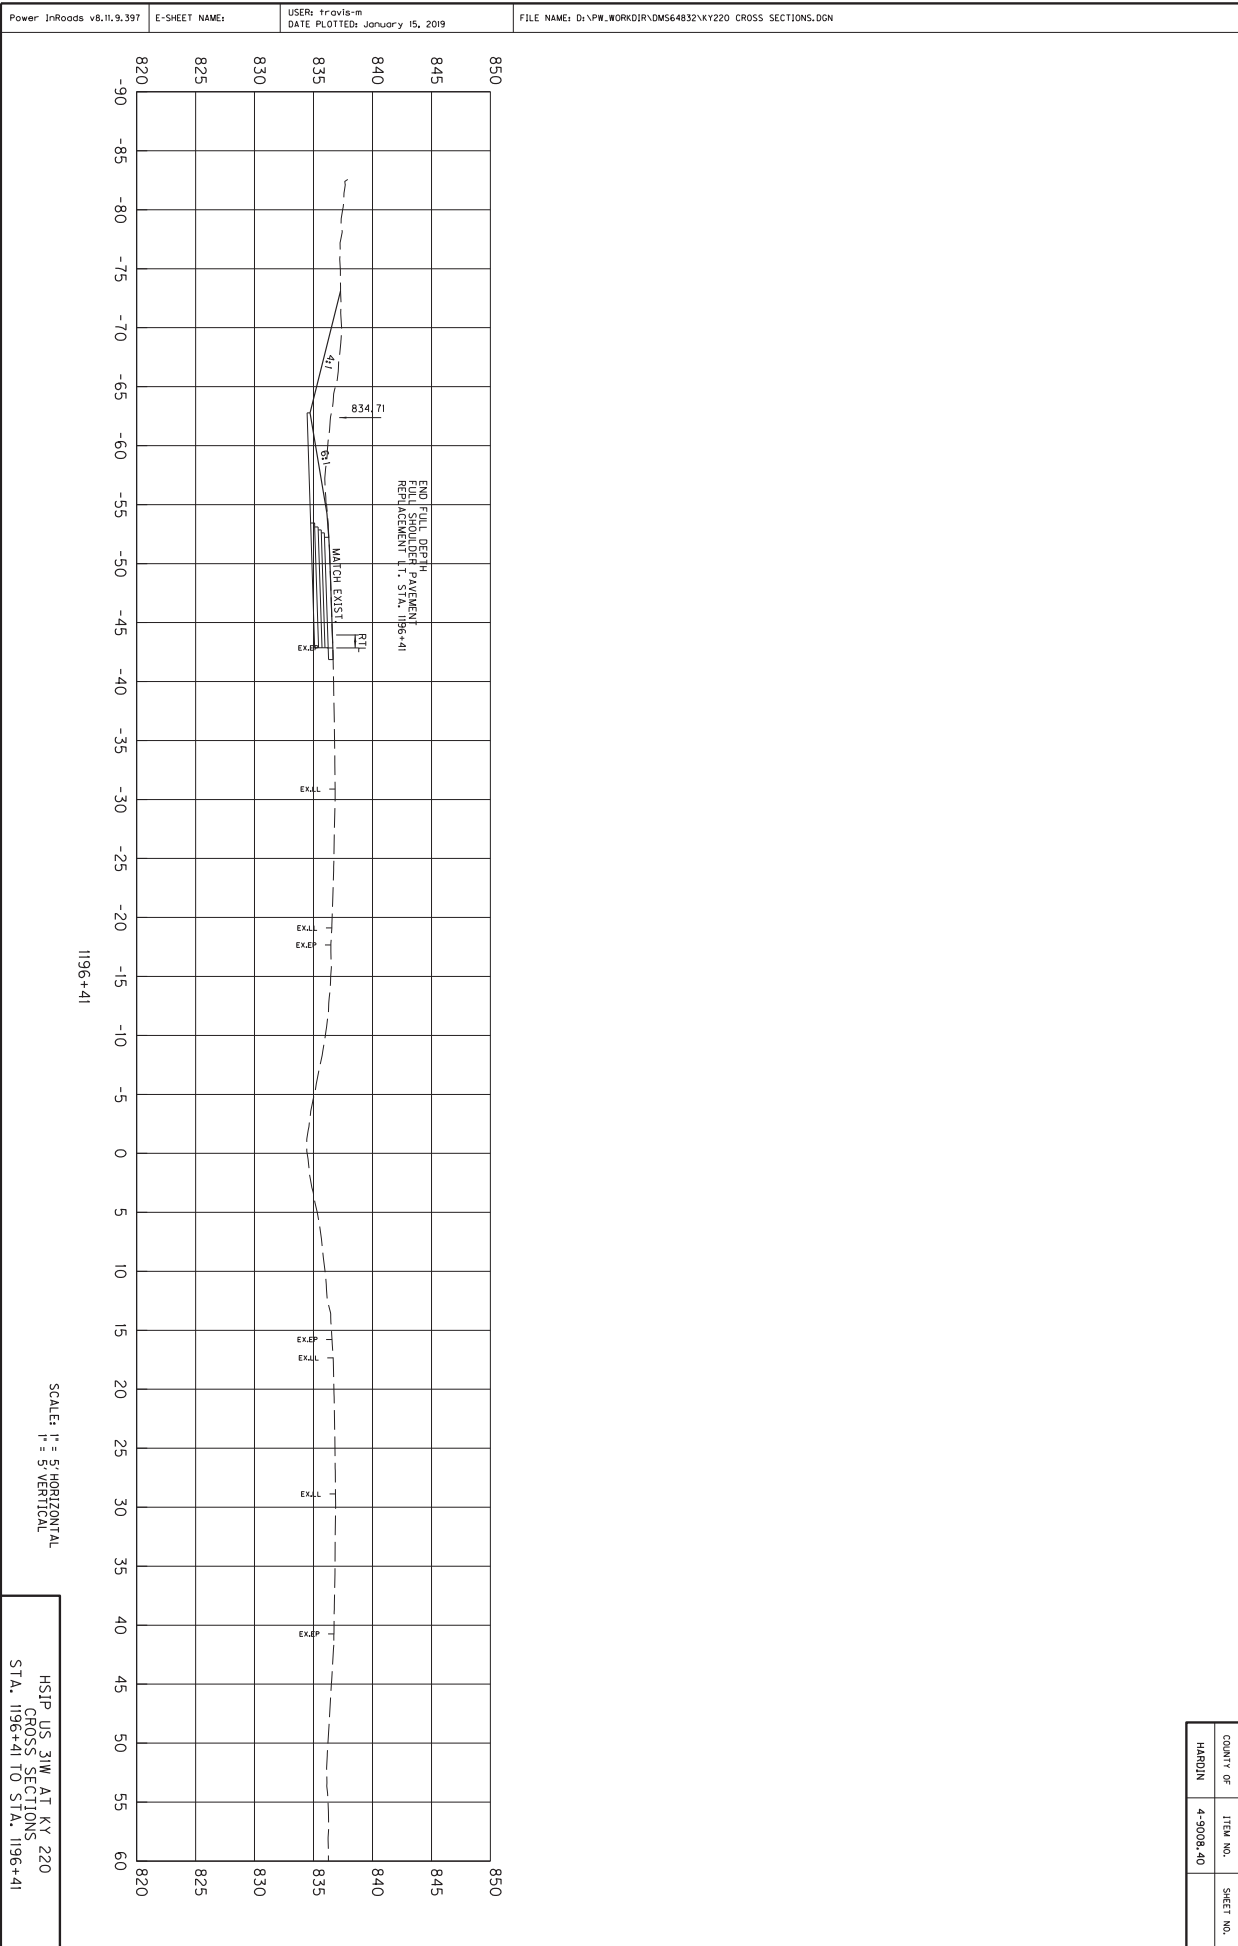

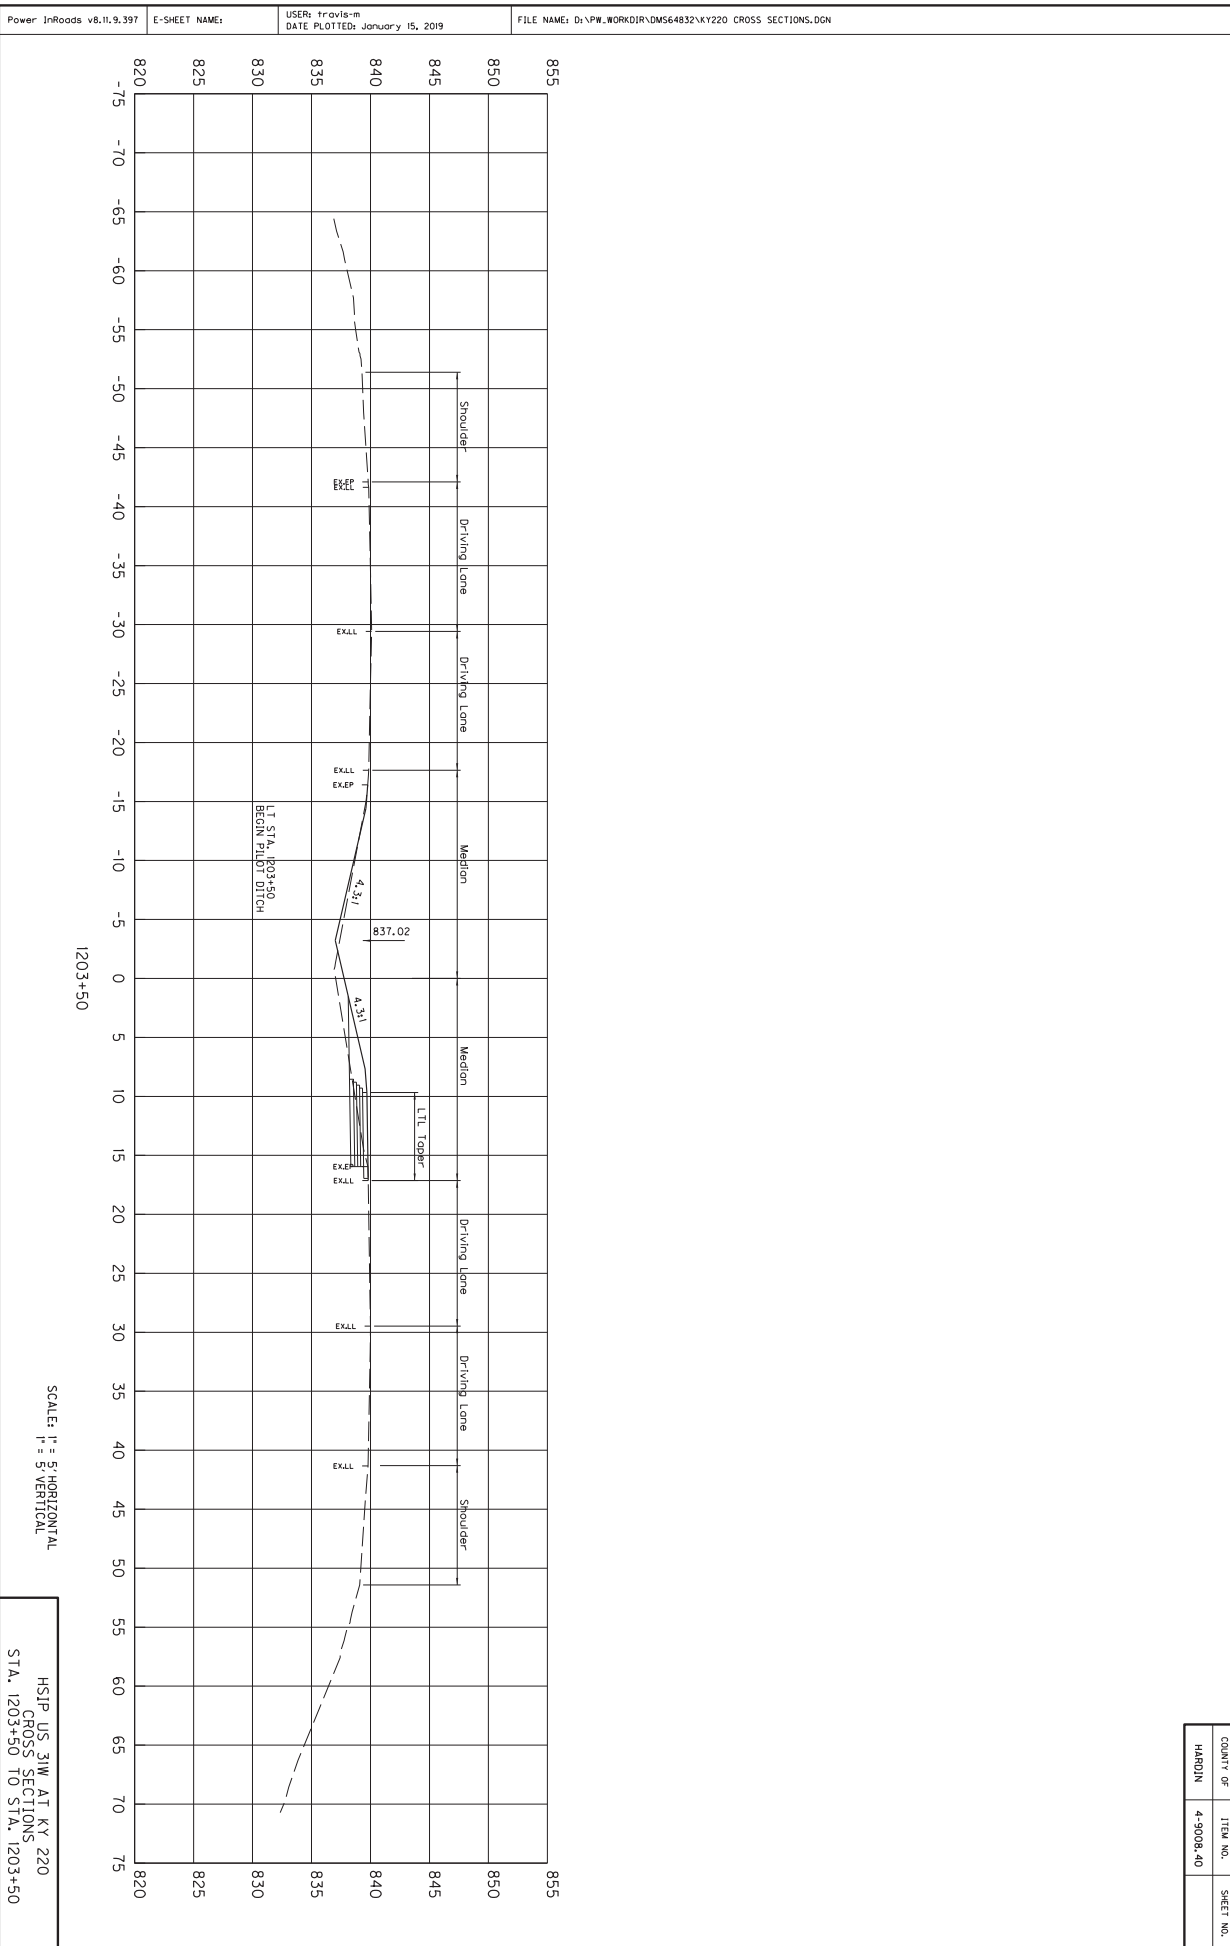

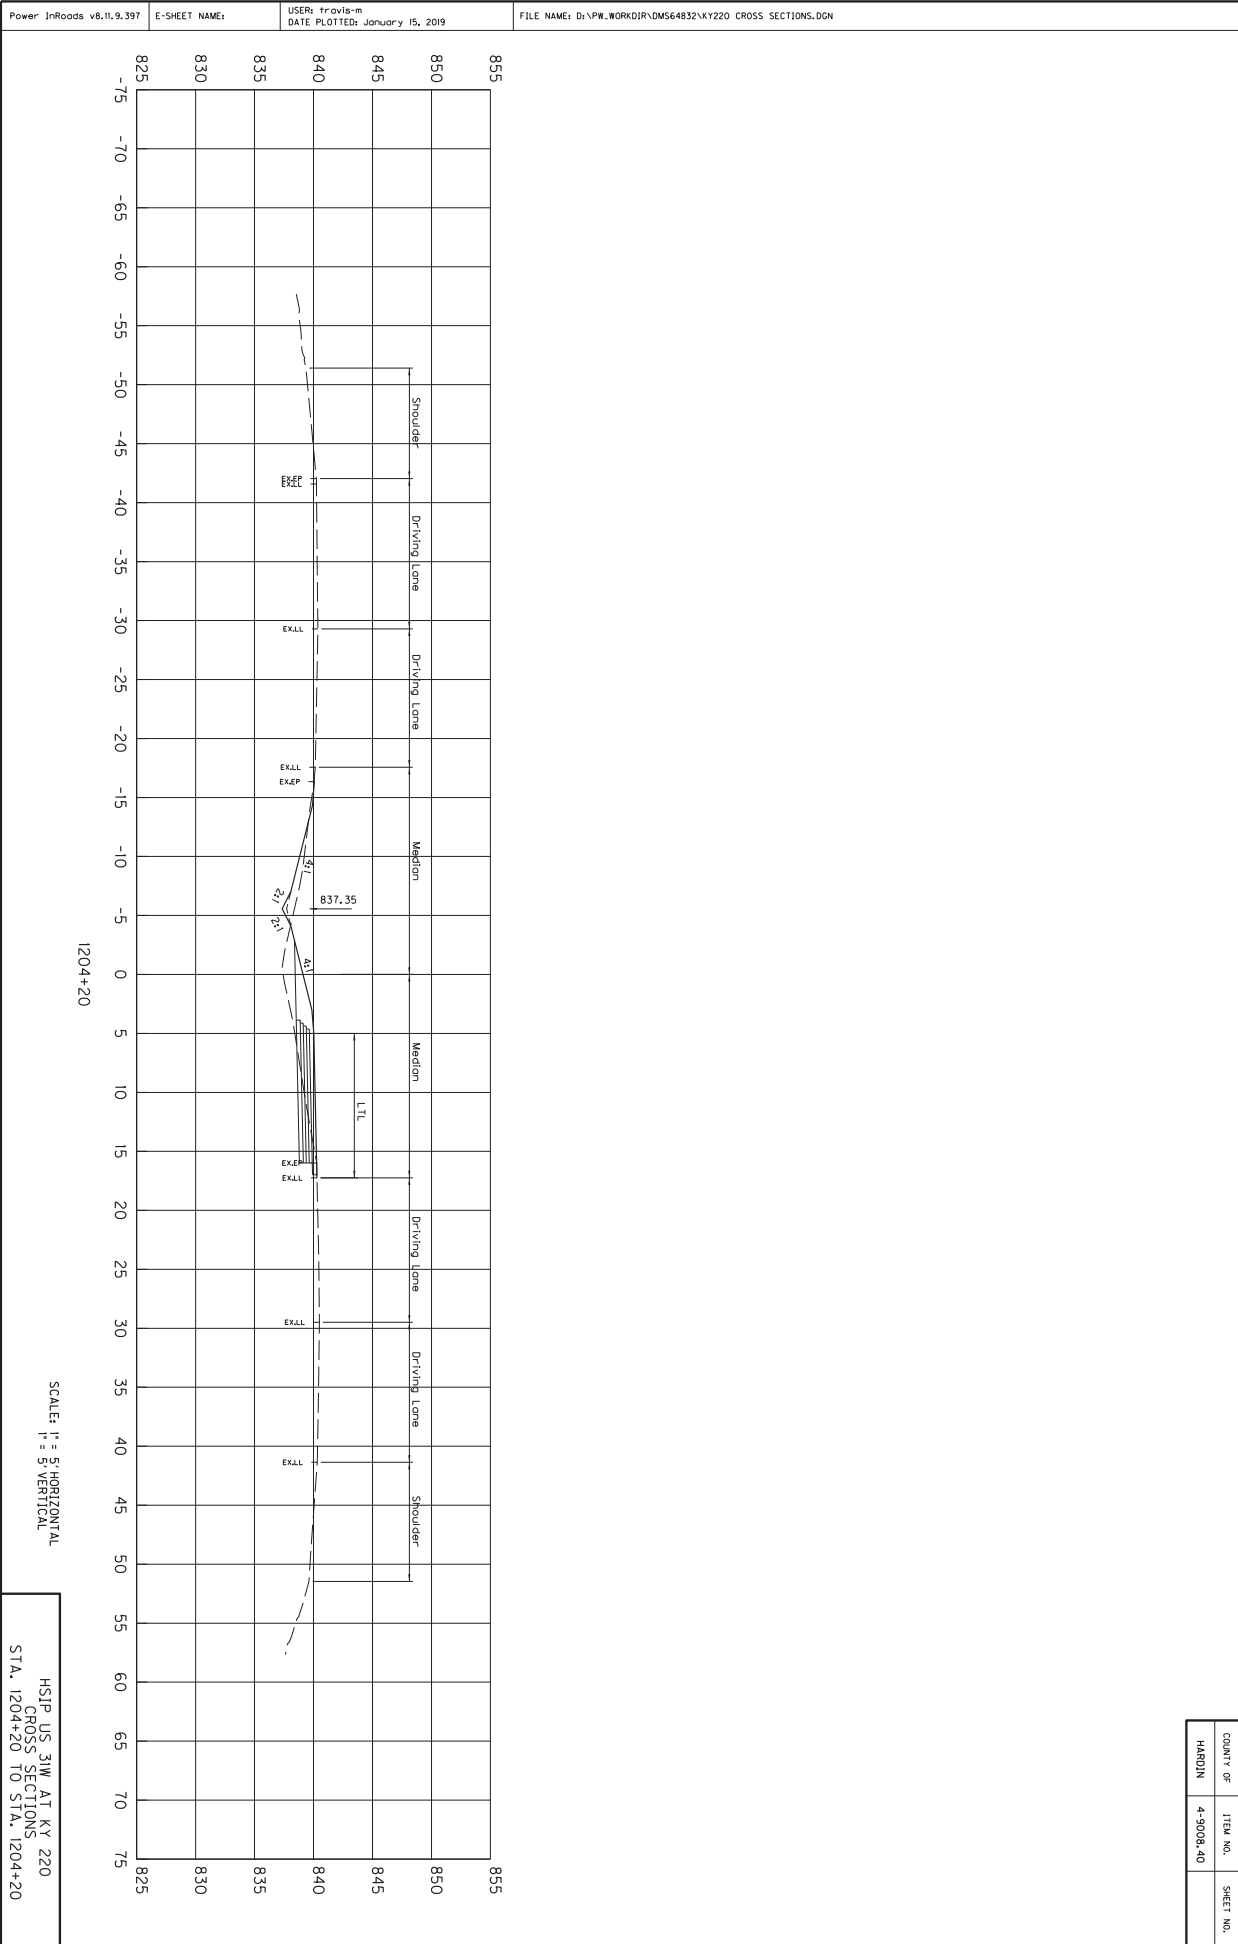

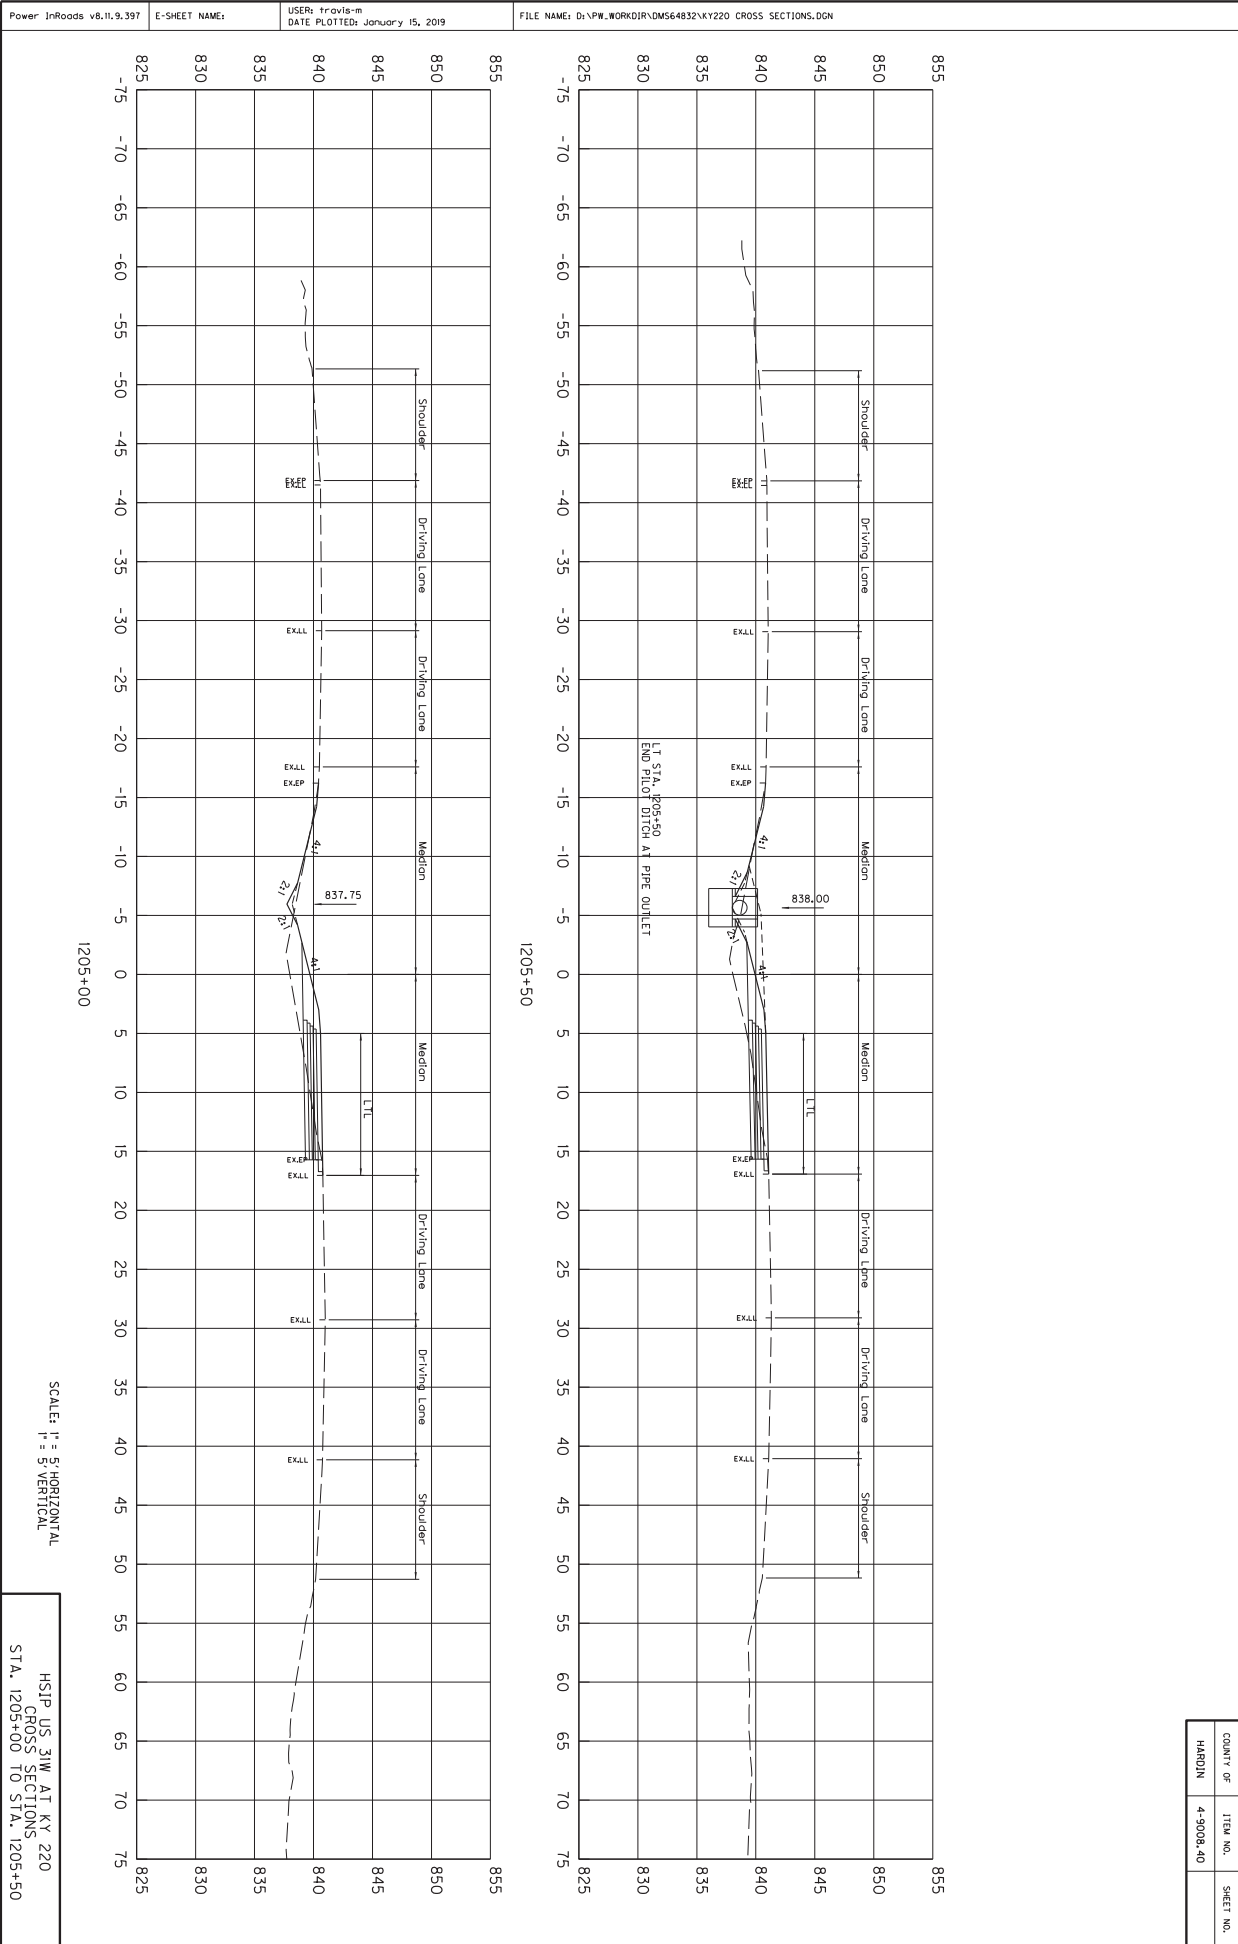


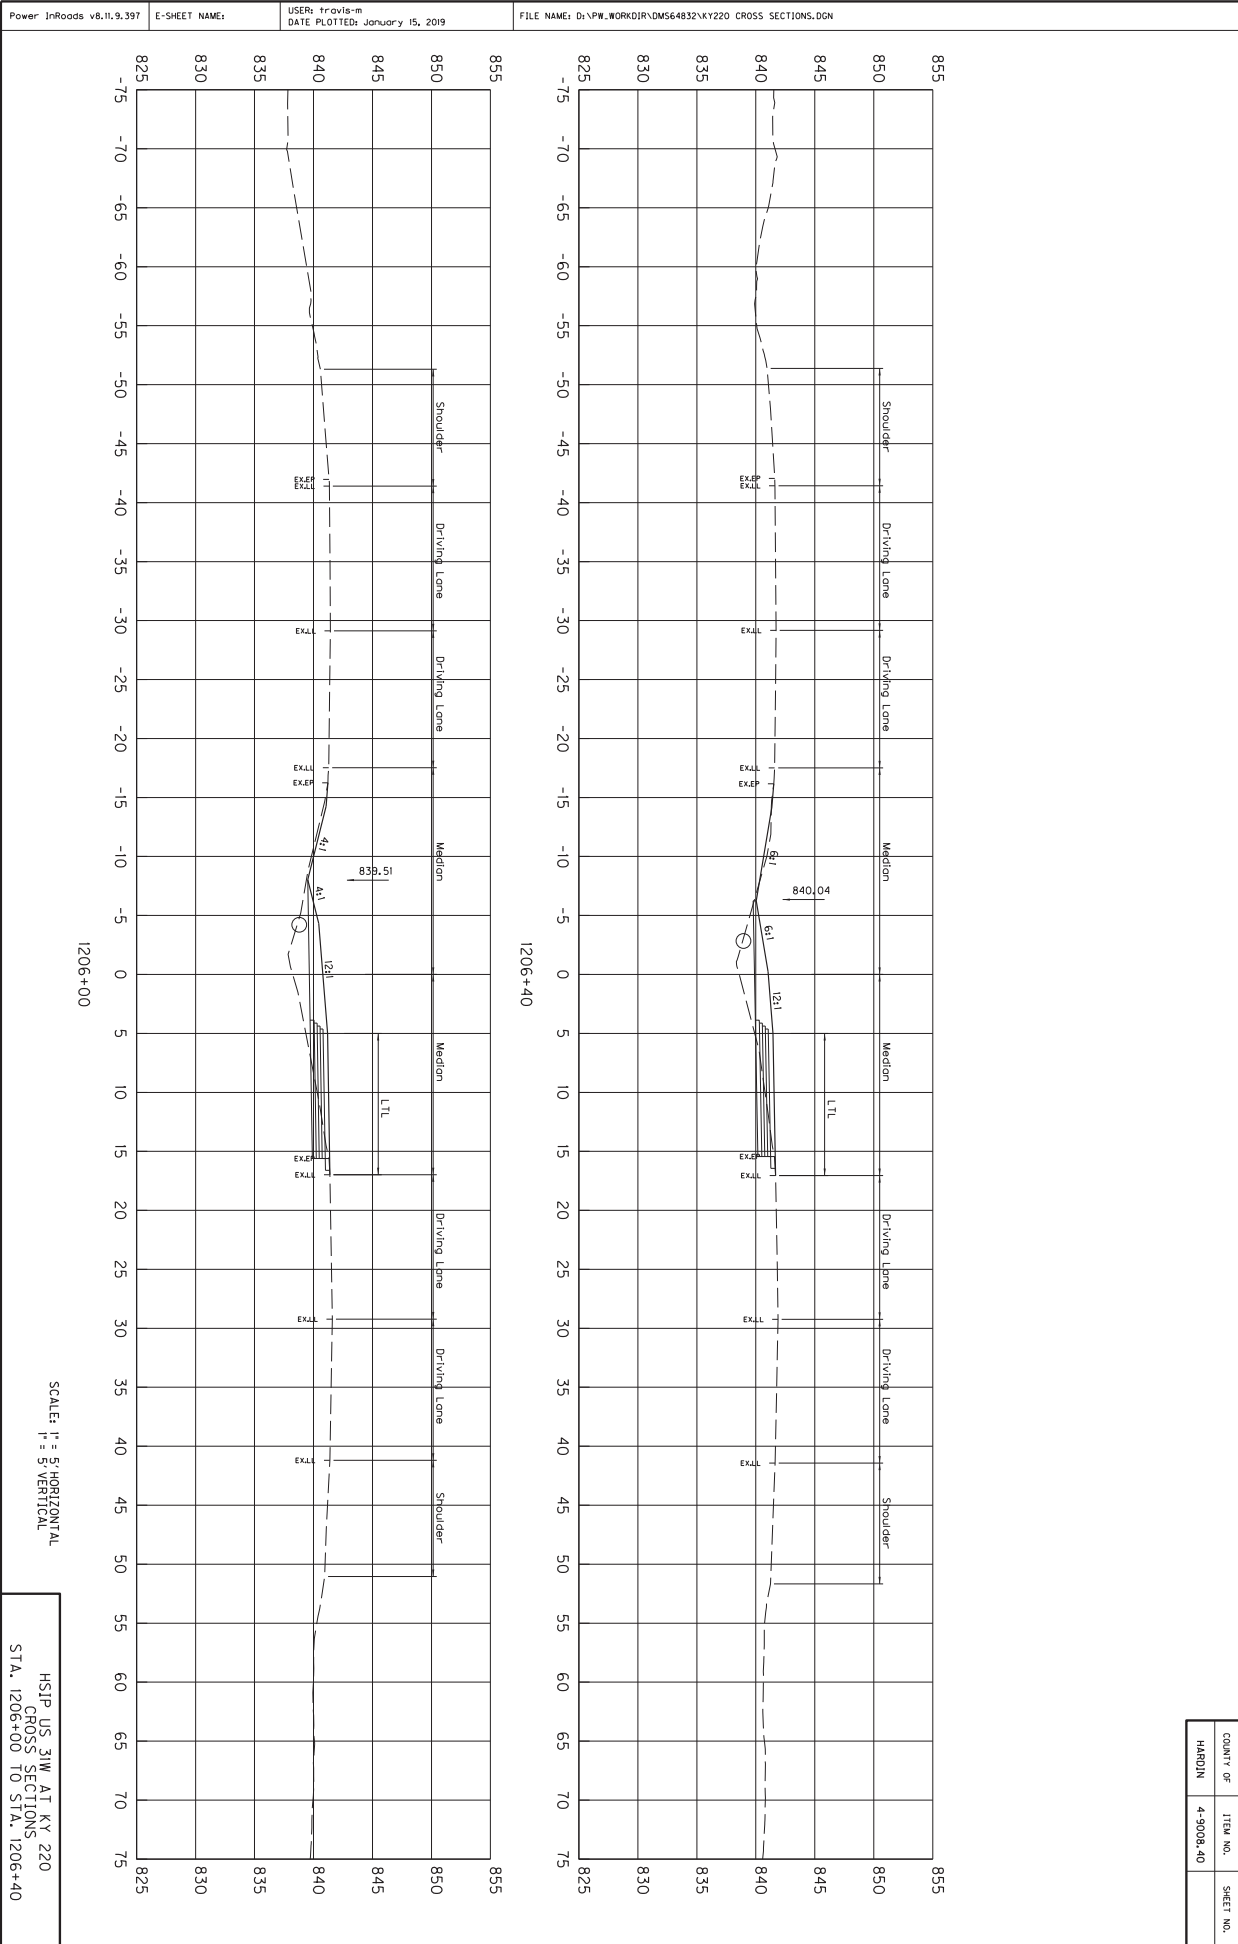

SCALE: H = 5' HORIZONTAL
V = 5' VERTICAL



HSIP US 31W AT KY 220
CROSS SECTIONS
STA. 1206+00 TO STA. 1206+40

COUNTY OF	ITEM NO.	SHEET NO.
HARDIN	4-9008.40	

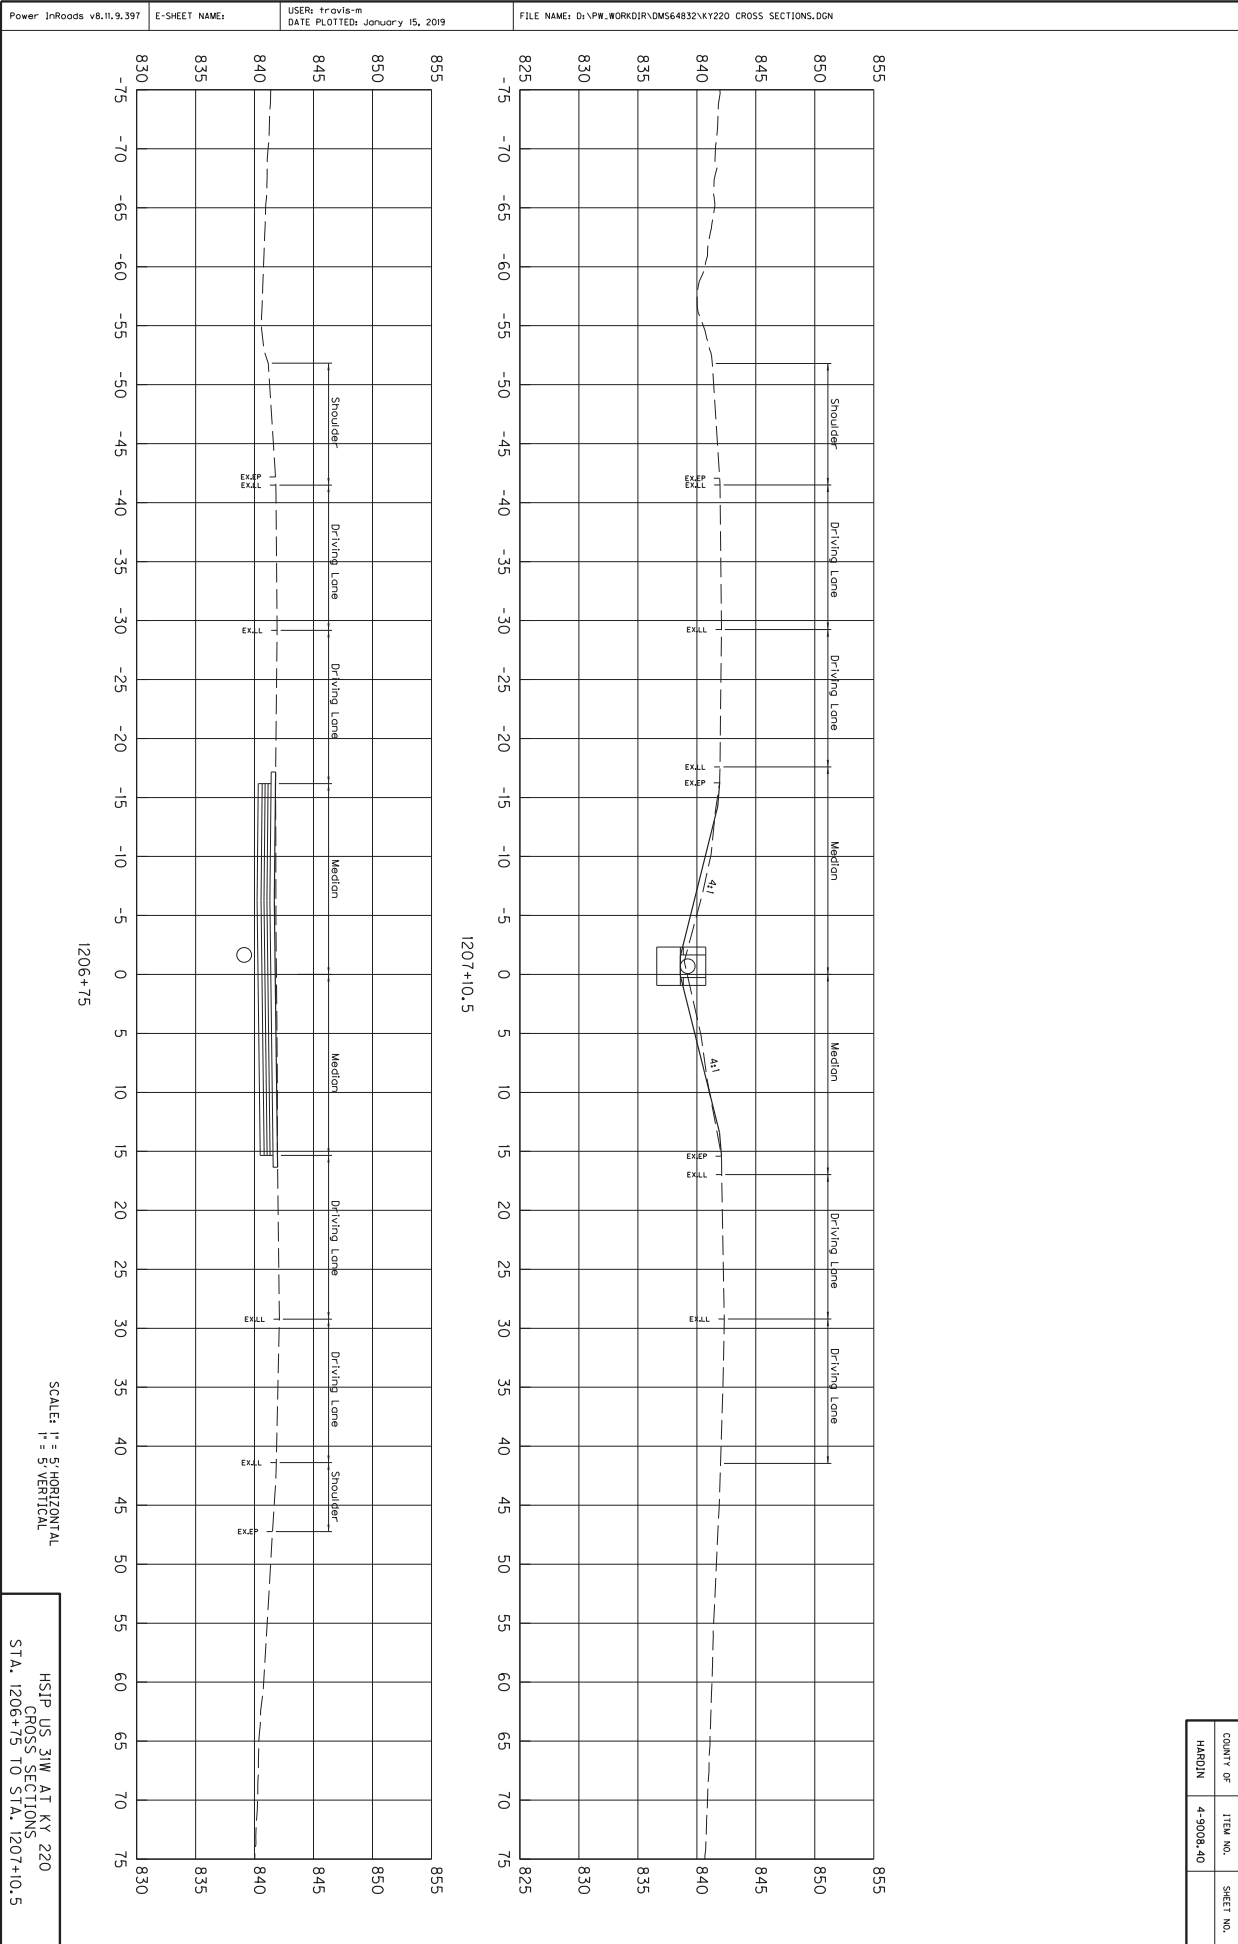


Hardin County
Construction of J-Turns and Intersection Improvements
On US 31W Near KY 434
Item No. 4-9008.40

COUNTY OF	ITEM NO.
HARDIN	4-9008.40

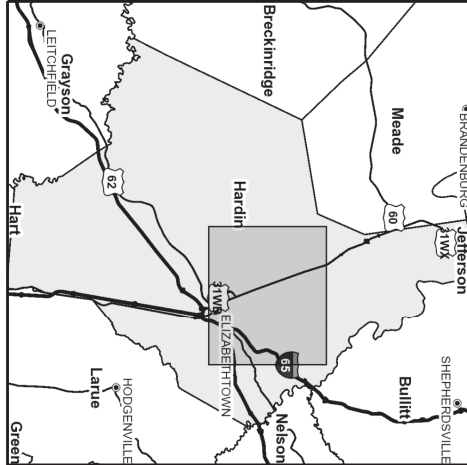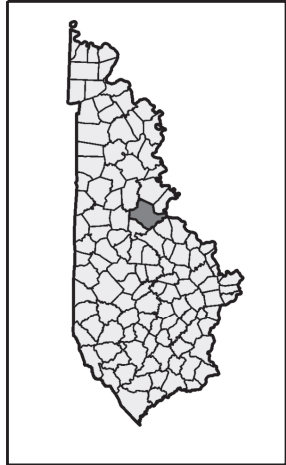


Commonwealth of Kentucky
DEPARTMENT OF HIGHWAYS
PLANS OF
PROPOSED PROJECT
HARDIN COUNTY
US 31W

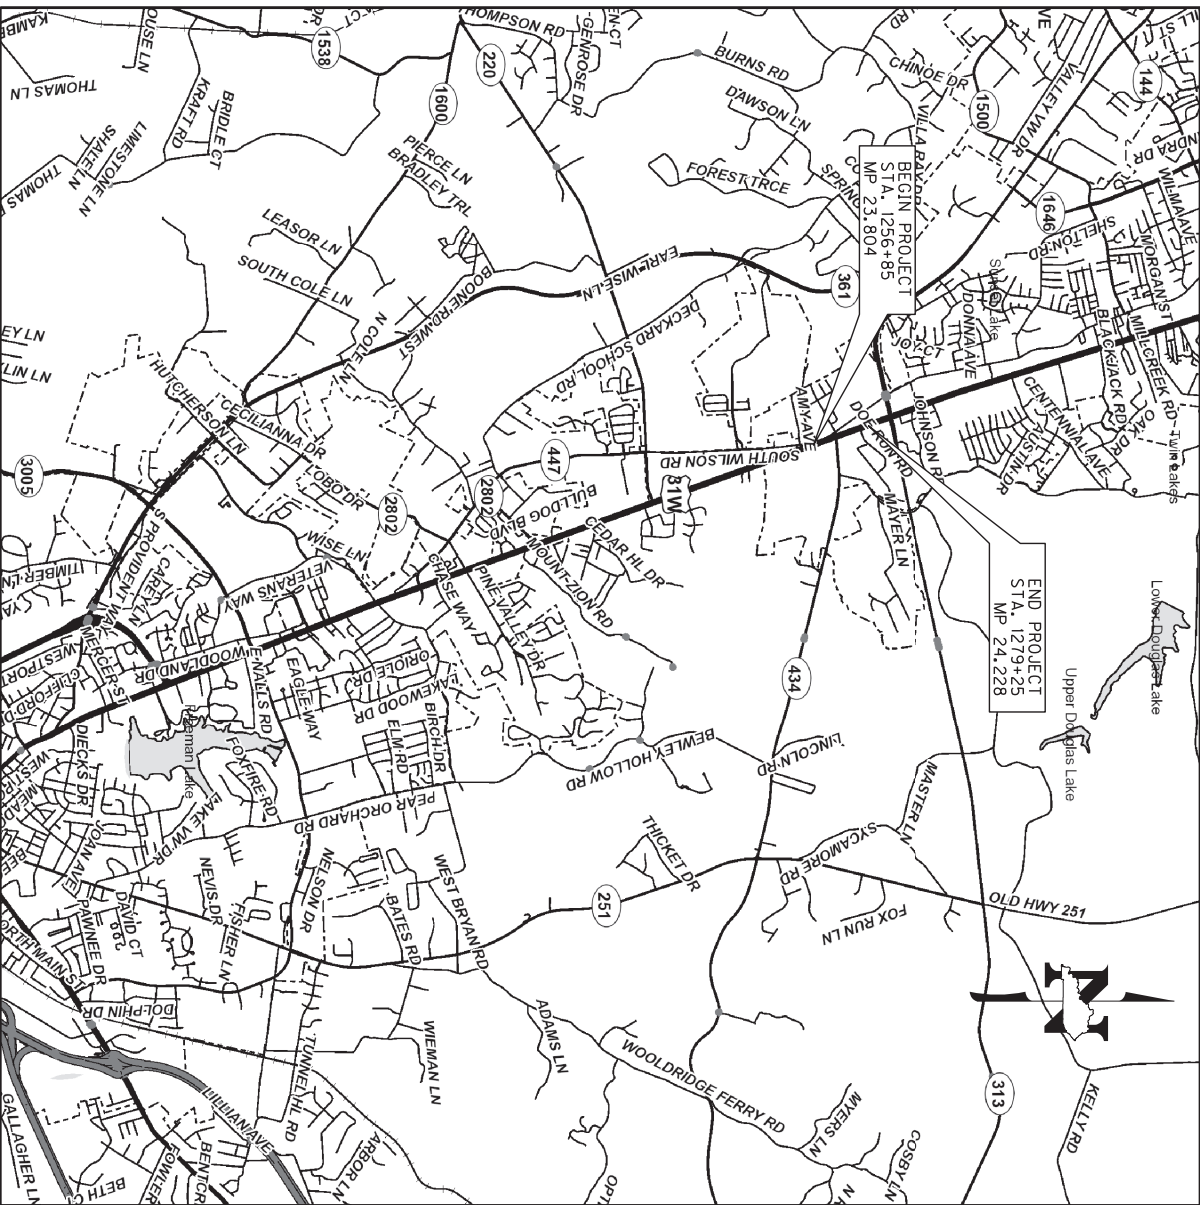

Power InRoads v8.11.9.397 E-SHEET NAME: USER: travis-m DATE PLOTTED: February 11, 2019 FILE NAME: D:\P\WORKDIR\DM564847\TYPICAL KY434.DGN

TYPICAL SECTION AND DETAILS

COUNTY OF	ITEM NO.	SHEET NO.
HARDIN	4-9008.40	

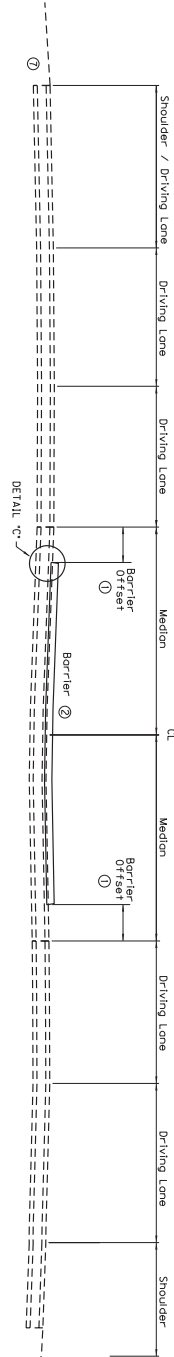


US 31W BARRIER MEDIAN ON EXISTING PAVEMENT

US 31W PAVEMENT DESIGN


- ① 1.5" SURFACE
- ② 1.5" DEPTH CLASS 3 ASPHALT SURFACE 0.38A PG. 76-22
- ③ 3" DEPTH CLASS 3 ASPHALT BASE 1.00D PG. 76-22
- ④ 3" DEPTH CLASS 3 ASPHALT BASE 1.00D PG. 64-22
- ⑤ 3.5" DEPTH CLASS 3 ASPHALT BASE 1.00D PG. 64-22
- ⑥ 4" COMPACTED DEPTH CRUSHED STONE BASE

⑦ BASED ON RECORD PLANS, THE EXISTING PAVEMENT DEPTH IS APPROXIMATELY 16.5" DEEP. FIELD VERIFICATION OF THE EXISTING PAVEMENT THICKNESS TO BE SIGNIFICANTLY DIFFERENT. ADJUSTMENTS MAY BE MADE BY THE ENGINEER TO BEST MATCH THAT THICKNESS.


DETAIL "A"

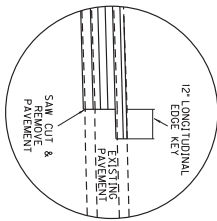


DETAIL "B"

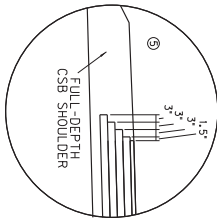

DETAIL "C"

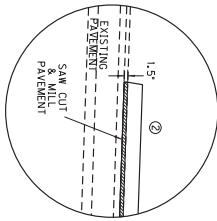

- ① 3' TYPICAL - SEE PLANS AND DETAILS WHERE IT MAY VARY
- ② STANDARD BARRIER MEDIAN TYPE 4
- ③ MATCH EXISTING DRIVING LANE BUT NOT LESS THAN 2.00'
- ④ SEE SECTIONS FOR SIDE SLOPES AND DITCH ELEVATIONS
- ⑤ ASPHALT SEAL COAT REQUIRED FROM OUTSIDE EDGE OF PAVED SURFACE TO INSIDE EDGE OF ASPHALT SEAL COAT APPLICATIONS AND 20 LB/SY ASPHALT SEAL APPROPRIATE TWO APPLICATIONS.
- ⑥ SAW CUT TO BE A BID ITEM PAVEMENT REMOVAL TO BE INCIDENTAL TO ROADWAY EXCAVATION (SEE CROSS SECTIONS)

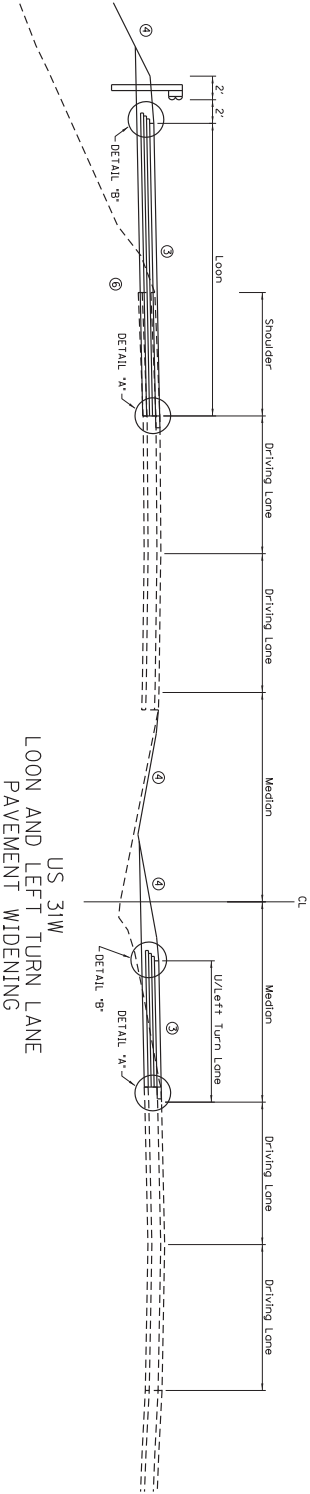



US 31W LOON AND LEFT TURN LANE PAVEMENT WIDENING

NOT TO SCALE






HIGHWAY SAFETY IMPROVEMENT PROGRAM
US 31W AT KY 434
TYPICAL SECTIONS AND DETAILS

Power InRoads v8.11.9.397 E-SHEET NAME: USER: travis-m DATE PLOTTED: February 11, 2019 FILE NAME: D:\PW\WORKDIR\DM564847\TYPICAL KY434.DGN

TYPICAL SECTION AND DETAILS

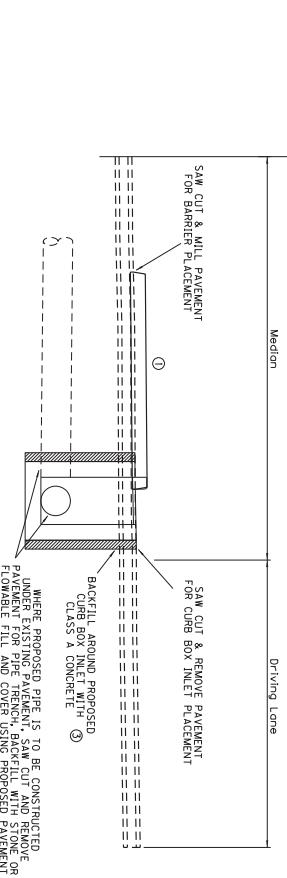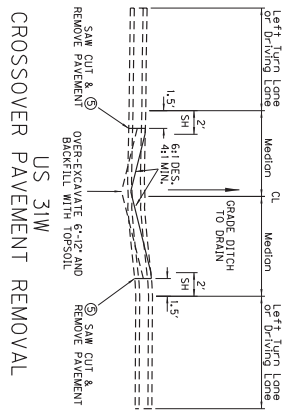

WORK UNDER THIS ITEM SHALL INCLUDE CUTTING OUT THE EXISTING BITUMINOUS SURFACE AND ASPHALT BASE AND REMOVING THE EXISTING SURFACE. THE CONTRACT UNIT PRICE BID PER LINEAR FOOT FOR EDGE KEY SHALL INCLUDE ALL NECESSARY MATERIALS, LABOR AND EQUIPMENT TO FORM THE WORK AND DISPOSE OF THE BITUMINOUS MATERIAL REMOVED.

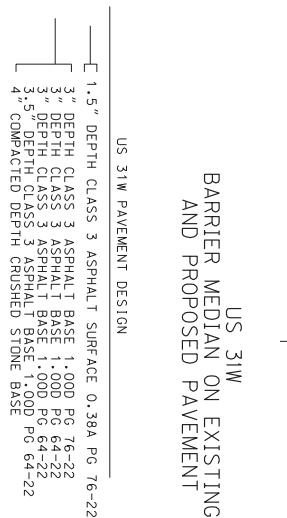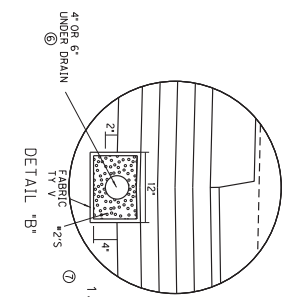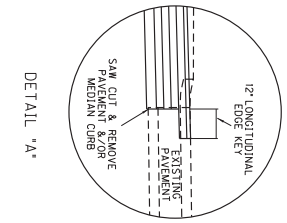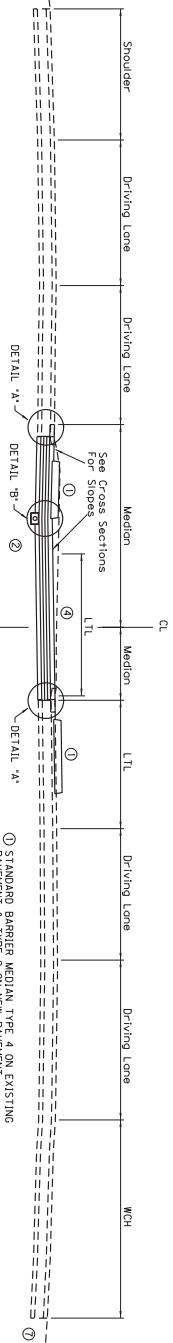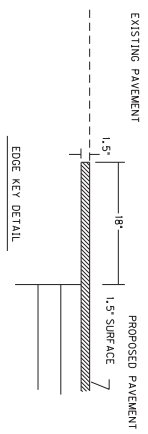

- 1 STANDARD BARRIER MEDIAN TYPE 4 ON EXISTING PAVEMENT & TYPE 2 ON NEW PAVEMENT
- 2 REMOVAL OF EXISTING MOUNTABLE GRASS MEDIAN TO BE INCLUDED IN ROADWAY EXCAVATION (SEE CROSS SECTIONS) REMOVAL OF MEDIAN CURB TO BE A BID ITEM
- 3 CONCRETE QUANTITIES TO BE INCIDENTAL TO BID ITEM FOR CURB BOX INLET
- 4 SEE CROSS SECTIONS FOR PAVEMENT CROSS SLOPE. SAME TO BE BID PER CROSS SECTION LOCATIONS TO BE INCIDENTAL TO ROADWAY EXCAVATION (SEE CROSS SECTIONS)
- 5 CONNECT PIPE TO PROPOSED MEDIAN DRAINAGE BOXES. PIPE MAY BE OMITTED AT MEDIAN CROSSOVERS TO THE MEDIAN DITCH
- 6 BASED ON RECORD PLANS, THE EXISTING PAVEMENT DEPTH IS APPROXIMATELY 15.75" THICK. THE PROPOSED PAVEMENT THICKNESS TO BE SIGNIFICANTLY DIFFERENT. ADJUSTMENTS MAY BE MADE BY THE ENGINEER TO BEST MATCH THAT THICKNESS.


HIGHWAY SAFETY IMPROVEMENT PROJECT
TYPICAL SECTIONS AND DETAILS

COUNTY OF	ITEM NO.	SHEET NO.
HARDIN	4-9008.40	

NOT TO SCALE

TYPICAL SECTION AND DETAILS

COUNTY OF	ITEM NO.	SHEET NO.
HARDIN	4-9008.40	

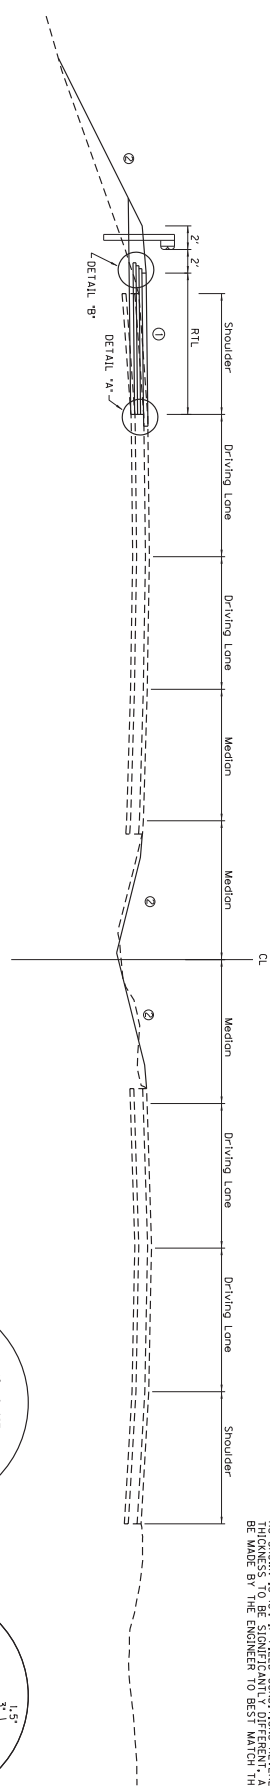

US 31W & KY 434 PAVEMENT DESIGN

1.5" SURFACE
16.5" BASE


US 31W & KY 434 PAVEMENT DESIGN

1.5" DEPTH CLASS 3 ASPHALT SURFACE 0.38A PG. 76-22

3" DEPTH CLASS 3 ASPHALT BASE 1.00D PG. 76-22
3" DEPTH CLASS 3 ASPHALT BASE 1.00D PG. 64-22
3.5" DEPTH CLASS 3 ASPHALT BASE 1.00D PG. 64-22
4" COMPACTED DEPTH CRUSHED STONE BASE




US 31W
ADDED RIGHT TURN LANE

PROFILE

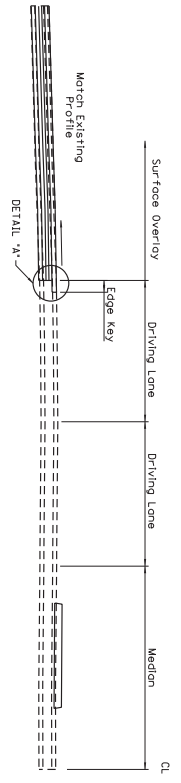

KY 434 WEST PAVEMENT REPLACEMENT DETAIL

CROSS SECTION

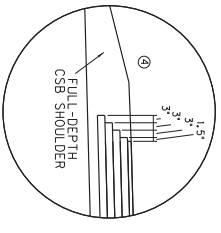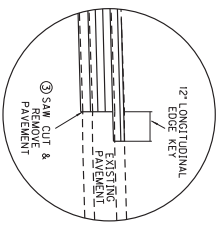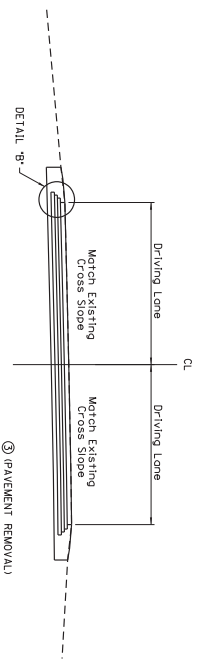

- ① MATCH EXISTING DRIVING LANE BUT NOT LESS THAN 2.00%.
- ② SEE CROSS SECTIONS FOR SIDE SLOPES AND DITCH ELEVATIONS.
- ③ SAW CUT TO BE A BID ITEM; PAVEMENT REMOVAL TO BE INCIDENTAL TO ROADWAY EXCAVATION.
- ④ ASPHALT SEAL COAT REQUIRED FROM OUTSIDE EDGE OF PAVED SHOULDER TO A POINT 2' DOWN THE DITCH OR FULL SLOPE. 2.4 LB/SY ASPHALT SEAL AGGREGATE (TWO APPLICATIONS).
- ⑤ BASED ON RECORD PLANS, THE EXISTING PAVEMENT DEPTH IS AS SHOWN IS 18". IF FIELD CONDITIONS REVEAL THE EXISTING PAVEMENT TO BE SIGNIFICANTLY THINNER, ADJUSTMENTS MAY BE MADE BY THE ENGINEER TO BEST MATCH THE THICKNESS.

Power InRoads v8.11.9.397 E-SHEET NAME: USER: Travis M DATE PLOTTED: June 20, 2019 FILE NAME: D:\PW\WORKDIR\DM564846\KY434 GENERAL SUMMARY.DGN

GENERAL SUMMARY

ITEM	DESCRIPTION	UNIT	TOTAL PROJECT
78	GRAVEL AGGREGATE SIZE NO 2	TON	119
100	PERFORATED PIPE 4IN	LF	410
1010	NON-PERFORATED PIPE 4IN	LF	10
1314	PLUG PIPE	EACH	1
1904	REMOVE CURB	LF	946
1917	STANDARD BARRIER MEDIAN TV 2	SO YD	745
1921	STANDARD BARRIER MEDIAN TV 4	SO YD	155
2159	TEMPORARY DITCH	LF	1120
2160	CLEAN TEMPORARY DITCH	LF	560
2202	WATER EXCAVATION	CU YD	2928
2202	WATER EXCAVATION	M.GAL	475
2351	GUARDRAIL - STEEL W/BEAM - SINGLE FACE	LF	475
2360	GUARDRAIL - TERMINAL SECTION NO 1	EACH	1
2369	GUARDRAIL - END TREATMENT TV 2A	LF	1
2381	REMOVE GUARDRAIL	LF	495
2403	REMOVE CONCRETE MASONRY	CU YD	1.7
2429	RIGHT-WAY MONUMENT TYPE 1	EACH	4
2432	CONCRETE POST	EACH	4
2433	CONCRETE BELL END	EACH	4
2545	CLEANING AND GRISSING	LS	150
2545	CLEANING AND GRISSING	SO FT	213
2585	EDGE KEY	LF	144
2600	FABRIC GEOTEXTILE TYPE IV FOR PIPE	SO YD	1558
2650	MAINTAIN AND CONTROL TRAFFIC	LS	1
2671	PORTABLE CHANGABLE MESSAGE SIGNS	EACH	2
2676	REGULATION FOR MILE & TEXT	LS	13
2676	REGULATION FOR MILE & TEXT	TF	13
2697	ENGINEER GUIDE STRIPS	LF	150
2701	TEMPORARY SILT FENCE	LF	1120
2703	SILT TRAP TYPE A	EACH	1
2704	SILT TRAP TYPE B	EACH	5
2705	SILT TRAP TYPE C	EACH	15
2706	CLEAN SILT TRAP TYPE A	EACH	1
2707	CLEAN SILT TRAP TYPE B	EACH	5
2708	CLEAN SILT TRAP TYPE C	EACH	15
2725	ARROW PANEL	EACH	2
5950	EROSION CONTROL BLANKET	SO YD	6911
5952	TEMPORARY MUD	SO YD	5183
5953	TEMP SEEDING AND PROTECTION	TON	0.34
5953	INITIAL FERTILIZER	TON	0.57
5954	MAINTENANCE FERTILIZER	TON	10083
5955	SEEDING AND PROTECTION	SO YD	627
5955	SEEDING AND PROTECTION	TON	6.27
5959	ASPHALT SEAL COAT	LS	1144
5960	PAVEMENT MARKING - THERMO STOP BAR - 24 INCH	LF	89
6548	PAVEMENT MARKING - THERMO STOP BAR - 24 INCH	SO FT	319
6549	PAVEMENT MARKING - THERMO CROSS-HATCH	EACH	39
6574	PAVEMENT MARKING - THERMO CURVE ARROW	SO FT	279
6598	FUEL ADJUSTMENT	DOLLAR	6088
10020S	SIGNAL ADJUSTMENT	DOLLAR	15291
2020S	CONDITIONAL EYE KEY	LF	3401
2128FD	CONDITIONAL EYE KEY	SO YD	156
2488BFC	ISLAND PAVEMENT MARKERS	EACH	48
2489BFC	ISLAND PAVEMENT MARKERS	SO FT	122
2489BFC	ISLAND PAVEMENT MARKERS	LF	1173
2489BFC	ISLAND PAVEMENT MARKERS	EACH	2
2489BFC	ISLAND PAVEMENT MARKERS	LF	3219
2489BFC	ISLAND PAVEMENT MARKERS	LF	3535

- APPROXIMATELY 2.0 ACRES
- FOR PERFORATED PIPE UNDERGRAN
- FOR PREPARATION OF STANDARD BARRIER MEDIAN TYPE 4 CONSTRUCTION
- FOR THE REMOVAL OF ALL STRIPING AND MARKING THAT WILL CONFLICT WITH FUTURE PROPOSED TRAFFIC PATTERNS OR PROPOSED MARKINGS
- TYPICAL SECTIONS AND DETAILS
- FOR ALL LOCATIONS OF PAVEMENT WIDENING OR REPLACEMENT (SEE ALSO TYPICAL SECTIONS AND DETAILS)

- FOR CONTROLLING DUST CAUSED BY MAINTAINING TRAFFIC ONLY; ESTIMATED AT 19 GAL. PER YARD
- EARTHWORK QUANTITIES ARE APPROXIMATE AND FOR INFORMATION ONLY. EARTHWORK QUANTITIES:
COMMON
EMBARMENT BRNCH
302 CY
- FOR REMOVAL OF CURB AROUND MOUNTABLE GRASS MEDIAN

- TO INCLUDE REMOVAL OF POLES, EQUIPMENT AND CONCRETE BASES; CONCRETE BASES TO BE RECONSTRUCTED AT 4" MIN. THICKNESS AND 4" MIN. COVER. FLASHERS TO BE DELIVERED AT 434 INTERSECTION AND NORTHBOUND WARNING FLASHERS TO ELIZABETHOWN, KY 42701
- BEFORE DELIVERING, CONTACT JANE RIGGS; (270) 401-8132
- FOR REMOVAL OF CONCRETE FLOW IN MEDIAN

HIGHWAY SAFETY IMPROVEMENT PROJECT
US 31W AT KY 434
GENERAL SUMMARY

PAVING AREAS

ITEM	CROSSOVERS & LEFT TURN LANES	LOOPS & RIGHT TURN LANES	ENTRANCES	TOTAL PROJECT
1.5" CL 3 ASPHALT SURFACE 0.38A PG 64-22	3259	1873		5132
3.0" CL 3 ASPHALT BASE 1.00D PG 76-32	3275	1888		5163
3.0" CL 3 ASPHALT BASE 1.00D PG 64-22	3016	1917		4933
3.5" CL 3 ASPHALT BASE 1.00D PG 64-22	3048	1947		4995
3.5" CL 3 ASPHALT BASE 1.00D PG 64-22	3081	1977		5058
4.0" CRUSHED STONE BASE	3119	2011	43	5173
LEVELING & WEDGING PG 64-22	10	10		20
ASPHALT SEAL COAT	487	458		945
ASPHALT SEAL AGGREGATE	487	458		945
ASPHALT MATERIAL FOR TACK NON-TRACKING	12298	7623		20223

PAVING QUANTITIES

ITEM CODE	ITEM	UNIT	CROSSOVERS & LEFT TURN LANES	LOOPS & RIGHT TURN LANES	ENTRANCES	TOTAL PROJECT
316	CL 3 ASPHALT SURFACE 0.38A PG 76-32	TON	269	155		424
216	CL 3 ASPHALT BASE 1.00D PG 76-32	TON	540	312		852
214	CL 3 ASPHALT BASE 1.00D PG 64-22	TON	1594	1018		2612
3	CRUSHED STONE BASE	TON	1223	818	10	2051
103	ASPHALT SEAL COAT	TON	1.2	1.1		2.3
100	ASPHALT SEAL AGGREGATE	TON	9.2	9.2		18.9
24970C	ASPHALT MATERIAL FOR TACK NON-TRACKING	TON	3.1	1.9		5.0
190	LEVELING & WEDGING PG 64-22	TON	1	1		2

- ALL ASPHALT MIXTURES ESTIMATED AT 110 LBS. PER SQUARE YARD PER INCH UNLESS NOTED OTHERWISE
- PAVEMENT AREAS WITHIN THE EXISTING MEDIAN
 - PAVEMENT AREAS OUTSIDE EXISTING LANES; INCLUDES THE RECONSTRUCTION OF THE KY 434 WEST APPROACH
 - ESTIMATED AT 115 LBS. PER SQUARE PER INCH OF DEPTH; QUANTITIES FOR FULL-DEPTH SHOULDERS CALCULATED BY AVERAGE END AREA METHOD
 - ESTIMATED AT 2.40 LBS. PER SQUARE YARD (2 APPLICATIONS)
 - ESTIMATED AT 20 LBS. PER SQUARE YARD (2 APPLICATIONS)
 - ESTIMATED AT 0.50 LBS. PER SQUARE YARD (BETWEEN ASPHALT PAVEMENT COURSES)
 - ESTIMATED QUANTITY FOR MAKING ADJUSTMENTS TO CROSS SLOPES AND WHERE NEEDED AT THE DOWNS, AS DIRECTED BY THE ENGINEER

COUNTY OF: HARJUN
ITEM NO.: 4-9008.40
SHEET NO.

PIPE DRAINAGE SUMMARY


COUNTY OF HARJUN
ITEM NO. 4-9008.40
SHEET NO.

STRUCTURE NO.	ITEM CODE	SKEW	COVER HEIGHT (FT)	DESIGN PH LEVEL	LN FT	LN FT	LN FT	LN FT	LN FT	LN FT	EACH	LN FT	EACH	EACH	EACH	EACH	EACH	REMARKS
	UNIT TO BID HARDIN COUNTY KY 434																	
	1257+76	N/A	2 M		110							116						PROJECTING INLET/OUTLET
	1260+15	N/A	1.5 M		74							4						PROJECTING INLET/OUTLET
	1263+48	0°	4 M		9													EXTEND IN KIND 15" RCP
	1265+80	0°	3 M			14												
	1265+95	0°	3 M			31												
	1266+10	0°	3 M			126												
	1267+37	0°	3 M			130												
	1268+50	0°	3 M			57												
	1273+21.9	0°	4 M				9					4						EXTEND IN KIND 24" CMP
	1274+69	0°	6 M								1							SLOPED & FLARED HEADWALL: JBOX SIZE No 5
	1275+88	0°	8.8 M															
	1276+25	0°	4 M				36											
	1276+50	0°	3.3 M			31												
	1277+00	0°	3.3 M			51												
	1278+00	0°	3.7 M			98												
	PROJECT TOTAL				119	74	538	433	9	1	268	1	1	10	4	1	2	

NOTES: IF A PIPE COLLAR OR BEND CONNECTION IS NEEDED FOR CONSTRUCTION OF A PIPE EXTENSION,
IT SHALL BE CONSIDERED INCIDENTAL TO THE COST OF THE PIPE BEING CONSTRUCTED.

① INCLUDES ADDITIONAL 144 LF FROM PLANS

HIGHWAY SAFETY IMPROVEMENT PROJECT
US 31W AT KY 434
PIPE DRAINAGE SUMMARY

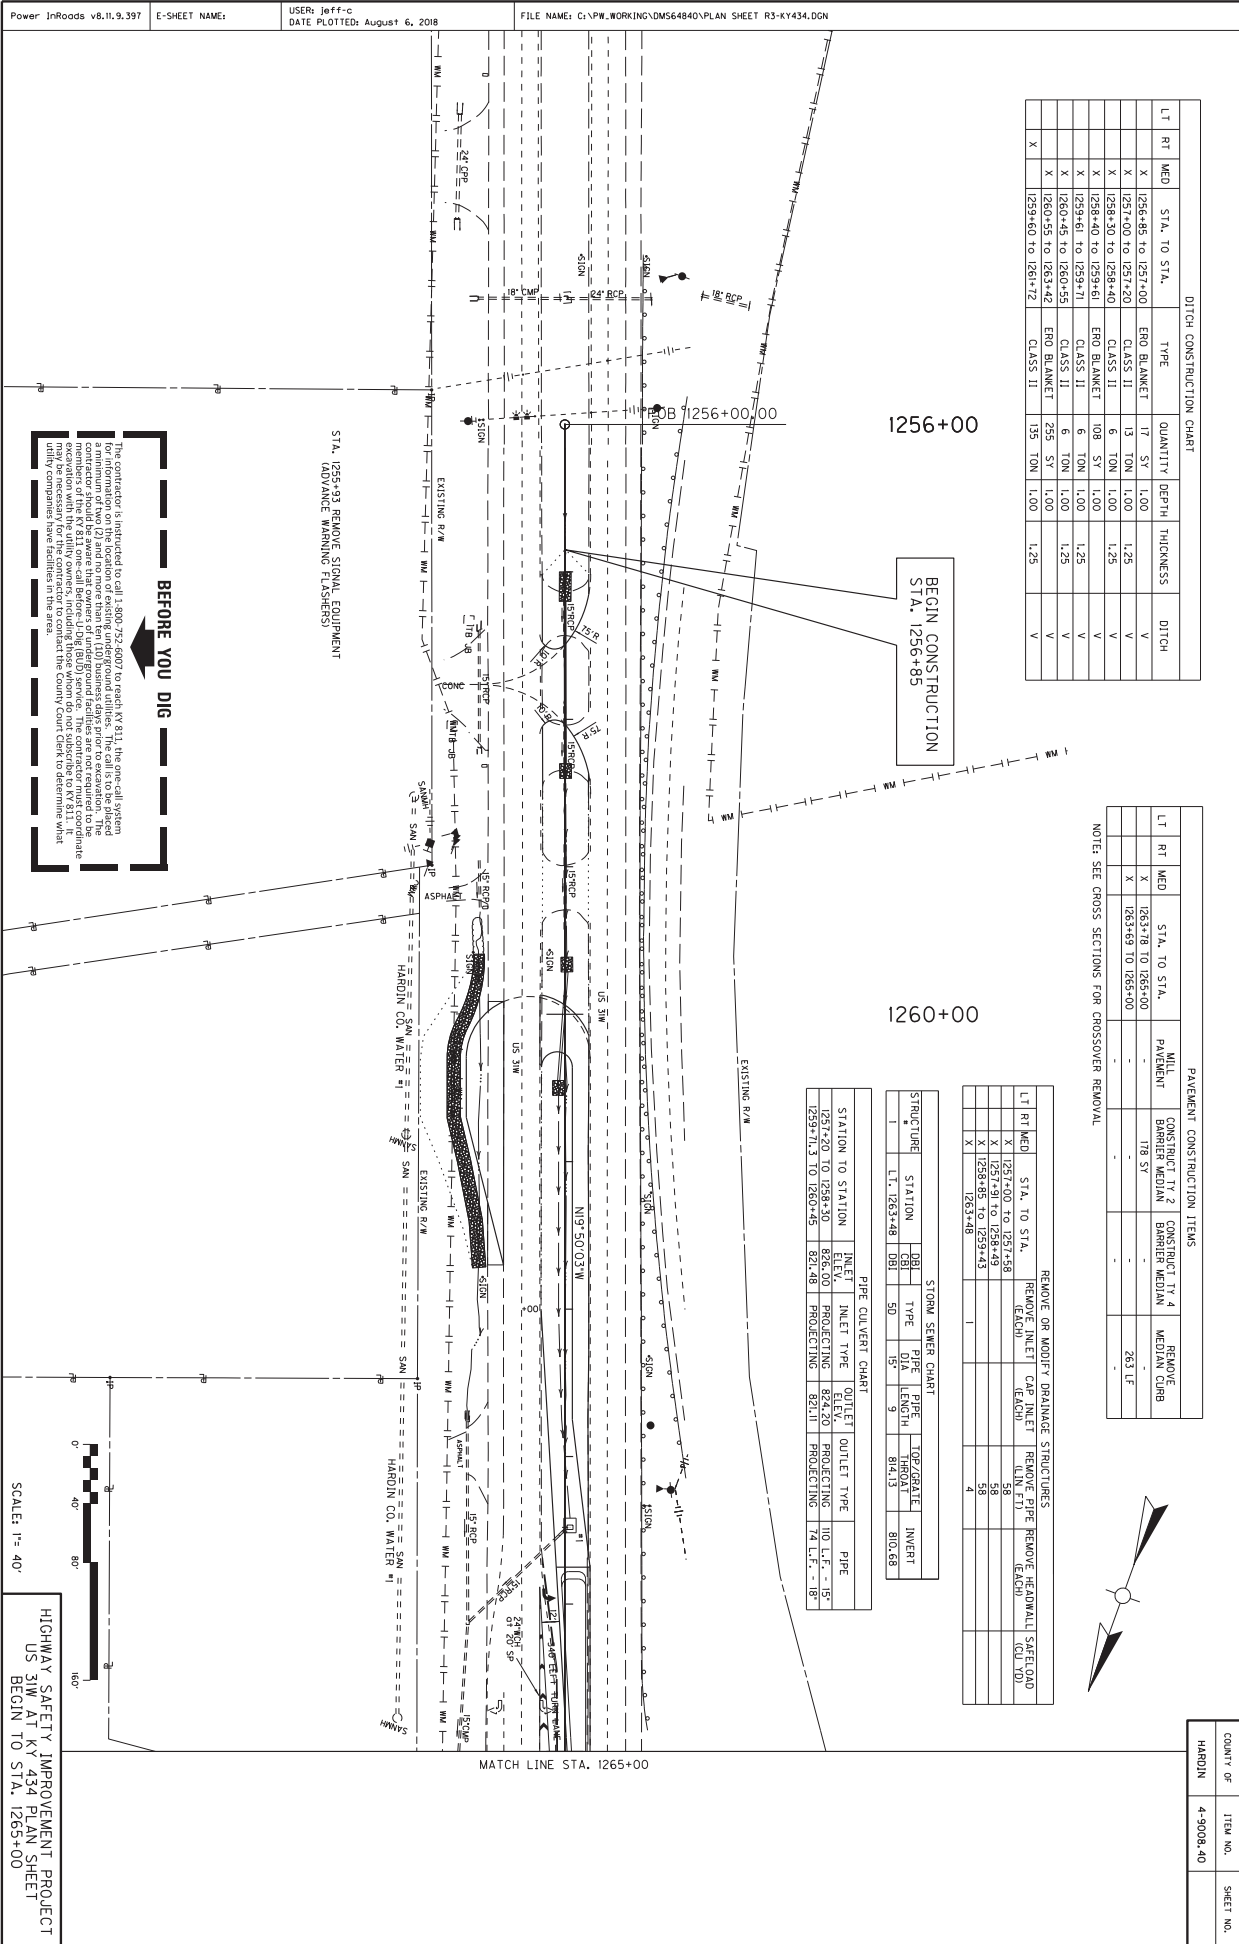

DITCH CONSTRUCTION CHART

LT	RT	MED	STA. TO STA.	TYPE	QUANTITY	DEPTH	THICKNESS	DITCH
	X		1255+48 TO 1257+00	ERO BLANKET	17 SY	1.00		V
	X		1257+00 TO 1257+20	CLASS II	6 TON	1.00	1.25	V
	X		1258+30 TO 1258+40	CLASS II	6 TON	1.00	1.25	V
	X		1258+40 TO 1259+71	ERO BLANKET	109 SY	1.00		V
	X		1259+61 TO 1259+71	CLASS II	6 TON	1.00	1.25	V
	X		1260+45 TO 1260+55	CLASS II	6 TON	1.00	1.25	V
	X		1260+55 TO 1263+42	ERO BLANKET	255 SY	1.00		V
	X		1259+60 TO 1261+72	CLASS II	135 TON	1.00	1.25	V

PAVEMENT CONSTRUCTION ITEMS

LT	RT	MED	STA. TO STA.	MATERIAL	CONSTRUCT TYPE	CONSTRUCT TYPE	REMOVE
	X		1263+18 TO 1265+00	PAVEMENT	BRIDGE	BRIDGE	263 LF
	X		1263+69 TO 1265+00				

NOTE: SEE CROSS SECTIONS FOR CROSSOVER REMOVAL

REMOVE OR MODIFY DRAINAGE STRUCTURES

LT	RT	MED	STA. TO STA.	REMOVE INLET	REMOVE CATCH	REMOVE MANHOLE	REMOVE SAFETY CURB
	X		1257+40 TO 1257+58	0	0	58	0
	X		1257+58 TO 1258+49	0	0	58	0
	X		1258+49 TO 1259+43	0	0	43	0
	X		1259+43 TO 1263+48	0	0	48	0

PIPE CULVERT CHART

STRUCTURE	STATION	INLET TYPE	INLET	OUTLET TYPE	OUTLET	PIPE LENGTH	TOP/GRABBLE	INVERT
1	1263+48	DBI	50	IS	9	84.13	810.68	

BEFORE YOU DIG

The contractor is instructed to call 1-800-752-ADDT to reach KY 811, the one-call system for information on the location of existing underground utilities. The call is to be placed a minimum of two (2) and no more than ten (10) business days prior to excavation. The contractor must coordinate with the utility companies to determine what utility companies have facilities in the area.


HIGHWAY SAFETY IMPROVEMENT PROJECT
US 31W AT KY 434 PLAN SHEET
BEGIN TO STA. 1265+00

COUNTY OF
HARDIN

ITEM NO.
4-9008.40

SHEET NO.
125

Power InRoads v8.11.9.397 E-SHEET NAME: USER: jeff-c DATE PLOTTED: February 11, 2019 FILE NAME: C:\PW_WORK\INC\DM564840\PLAN SHEET R4-KY434.DGN

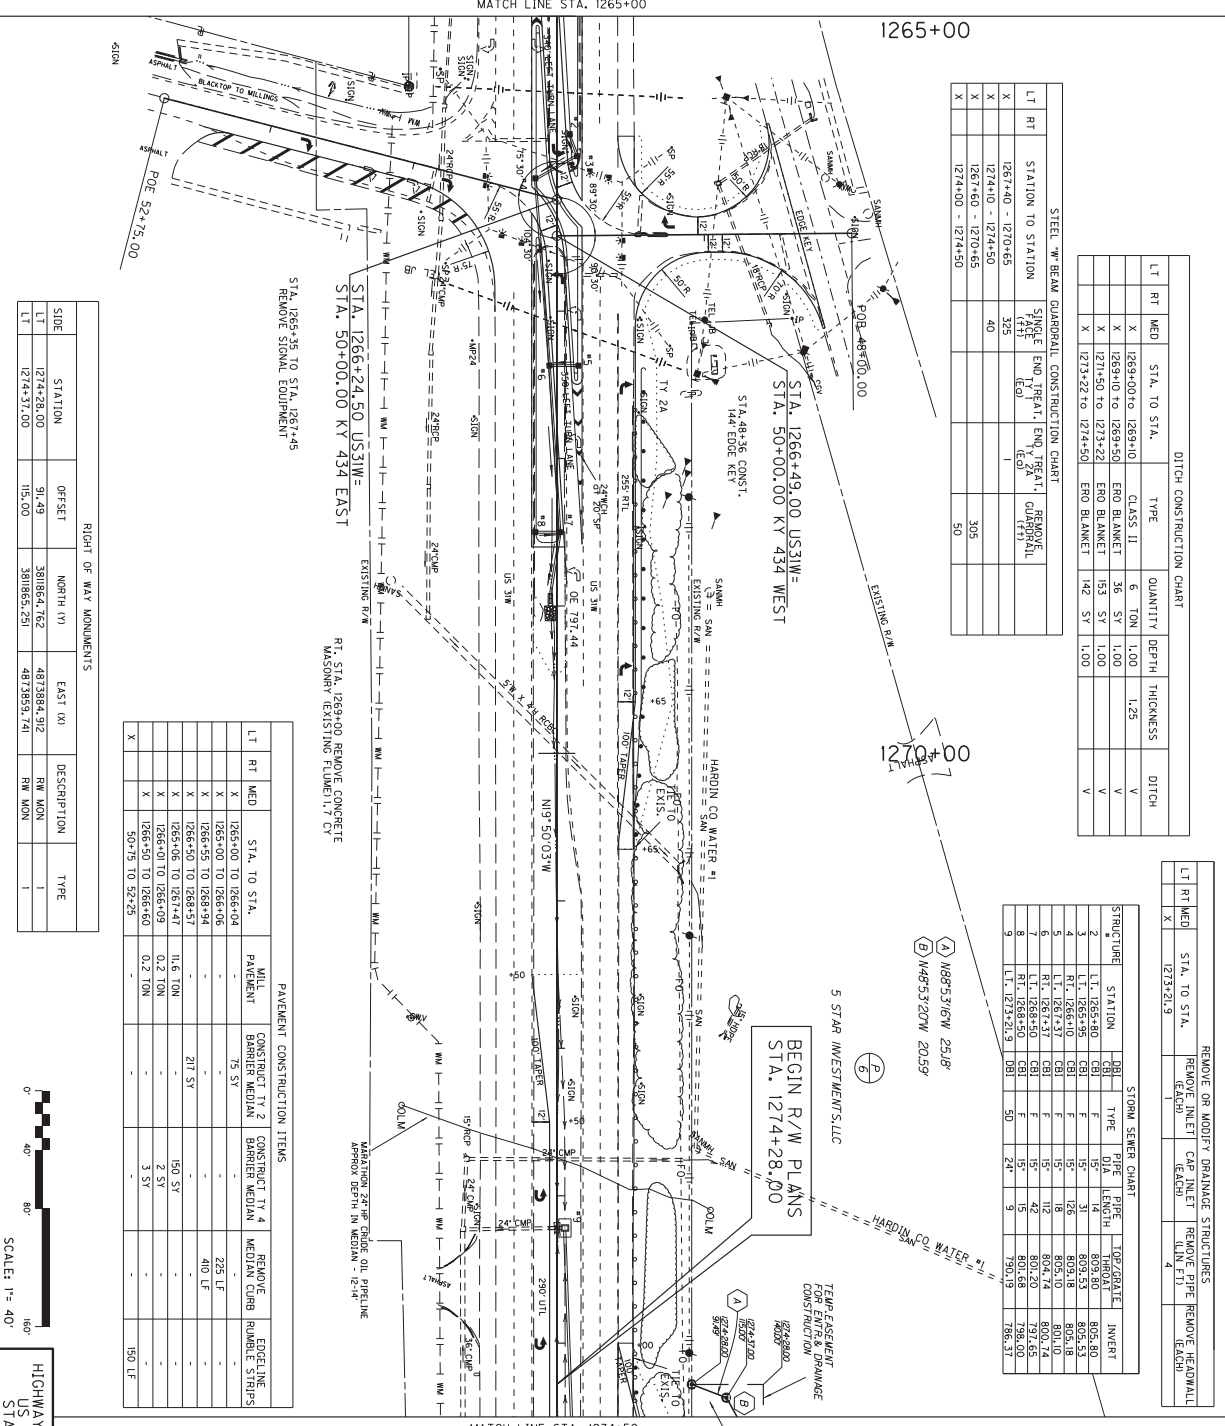

DITCH CONSTRUCTION CHART

LT	RT	MED	STA. TO STA.	TYPE	CLASS	QUANTITY	DEPTH	THICKNESS	DITCH
			1268+00 TO 1269+00	END BLANKET	6" TON	36 SY	1.00	1.25	V
			1269+00 TO 1273+22	END BLANKET	6" TON	153 SY	1.00		V
			1273+22 TO 1274+50	END BLANKET	6" TON	142 SY	1.00		V

STEEL W/ BEAM GUARDRAIL CONSTRUCTION CHART

LT	RT	MED	STA. TO STA.	TYPE	CLASS	QUANTITY	DEPTH	THICKNESS	DITCH
			1267+40 - 1270+65	REMOVE COUNTERAIL	1 (TYP)				
			1274+00 - 1274+50	REMOVE COUNTERAIL	1 (TYP)				

RIGHT OF WAY MONUMENTS

SIDE	STATION	OFFSET	NORTH (N)	EAST (E)	DESCRIPTION	TYPE
LT	1274+28.00	91.49	381864.762	4817884.912	RM MON	I
LT	1274+37.00	115.00	381865.251	4817853.741	RM MON	I

PAVEMENT CONSTRUCTION ITEMS

LT	RT	MED	STA. TO STA.	WILL PAVEMENT	CONSTRUCT TY 2 BARRIER MEDIAN	CONSTRUCT TY 4 BARRIER MEDIAN	REMOVE MEDIAN CURB	REMOVE EDGELINE	REMOVE RUMBLE STRIPS
			1265+00 TO 1266+04		75 SY			225 LF	
			1266+04 TO 1266+10					410 LF	
			1266+10 TO 1266+24						
			1266+24 TO 1266+34		217 SY				
			1266+34 TO 1266+49					150 SY	
			1266+49 TO 1266+50					2 SY	
			1266+50 TO 1266+60					3 SY	
			50+75 TO 52+25						150 LF

STORM SEWER CHART

STRUCTURE	STATION	DIAM.	TYPE	LENGTH	1097 ELEV.	INVERT
2	L.I. 1265+80	15"	F	14	803.80	805.80
3	L.I. 1265+95	15"	F	31	803.53	805.53
4	L.I. 1266+10	15"	F	18	805.10	807.10
5	L.I. 1267+37	15"	F	112	800.74	800.74
6	L.I. 1268+30	15"	F	151	801.20	797.65
7	L.I. 1268+50	15"	F	42	801.20	798.00
8	L.I. 1273+51.9	50"	24"	9	790.19	789.13




HIGHWAY SAFETY IMPROVEMENT PROJECT
US 31W AT KY 434 PLAN SHEET
STA. 1265+00 TO STA. 1274+50

COUNTY OF
HARDIN

ITEM NO.
4-9008.40

SHEET NO.

Power InRoads v8.11.9.397 E-SHEET NAME: USER: jeff-c DATE PLOTTED: February 11, 2019 FILE NAME: C:\PW\WORKING\DM564840\PLAN SHEET R5-KY434.DGN

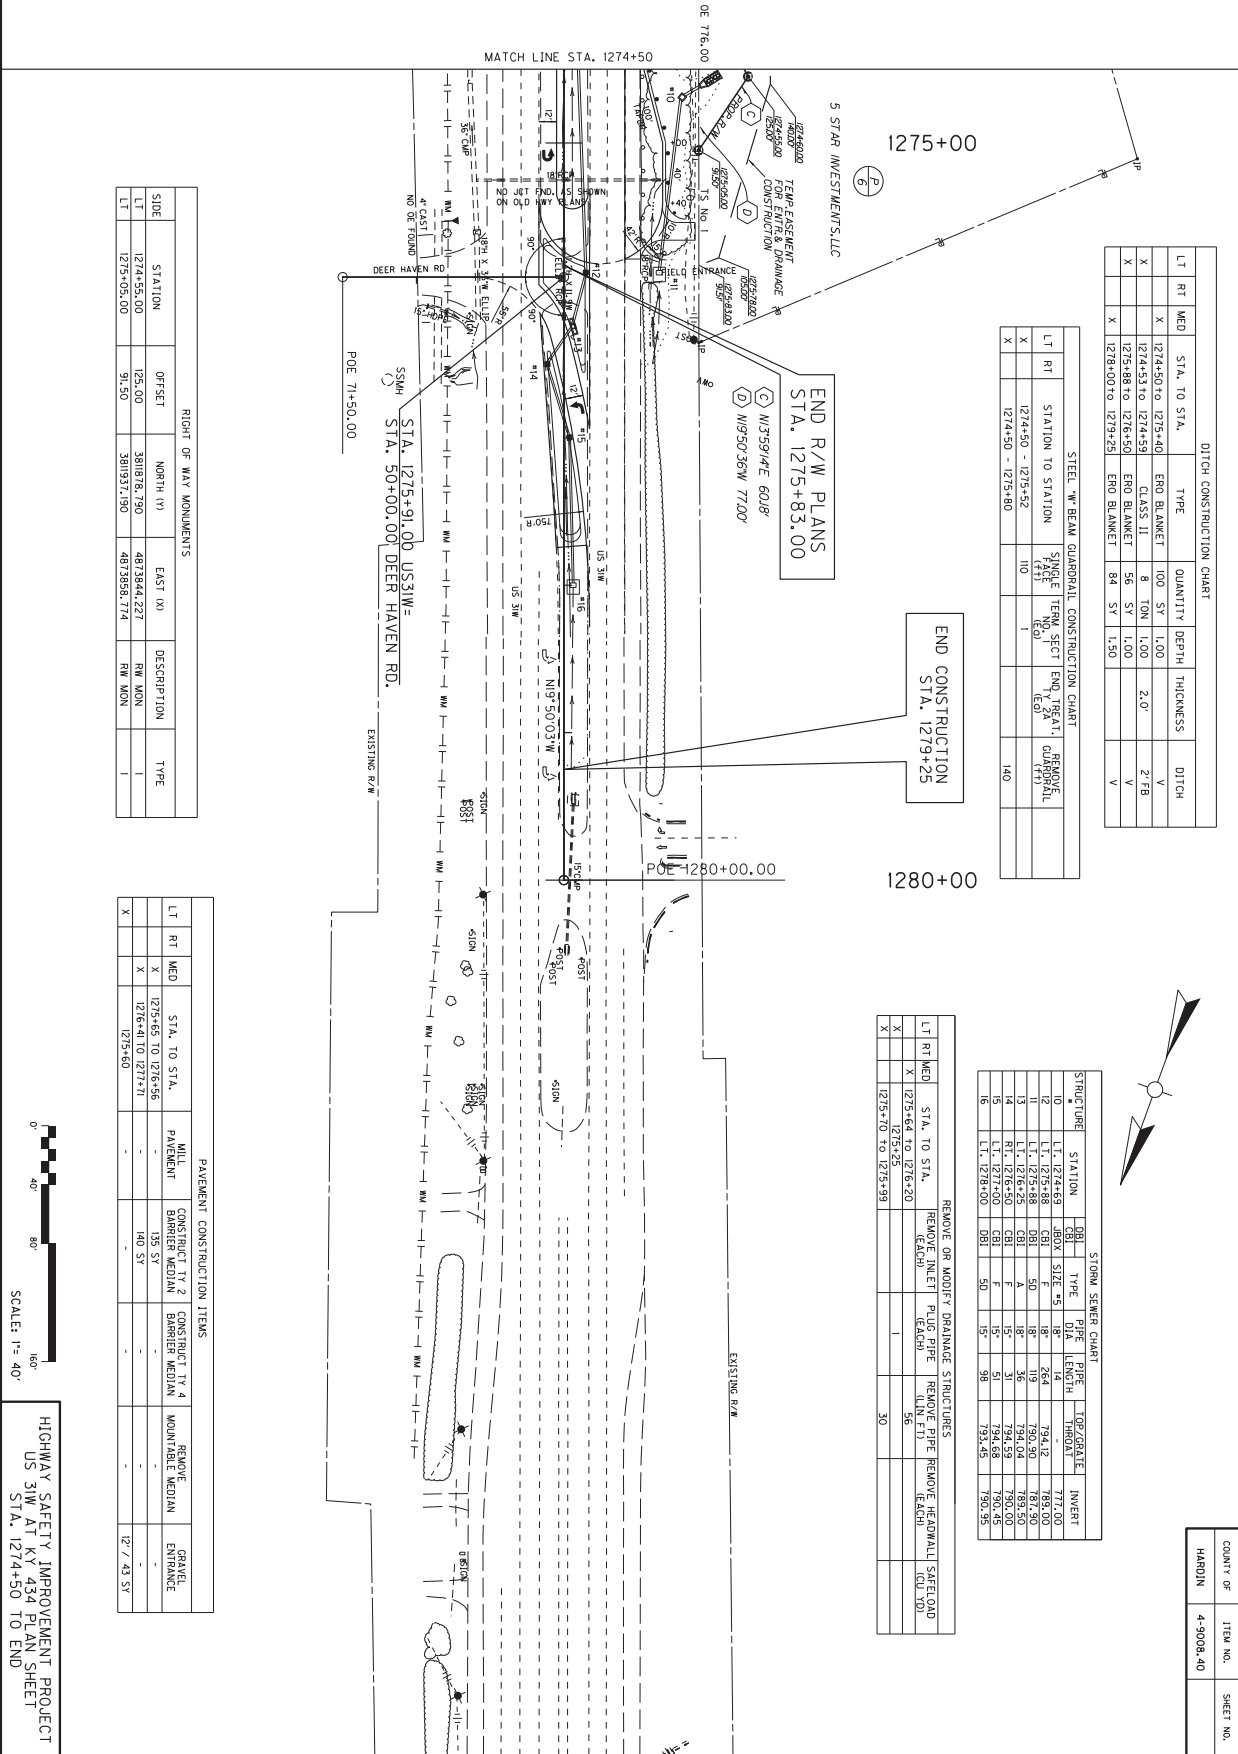

DITCH CONSTRUCTION CHART

LT	RT	STA. TO STA.	TYPE	QUANTITY	DEPTH	THICKNESS	DITCH
X		1274+50+00 - 1275+40	END BLANKET	100 SY	1.00		V
X		1274+53+00 - 1274+59	CLASS II	8 TON	1.00	2.0'	2-FB
X		1275+48+00 - 1276+50	END BLANKET	56 SY	1.00		V
X		1278+00+00 - 1279+25	END BLANKET	84 SY	1.50		V

STEEL W/ BEAM GUARDRAIL CONSTRUCTION CHART

LT	RT	STATION TO STATION	SINGLE TEMA SECT (ft)	END TREAT. (ft)	REMOVE FULL (ft)
X		1274+50 - 1275+52	110	1	140
X		1274+50 - 1279+80			

REMOVE OR MODIFY DRAINAGE STRUCTURES

LT	RT	STA. TO STA.	REMOVE INLET (ft)	REMOVE PIPE (ft)	REMOVE HEADWALL (ft)	REMOVE (ft)
X		1275+64 TO 1276+50				56
X		1275+00 TO 1275+99				30

STORM SEWER CHART


STRUCTURE	STATION	DBI	TYPE	PIPE DIA	PIPE LENGTH	TOP/GS/DATE	INVERT
10	L.T. 1274+59	18"	BOX	18"	14'	76.72	77.00
11	L.T. 1275+88	18"	BOX	18"	19'	79.00	79.50
12	L.T. 1276+25	18"	BOX	18"	31'	79.04	79.50
13	L.T. 1276+50	18"	BOX	18"	31'	79.44	79.50
14	R.T. 1276+50	18"	BOX	18"	31'	79.44	79.50
15	L.T. 1278+00	18"	BOX	18"	39'	79.46	79.50
16	L.T. 1278+00	18"	BOX	18"	39'	79.46	79.50

RIGHT OF WAY MONUMENTS

SIDE	STATION	OFFSET	NORTH (N)	EAST (E)	DESCRIPTION	TYPE
LT	1274+55.00	125.00	381878.790	481384.227	R/W MON	I
LT	1275+05.00	91.50	381931.190	481388.774	R/W MON	I

PAVEMENT CONSTRUCTION ITEMS

LT	RT	STA. TO STA.	PAVEMENT	CONSTRUCT TY 2	CONSTRUCT TY 4	REMOVE MOUNTABLE MEDIAN	REMOVE GRANU ENTRANCE
X		1275+65 TO 1276+56		135 SY			
X		1276+41 TO 1277+71		140 SY			
X		1275+60					12' 7.43 SY

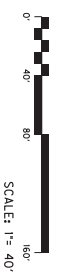

HIGHWAY SAFETY IMPROVEMENT PROJECT
US 31W AT KY 434 PLAN SHEET
STA. 1274+50 TO END

COUNTY OF	ITEM NO.	SHEET NO.
HARDIN	4-9008.40	

Power InRoads v8.11.9.397 E-SHEET NAME: USER: travis-m DATE PLOTTED: August 3, 2018 FILE NAME: C:\PW_WORKING\DM564846\RW SUM KY 434.DGN

RIGHT OF WAY SUMMARY

COUNTY OF	ITEM NO.	SHEET NO.
HARDIN	4-9008.40	

PARCEL NO.	OWNERS	TOTAL AREA OF TRACT		PERMANENT R/W ACQUIRED		EASEMENTS		LEFT AREA SEVERED		RIGHT AREA SEVERED		EXCESS PURCHASED		PORTION REMAINING		SEWER SYSTEM TYPE	SEWER SYSTEM BY PROJECT	BUILDINGS ACQUIRED				SOURCE OF TITLE	REMARKS*													
		ACRES	SO. FT.	ACRES	SO. FT.	ACRES	SO. FT.	ACRES	SO. FT.	ACRES	SO. FT.	ACRES	SO. FT.	ACRES	SO. FT.			ACRES	SO. FT.	YES	NO			C	R	F	S									
1	5 STAR INVESTMENTS, LLC	3.805		0.033	1,457			3,787						3,772		5		X																	DB 1445 PG 281	

BASIS FOR DETERMINATION OF AREA:
 (A) DEED
 (B) P.V.A.
 (C) CALCULATED
 (D) OTHER


NOTE: PERMANENT R/W ACQUIRED + AREA SEVERED = TOTAL AREA OF TRACT.

TYPE SEWER SYSTEM:
 1. PRIVATE - INDIVIDUAL
 2. PRIVATE - MULTIPARTY
 3. PUBLIC
 4. OTHER
 5. NOT APPLICABLE

BUILDINGS ACQUIRED CODE:
 R - RESIDENTIAL
 F - FROM
 S - STORAGE

US 31W AT KY 434
 RIGHT OF WAY SUMMARY SHEET

Power InRoads v8.11.9.397 E-SHEET NAME: USER: jeff-c DATE PLOTTED: August 6, 2018 FILE NAME: D:\PW_WORKDIR\DM564834\KY434 BARRIER DETAIL 1.DGN

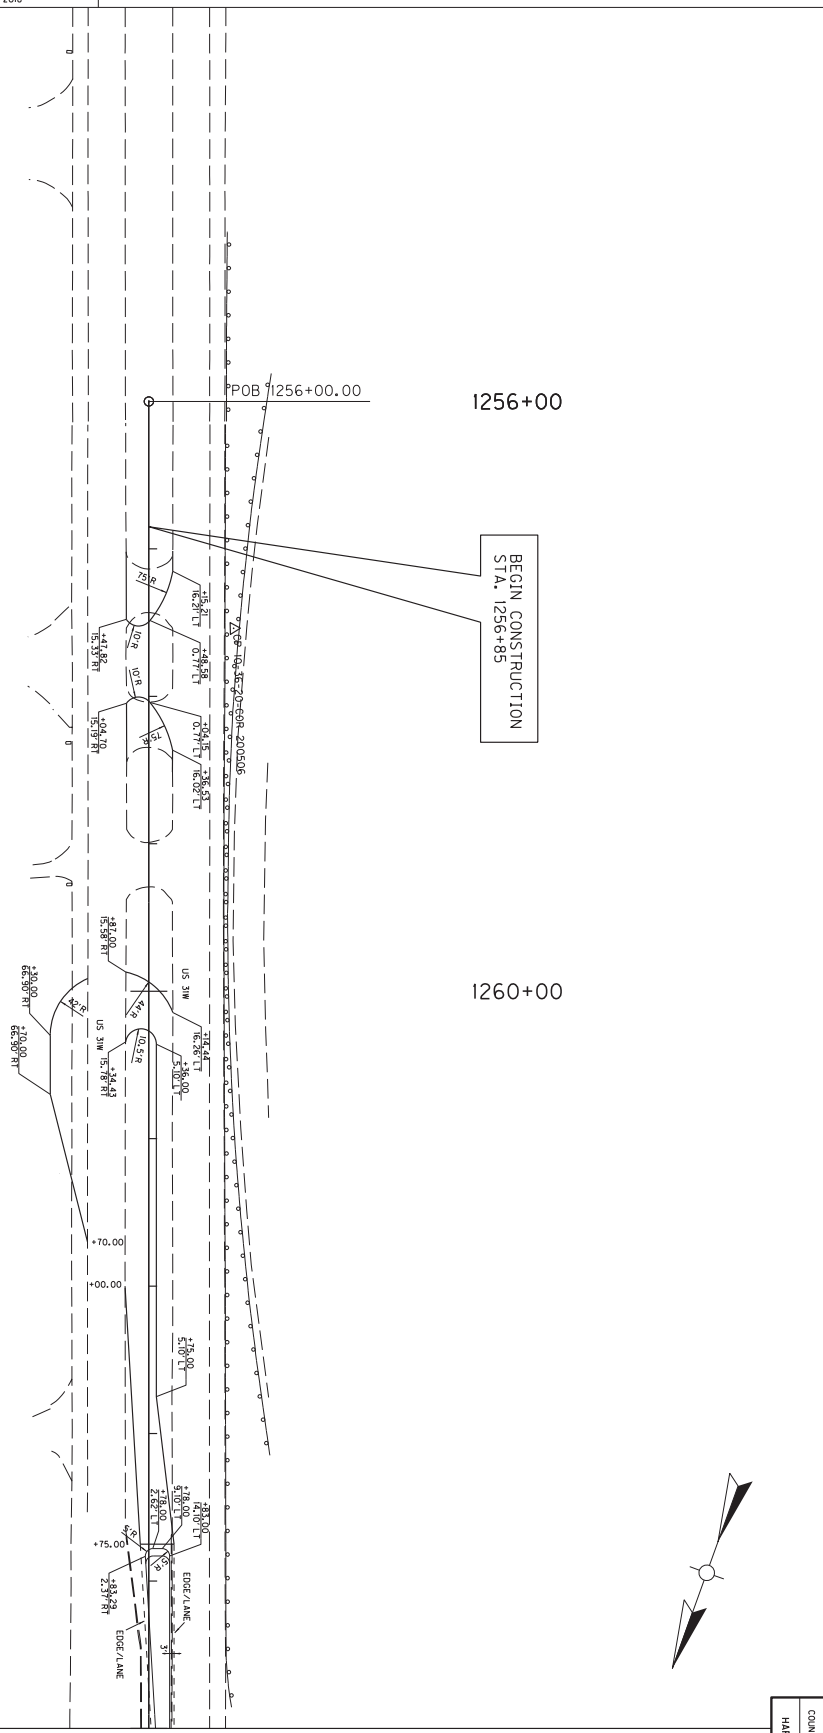

MAINLINE ALIGNMENT POINTS			
POINT	DESCRIPTION	STATE PLANE COORDINATES	
		NORTH (N)	EAST (E)
POB	1256+00.00	3818159.5270	4872151.2124
POE	1256+00.00	3812425.5721	4872726.9725
KY 434 WEST			
POB	48+00.00	3811003.5165	4874047.7598
POE	50+00.00	381163.0156	4872235.2827
KY 434 EAST			
POB	50+00.00	3811159.5690	4872151.6000
POE	52+75.00	3811165.5344	4872817.4091
DEER HAVEN			
POB	70+00.00	3812100.1146	4871915.6669
POE	71+50.00	3812100.0295	4874056.7687

CONTROL POINTS						
POINT	DESCRIPTION	STATE PLANE COORD.			STATION	OFFSET
		NORTH (N)	EAST (E)	ELEV. (Z)		
10-38-19	ALUMINUM DISK	3809347.1900	4872823.6100	836.61	1257+53.95	37.21 L.T
10-38-20	BRASS DISK	3810301.6500	4872485.1600	828.19	1257+53.95	37.21 L.T
10-38-21	ALUMINUM DISK	3811434.8900	4872321.7200	798.52	1259+05.95	88.90 R.T
10-38-22	BRASS DISK	3811975.4100	4872446.5300	808.03		L.T




SCALE: 1"= 40'

HSIP US 31W AT KY 434
BARRIER DETAIL & CONTROL PLAN SHEET
BEGIN TO STA. 1265+00

COUNTY OF	ITEM NO.	SHEET NO.
HARDIN	4-9008.40	

Power InRoads v8.11.9.397 E-SHEET NAME: USER: trvols-m DATE PLOTTED: August 6, 2018 FILE NAME: D:\PW\WORKDIR\DM564834\KY434 BARRIER DETAIL 2.DGN

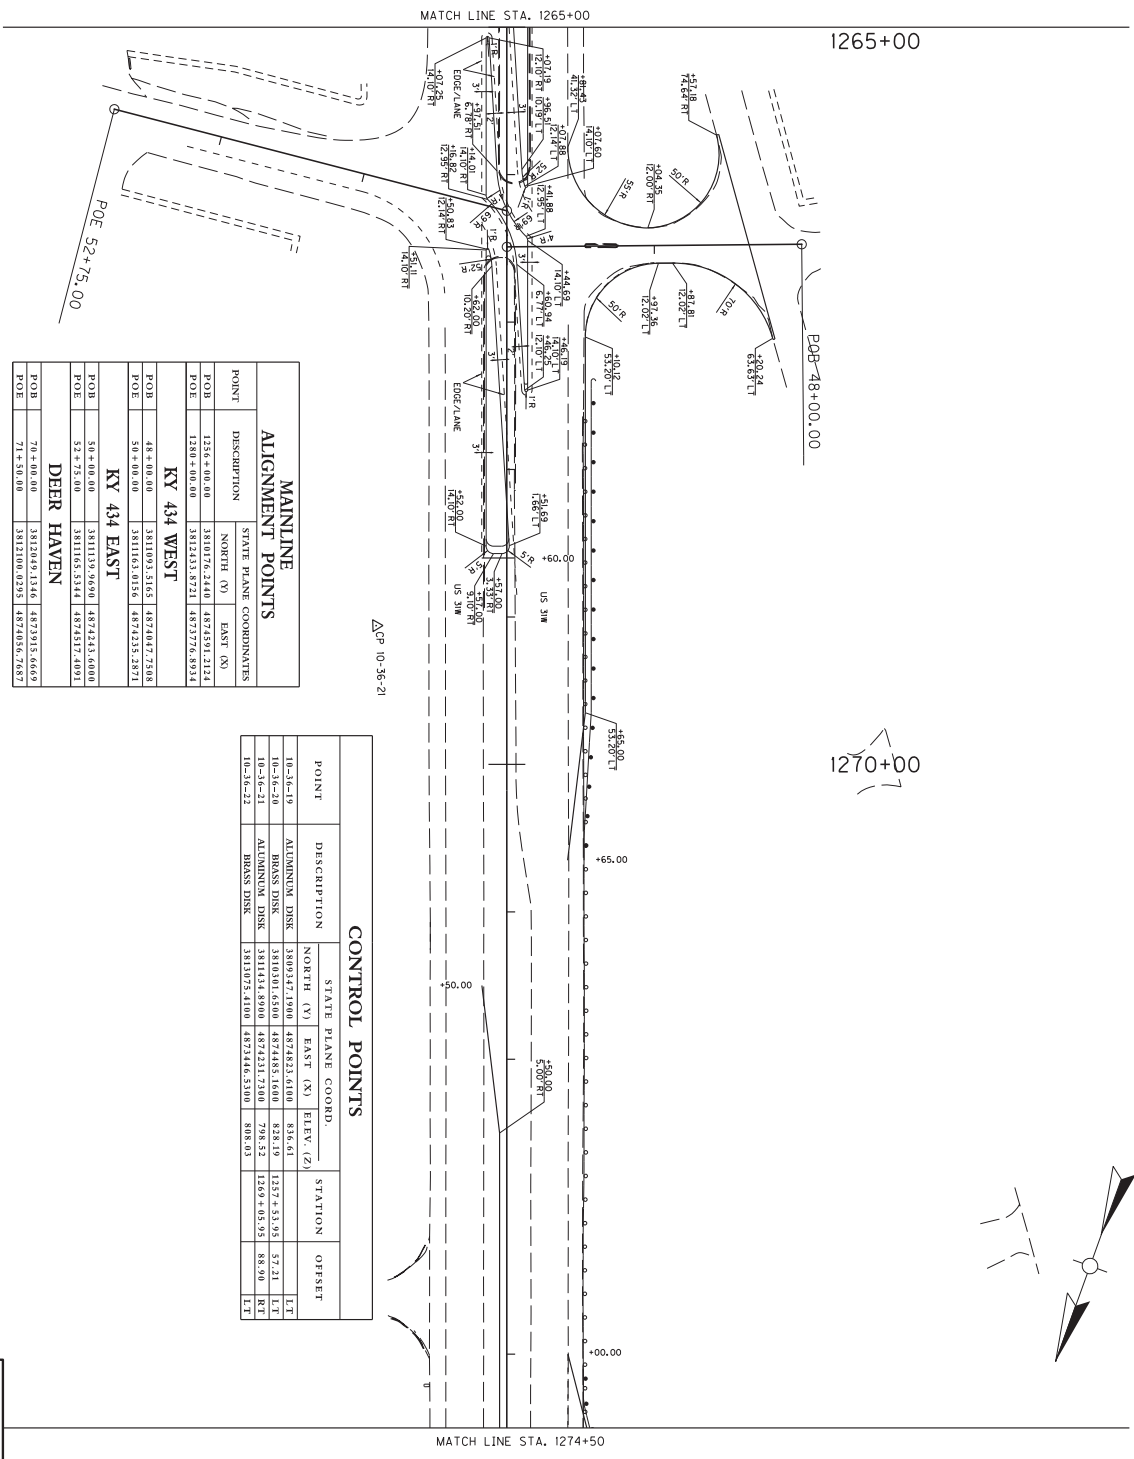

MAINLINE ALIGNMENT POINTS			
POINT	DESCRIPTION	STATE PLANE COORDINATES	POINT
		NORTH (Y)	EAST (X)
POB	1265+00.00	3810176.2446	4874291.2124
POE	1280+00.00	3812433.8721	4873776.8934
KY 434 WEST			
POB	48+000.00	3811093.5165	4874047.7508
POE	50+000.00	3811163.0156	4874235.2871
KY 434 EAST			
POB	50+000.00	3811170.9420	4874231.6600
POE	52+75.00	3811150.5344	4874217.4893
DEER HAVEN			
POB	70+000.00	3812004.1346	4873915.6669
POE	71+50.00	3812100.0285	4874056.7687


CONTROL POINTS						
POINT	DESCRIPTION	STATE PLANE COORD.			STATION	OFFSET
		NORTH (Y)	EAST (X)	ELEV. (Z)		
10-18-19	ALUMINUM DISK	3809347.1900	4874833.6100	836.61	1257+53.95	57.21 L.T.
10-18-20	BRASS DISK	3810301.6500	4874483.1600	838.19	1257+53.95	57.21 L.T.
10-18-21	ALUMINUM DISK	3811034.8900	4874231.7300	798.52	1269+05.95	88.90 R.T.
10-18-22	BRASS DISK	3811075.4100	4873446.5300	808.03		L.T.



COUNTY OF	ITEM NO.	SHEET NO.
HARDIN	4-9008.40	


HSIP US 31W AT KY 434
BARRIER DETAIL & CONTROL PLAN SHEET
STA. 1265+00 TO STA. 1274+50

Power InRoads v8.11.9.397 E-SHEET NAME: USER: jeff-c DATE PLOTTED: August 6, 2018 FILE NAME: D:\PW_WORKDIR\DM564834\KY434 BARRIER DETAIL 3.DGN

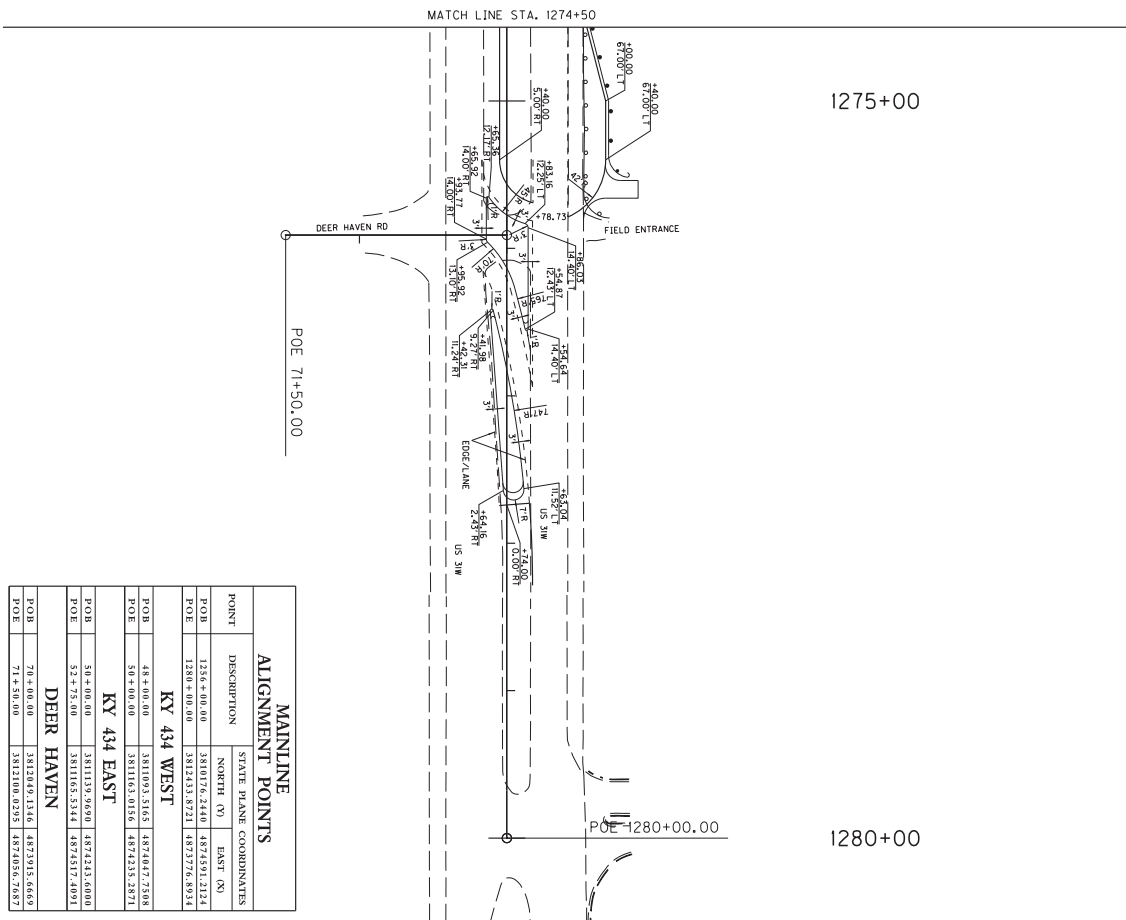

MAINLINE ALIGNMENT POINTS			
POINT	DESCRIPTION	STATE PLANE COORDINATES	
		NORTH (N)	EAST (E)
POB	1280+00.00	381176.5110	487424.1214
POE	1280+00.00	381243.9722	487372.8793
KY 434 WEST			
POB	48+00.00	381109.5165	487444.77508
POE	50+00.00	381116.30156	487425.28971
KY 434 EAST			
POB	50+00.00	381119.9690	487443.6000
POE	52+75.00	381116.5314	487431.74091
DEER HAVEN			
POB	71+50.00	381210.0295	487465.7687

CONTROL POINTS						
POINT	DESCRIPTION	STATE PLANE COORD.			STATION	OFFSET
		NORTH (N)	EAST (E)	ELEV. (Z)		
10-26-19	ALUMINUM DISK	380937.1900	487483.6100	816.01	1277+53.55	57.21 LT
10-26-20	BRASS DISK	381011.6500	487483.1600	728.19	1277+53.55	57.21 RT
10-26-21	ALUMINUM DISK	381011.6500	487483.1600	728.19	1277+53.55	57.21 RT
10-26-22	BRASS DISK	381107.4100	487444.5300	808.43		

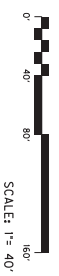


COUNTY OF	ITEM NO.	SHEET NO.
HARDIN	4-9008.40	


HSIP US 31W AT KY 434
BARRIER DETAIL & CONTROL PLAN SHEET
STA. 1274+50 TO END

Power InRoads v8.11.9.397 E-SHEET NAME: USER: jeff-c DATE PLOTTED: August 6, 2018 FILE NAME: D:\PW\WORKDIR\DM564834\KY434 STRIPING DETAIL 1.DGN

STRIPING QUANTITIES			
ITEM	DESCRIPTION	UNIT	US 31W
Z0995EC	PAVE STRIPING-SPRAY THERMO-6 IN W	LF	761
Z0995EL	PAVE STRIPING-SPRAY THERMO-6 IN W	LF	1034
6598	PAVEMENT MARKING-ROADWAY - 4 INCH	SO FT	16.5
6574	PAVE MARKING - THERMO CURB ARROW	EACH	5
24679ED	PAVE MARK - THERMO CURB ARROW	SO FT	-
65659	PAVE MARKING - THERMO CROSS-HATCH	SO FT	-

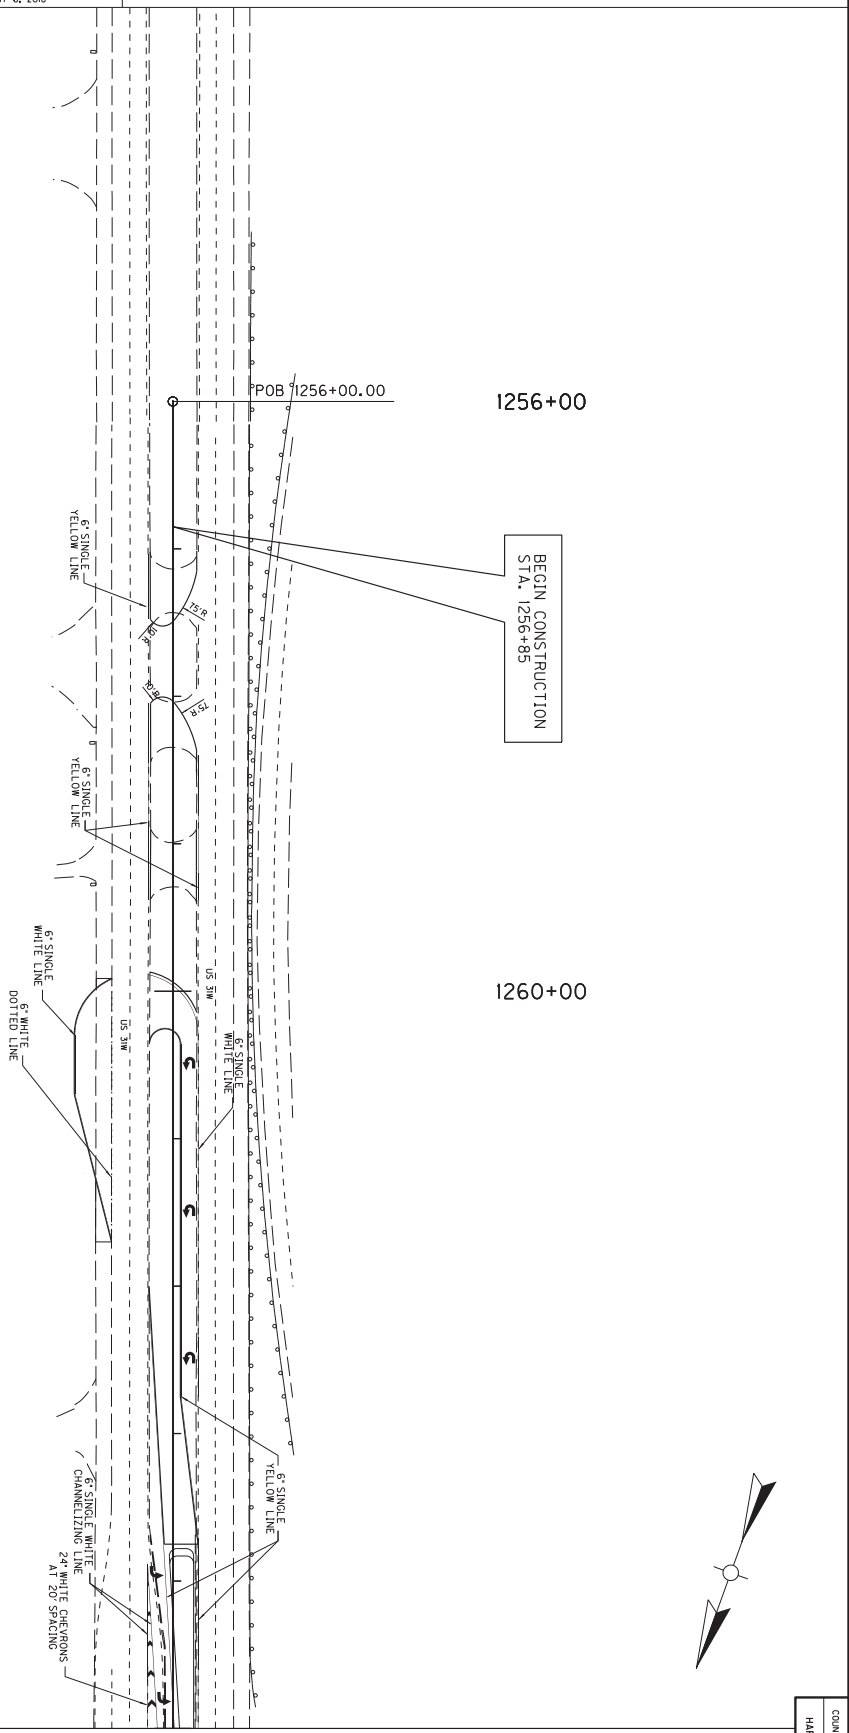


SCALE: 1" = 40'

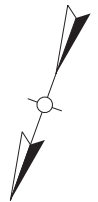

HSIP US 31W AT KY 434
STRIPING DETAIL PLAN SHEET
BEGIN TO STA. 1265+00

COUNTY OF HARDIN	ITEM NO. 4-9008.40	SHEET NO.
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Power InRoads v8.11.9.397 E-SHEET NAME: USER: travis-m DATE PLOTTED: August 6, 2018 FILE NAME: D:\PW\WORKDIR\DM564834\KY434 STRIPING DETAIL 2.DGN

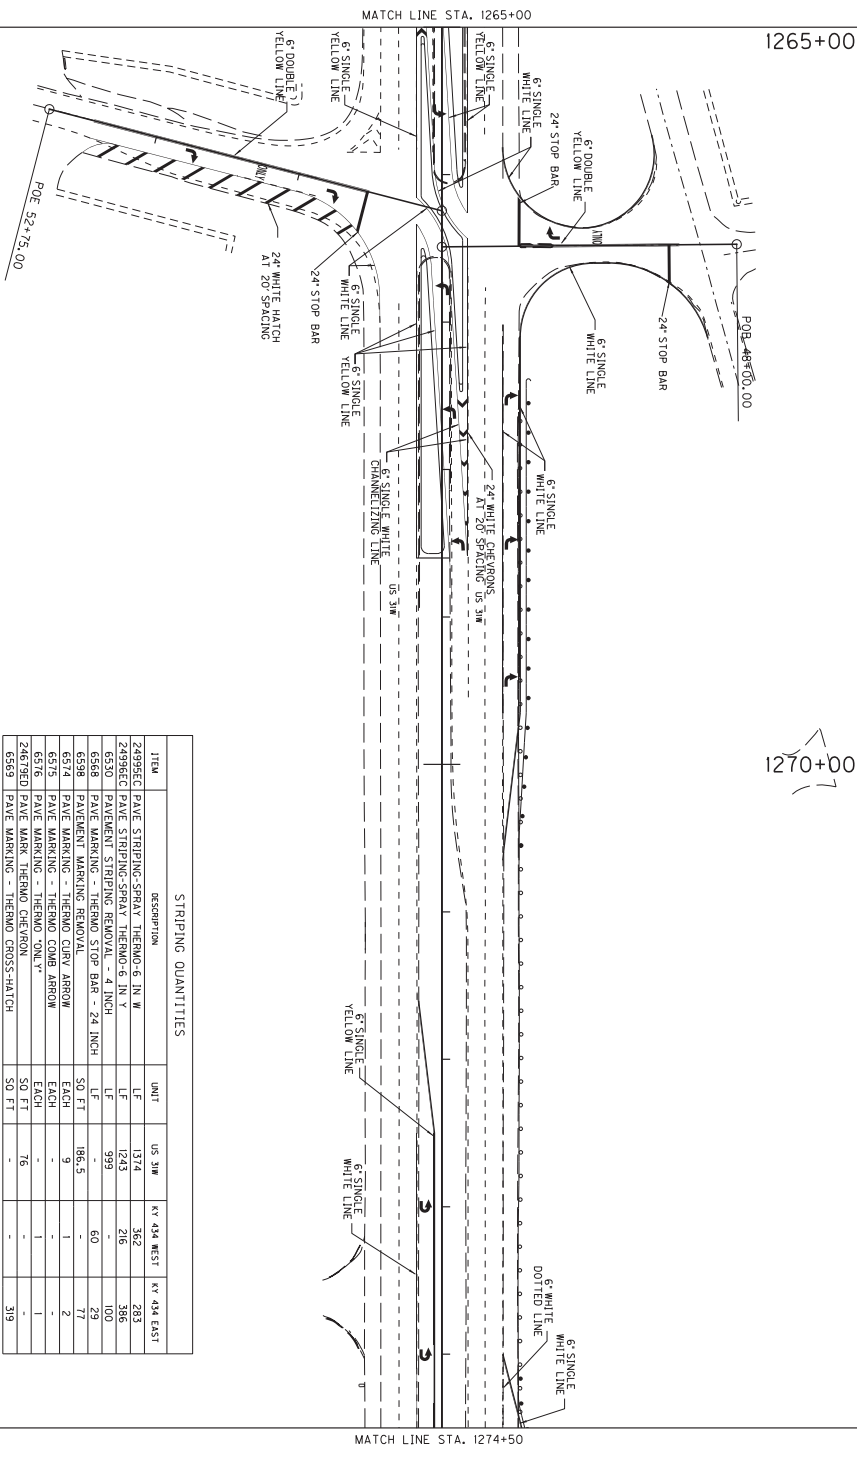

STRIPING QUANTITIES


ITEM	DESCRIPTION	UNIT	US 31W	KY 434 WEST	KY 434 EAST
2299EC	PAVE STRIPING-STRAY THERMO 6 IN W	LF	1374	362	263
2299ED	PAVE STRIPING-STRAY THERMO 4 INCH	LF	149	216	100
6530	PAVE STRIPING REMOVAL	LF	999	60	29
6598	PAVE MARKING - THERMO STOP BAR - 24 INCH	SO FT	186.5	-	77
6574	PAVE MARKING - THERMO CURB ARROW	EACH	9	1	2
6575	PAVE MARKING - THERMO COMB ARROW	EACH	-	1	-
6576	PAVE MARKING - THERMO CONE V	SO FT	76	-	1
24679ED	PAVE MARKING - THERMO CROSS-HATCH	SO FT	-	-	319



COUNTY OF	ITEM NO.	SHEET NO.
HARDIN	4-9008.40	

HSIP US 31W AT KY 434
STRIPING DETAIL PLAN SHEET
STA. 1265+00 TO STA. 1274+50

Power InRoads v8.11.9.397 E-SHEET NAME: USER: jeff-c DATE PLOTTED: August 6, 2018 FILE NAME: D:\PW_WORKDIR\DM564834\KY434 STRIPING DETAIL 3.DGN

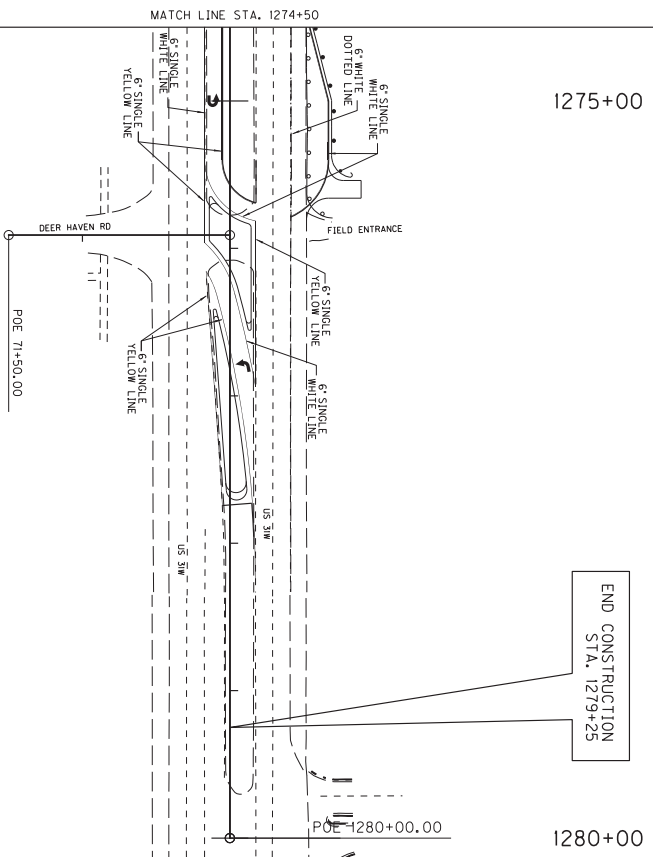



1275+00

1280+00

END CONSTRUCTION
STA. 1279+25


STRIPING QUANTITIES

ITEM	Description	UNIT	US 31W
Z499SECT	PAVE STRIPING-SPRAY THERMO-6 IN W	LF	439
Z499SECT	PAVE STRIPING-SPRAY THERMO-6 IN Y	LF	676
6530	PAVEMENT STRIPING REMOVAL - 4 INCH	LF	-
6598	PAVEMENT MARKING REMOVAL	SO FT	-
6574	PAVE MARKING - THERMO CURB ARROW	EACH	2
6576	PAVE MARKING - THERMO COMB ARROW	EACH	-
Z673END	PAVE MARK THERMO DEER HAVEN	SO FT	-
6989	PAVE MARKING - THERMO CROSS-MATCH	SO FT	-

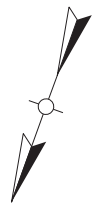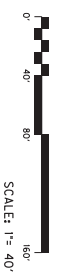

COUNTY OF	ITEM NO.	SHEET NO.
HARDIN	4-9008.40	

HSIP US 31W AT KY 434
STRIPING DETAIL PLAN SHEET
STA. 1274+50 TO END

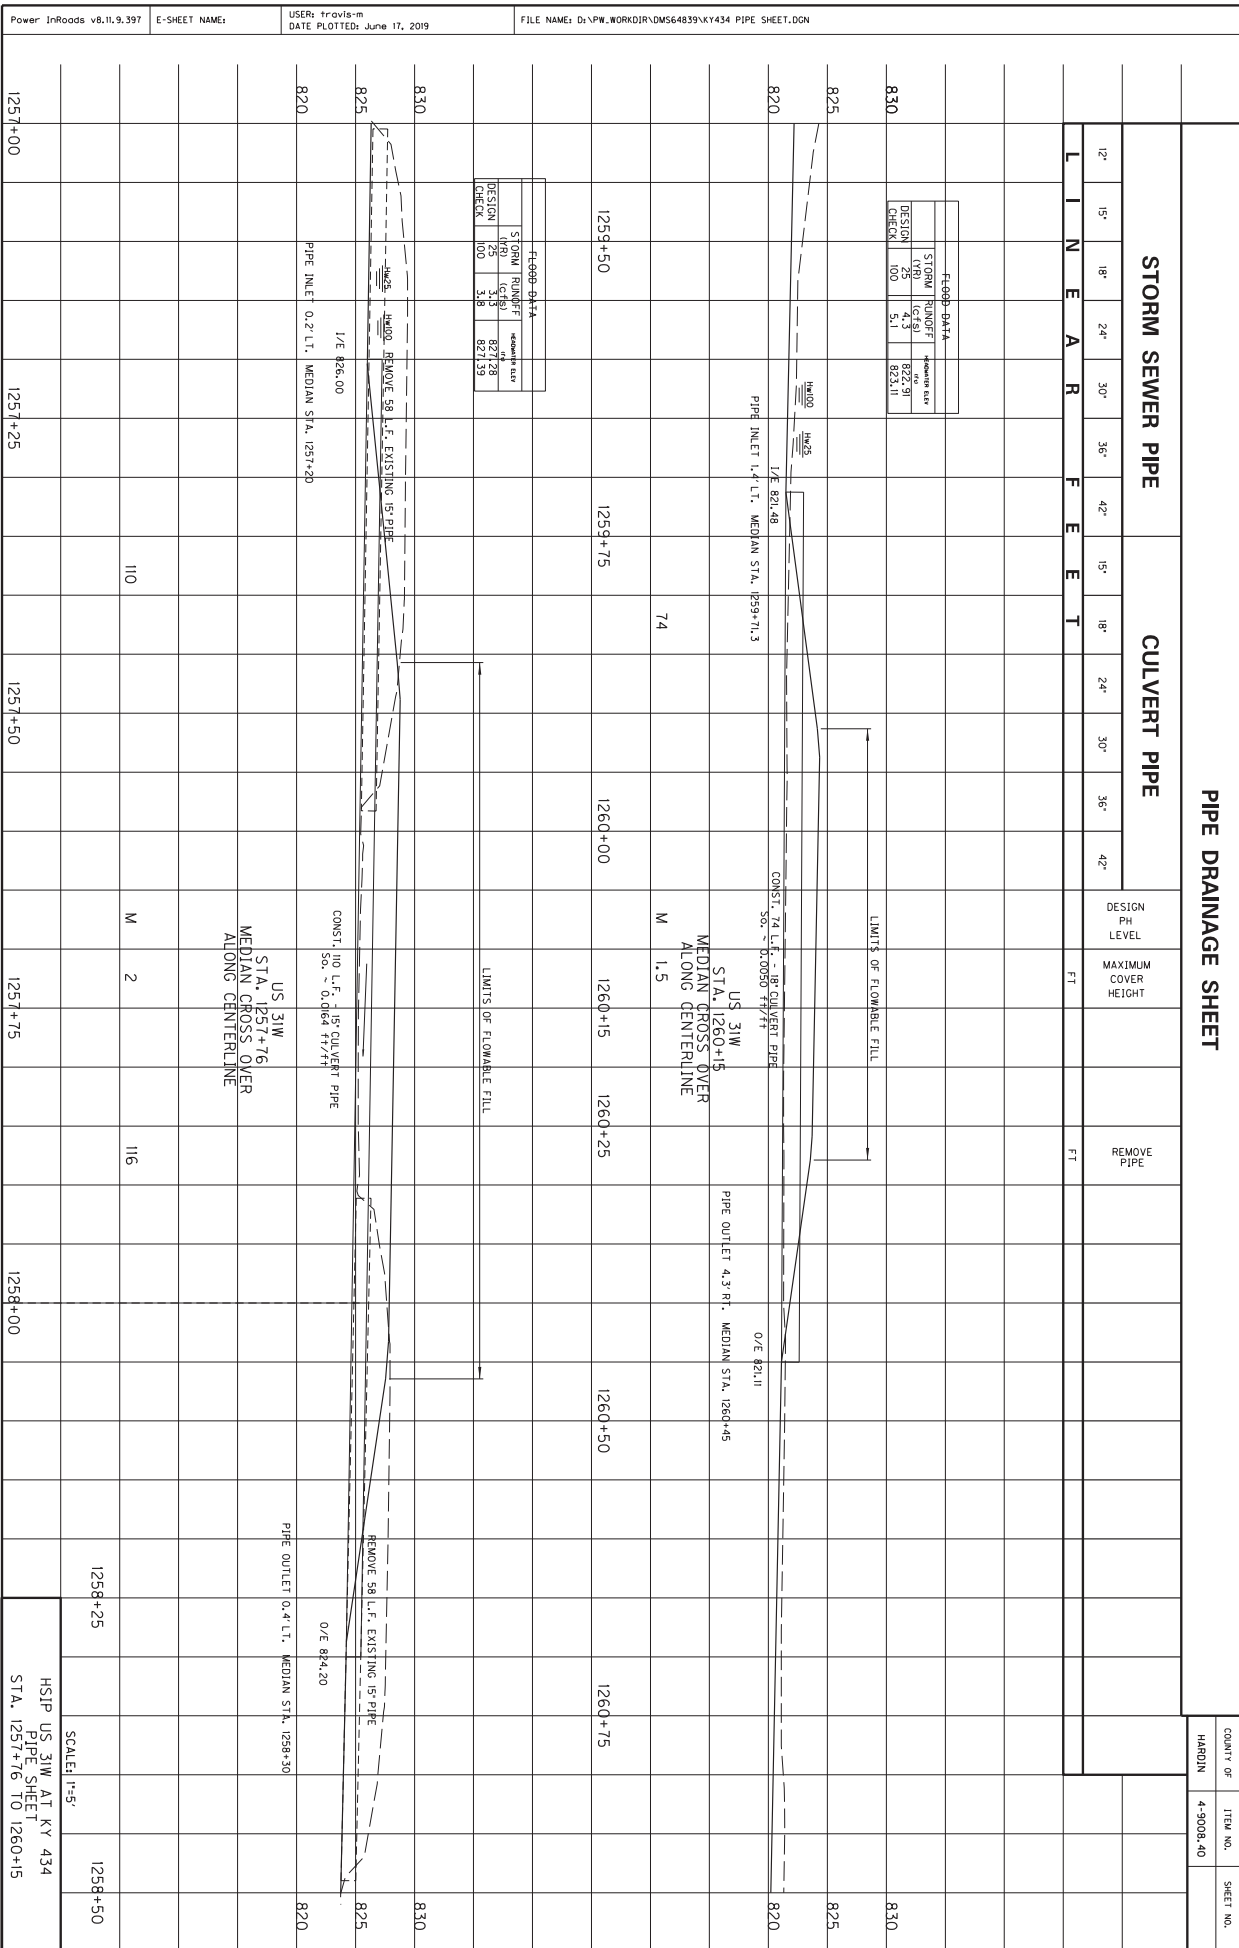

COUNT OF	ITEM NO.	SHEET NO.
HARDIN	4-3008-40	

STORM SEWER PIPE

CULVERT PIPE

PIPE DRAINAGE SHEET

LINE	12'	15'	18'	24'	30'	36'	42'	15'	18'	24'	30'	36'	42'
DESIGN PH LEVEL													
MAXIMUM COVER HEIGHT													
REMOVE PIPE													

FLEET DATA

STORM RUNOFF	DESIGN PH LEVEL
DESIGN 100	5.1
CHECK 100	5.1

FLEET DATA

STORM RUNOFF	DESIGN PH LEVEL
DESIGN 100	5.1
CHECK 100	5.1

1257+00 1257+25 1257+50 1257+75 1258+00 1258+25 1258+50

HSIP US 31W AT KY 434
PIPE SHEET
STA. 1257+76 TO 1260+15

1257+00

1257+25

1257+50

1257+75

1258+00

1258+25

1258+50

1257+00

1257+25

1257+50

1257+75

1258+00

1258+25

1258+50

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1257+75

1258+00

1258+25

1258+50

1257+00

1257+25


1257+50


1257+75


1258+00

1258+25

1258+50

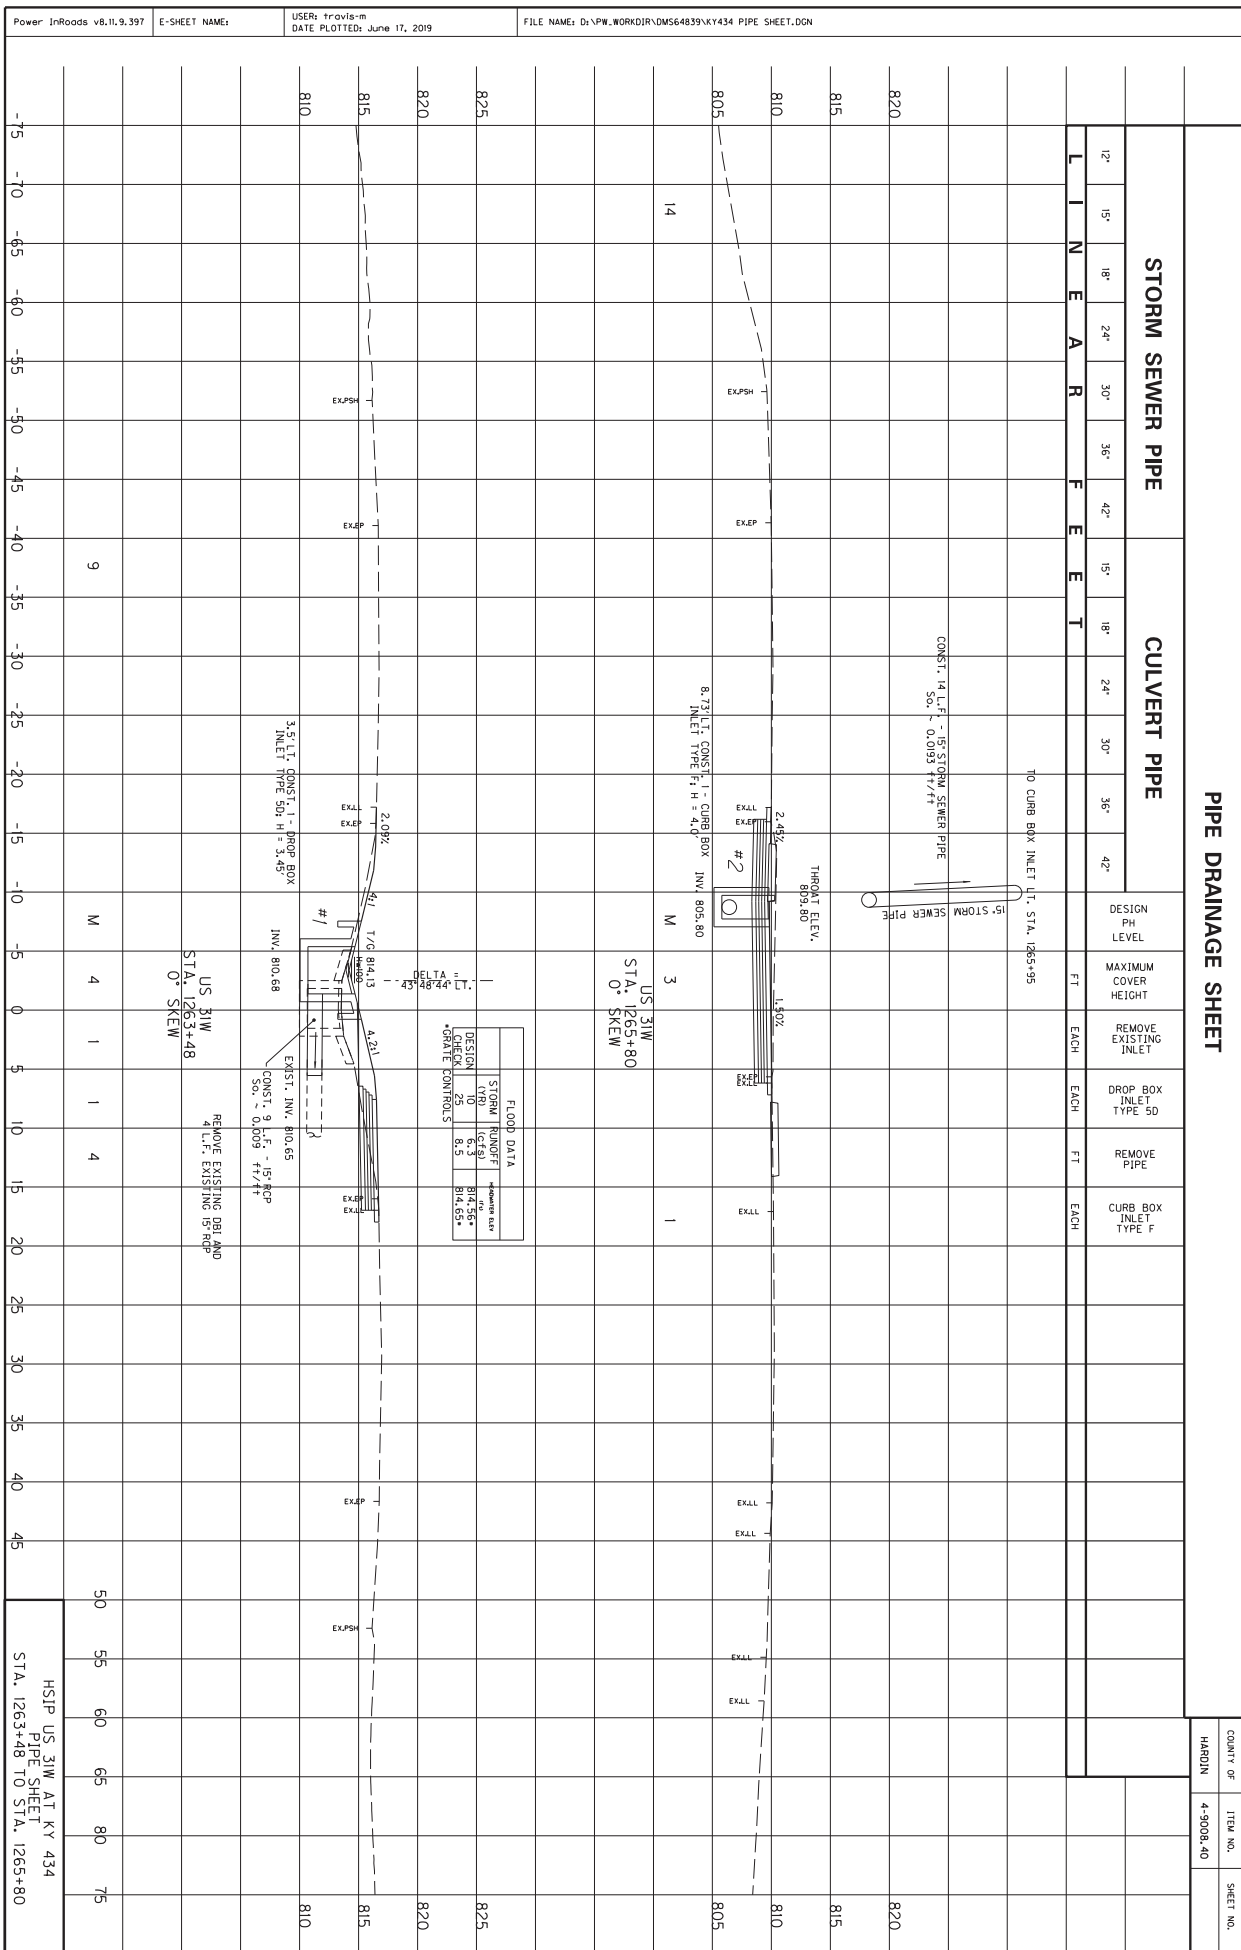

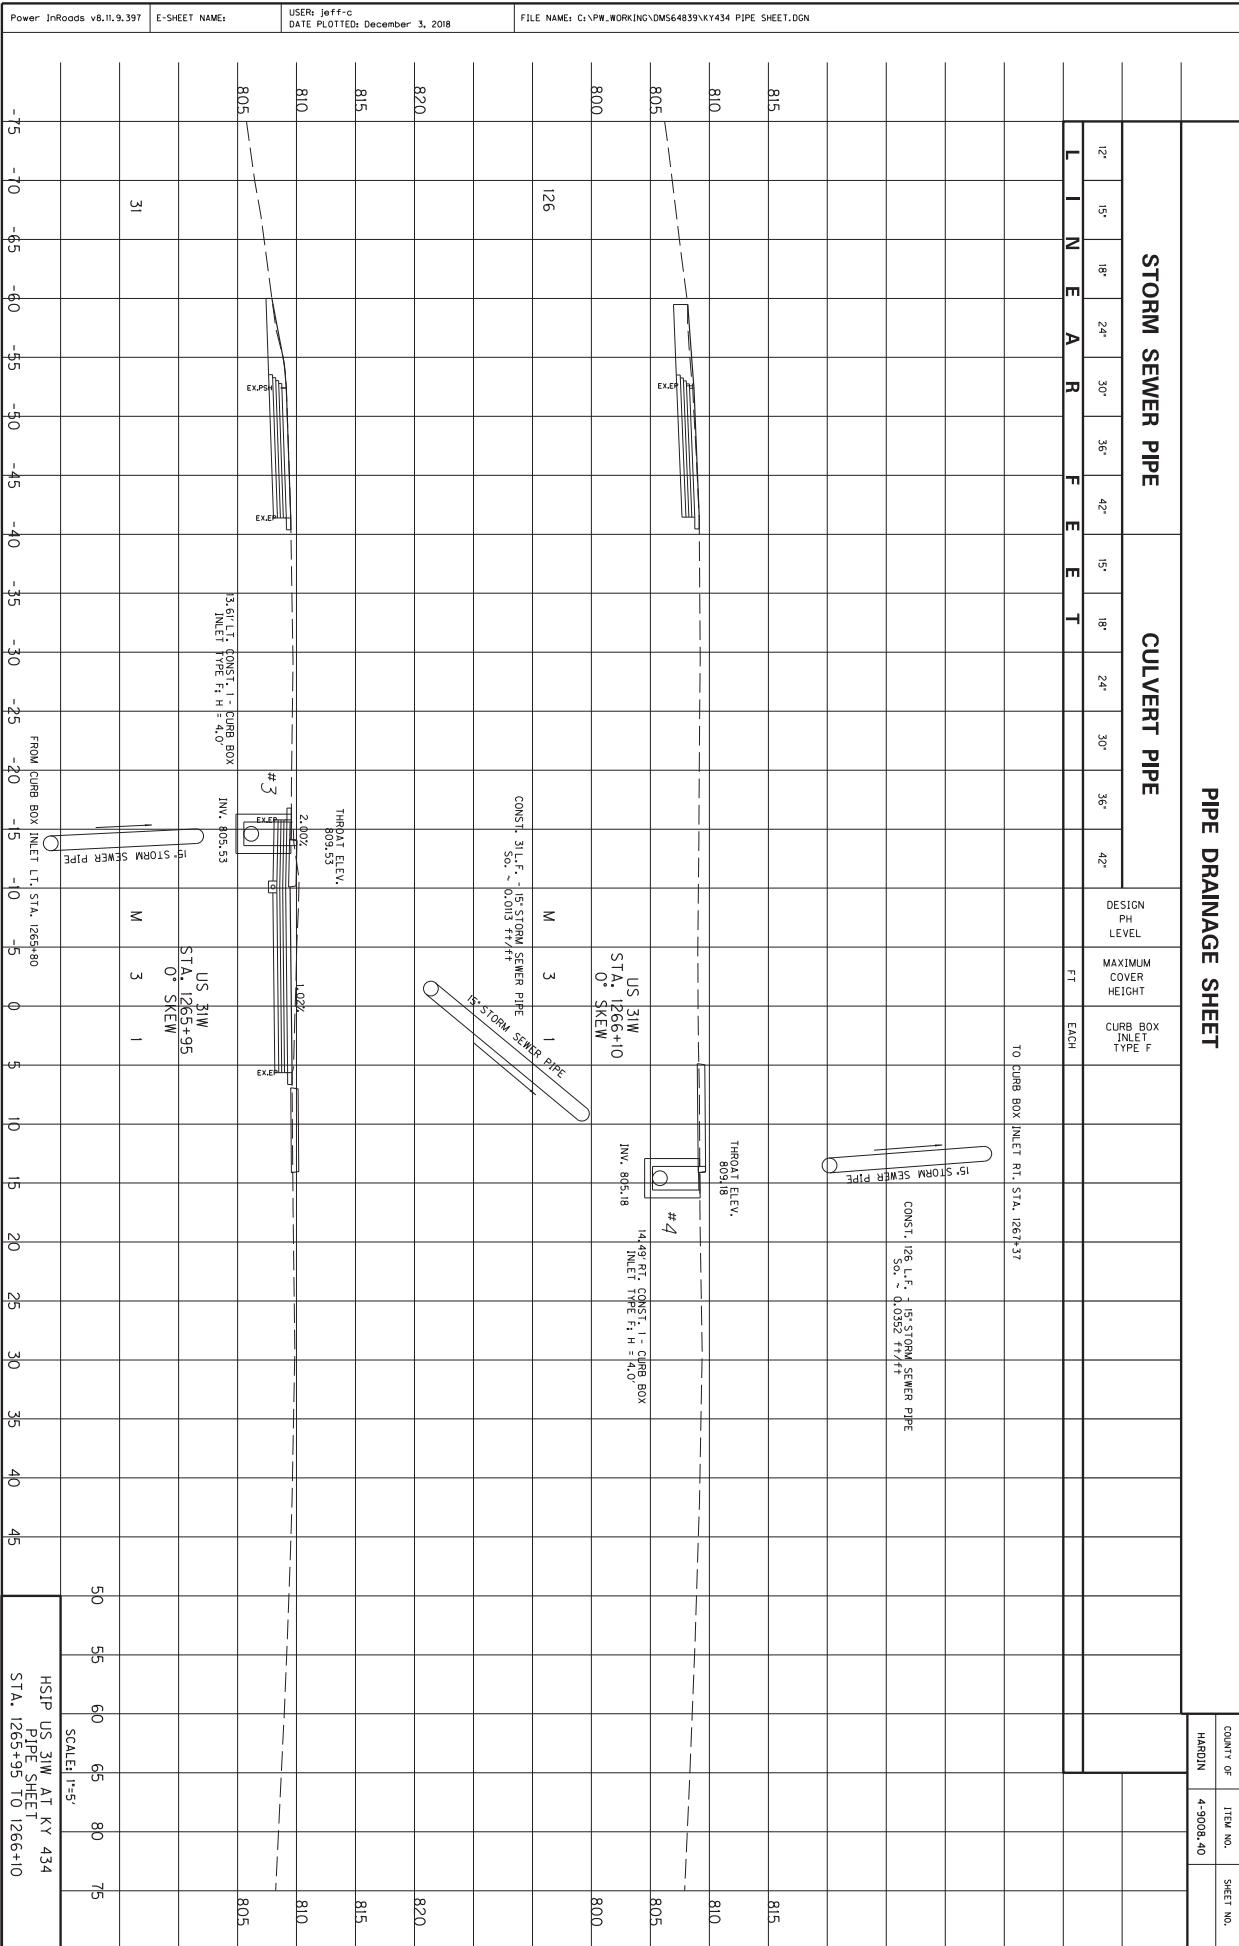

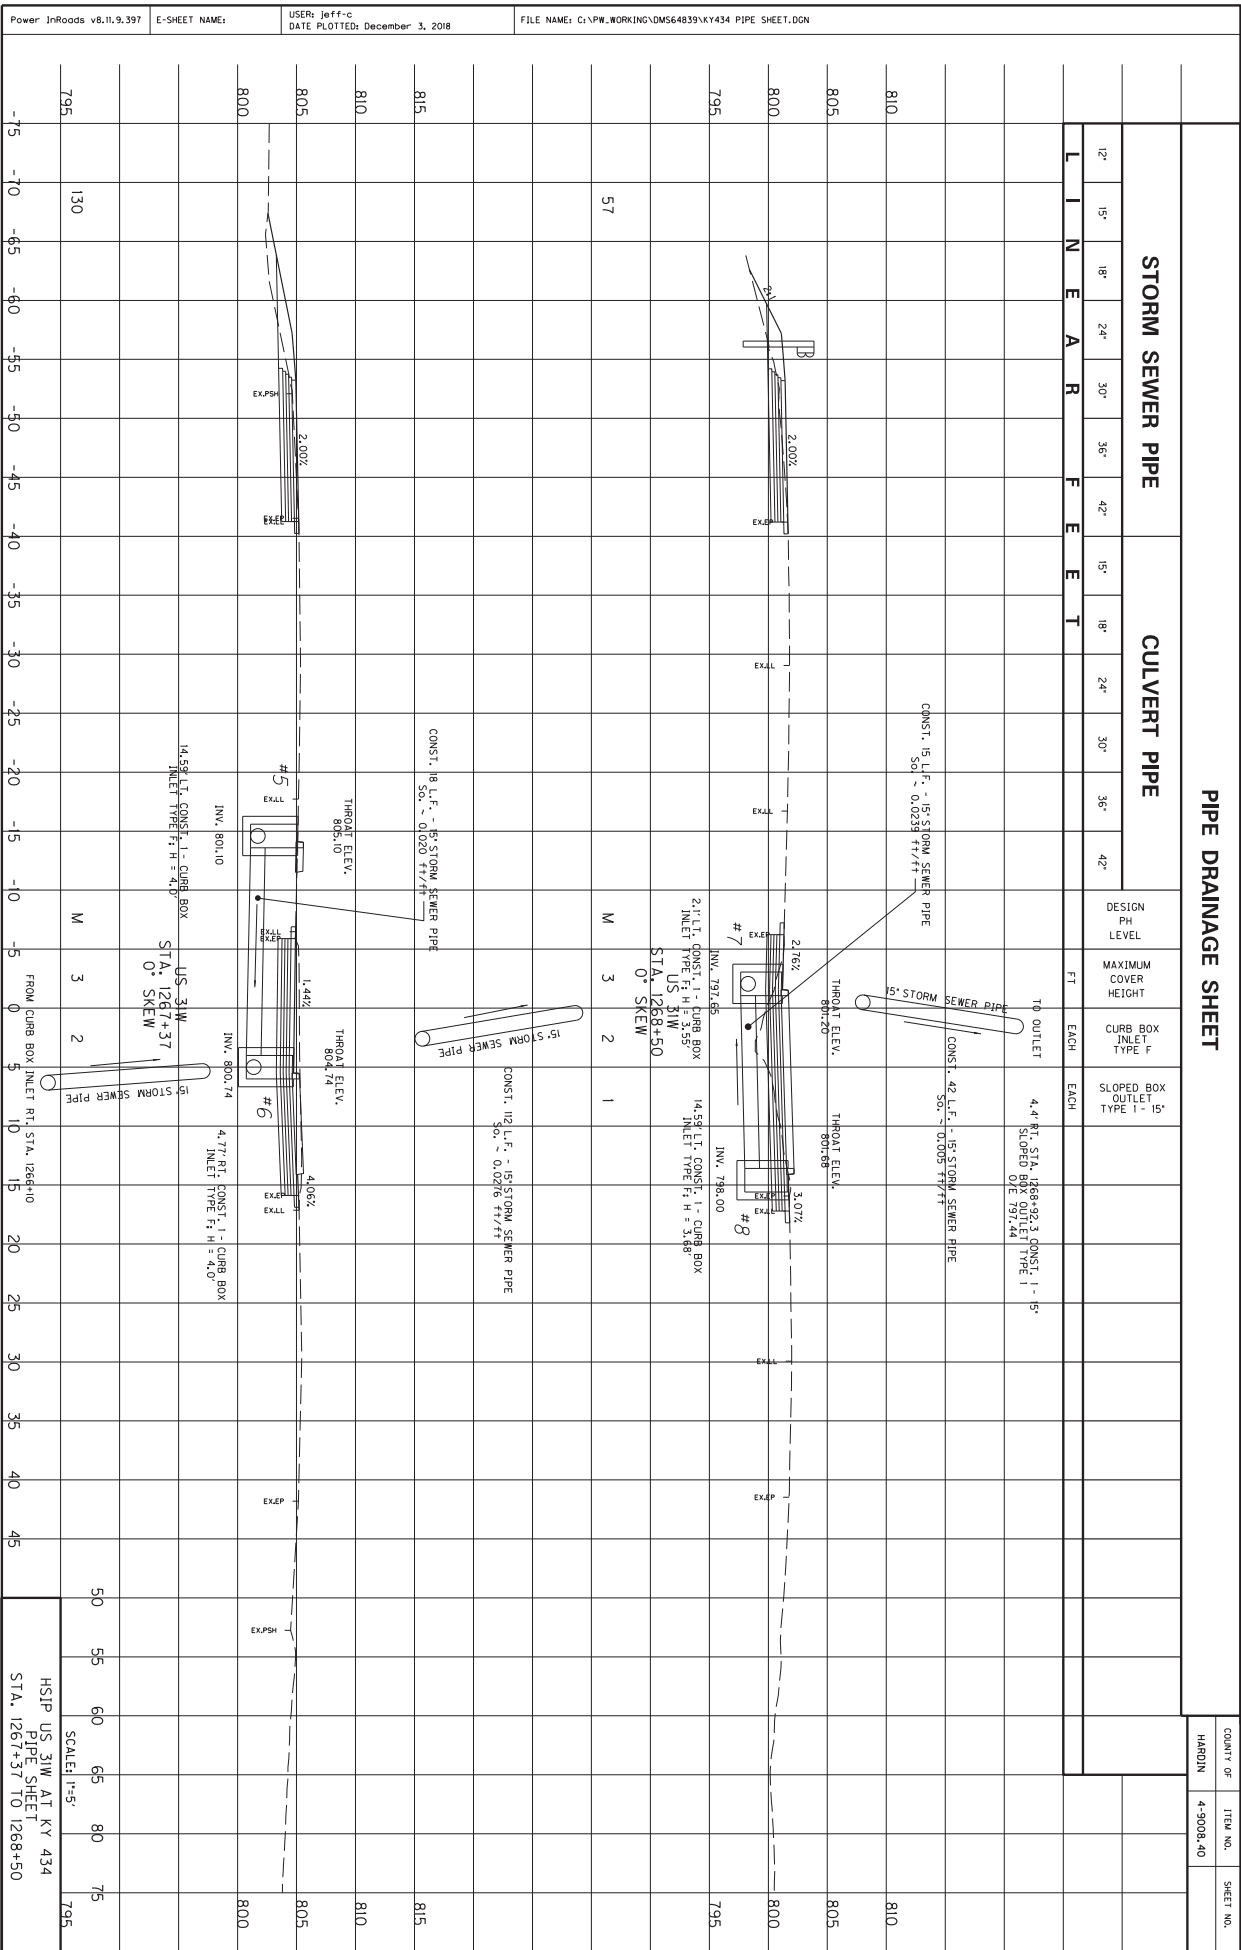

PIPE DRAINAGE SHEET


STORM SEWER PIPE		CULVERT PIPE	
12"	15"	18"	24"
15"	18"	24"	30"
18"	24"	30"	36"
24"	30"	36"	42"
30"	36"	42"	

DESIGN PH LEVEL	MAXIMUM COVER HEIGHT	CURB BOX INLET TYPE	SLOPED BOX OUTLET TYPE
FT	EACH	1 - 15"	1 - 15"

COUNT OF	ITEM NO.	SHEET NO.
HARDIN	4-3008-40	

HSIP US 31W AT KY 434
PIPE SHEET
SCALE 1"=5'

STA. 1267+37 TO 1268+50

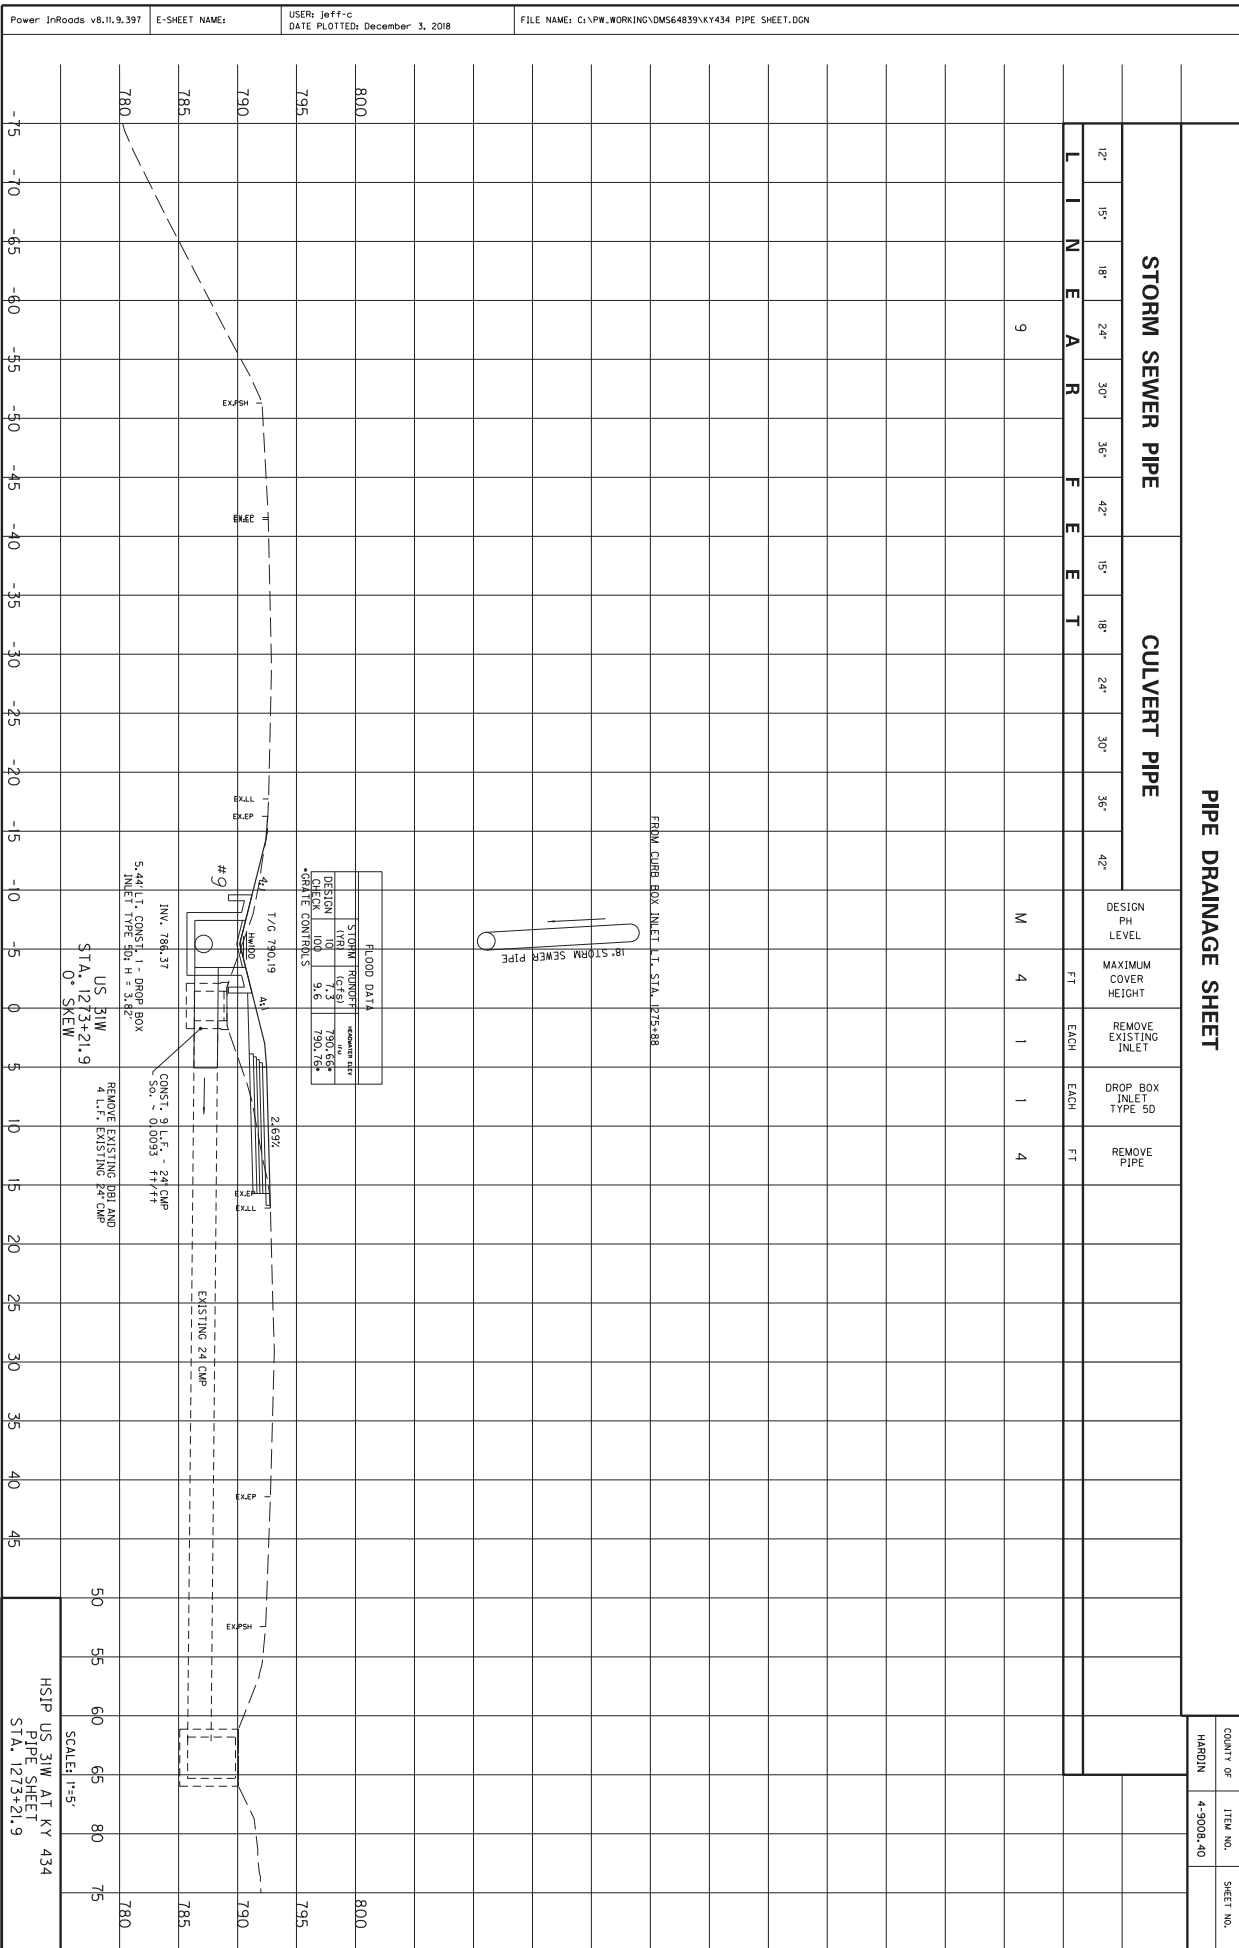

COUNTY OF	ITEM NO.	SHEET NO.
HARDIN	4-3008-40	


STORM SEWER PIPE						CULVERT PIPE									
L	I	N	E	A	R	F	E	E	T	L	I	N	E	A	R
12"	15"	18"	24"	30"	36"	42"	15"	18"	24"	30"	36"	42"			
			9												

DESIGN PH LEVEL	MAXIMUM COVER HEIGHT	REMOVE EXISTING INLET	DROP BOX INLET TYPE 5D	REMOVE PIPE
M	4	1	1	4

FLOOD DATA			
STORM FLOOD	DESIGN	CHECK	DATE
100	100	100	100

INV. 786.37
 5.44' I.T. CONST. 1" DROP BOX
 INLET TYPE 5D, H = 3.42'
 US 31W
 STA. 1273+21.9
 O-SKEW
 REMOVE EXISTING DBI AND
 4 L.I., EXISTING 24 CMP
 CONST. 0 I.F. - 24" CMP
 50' - 0" 00'3" 11' 11"

HSIP US 31W AT KY 434
 PIPE SHEET
 STA. 1273+21.9
 SCALE 1"=5'

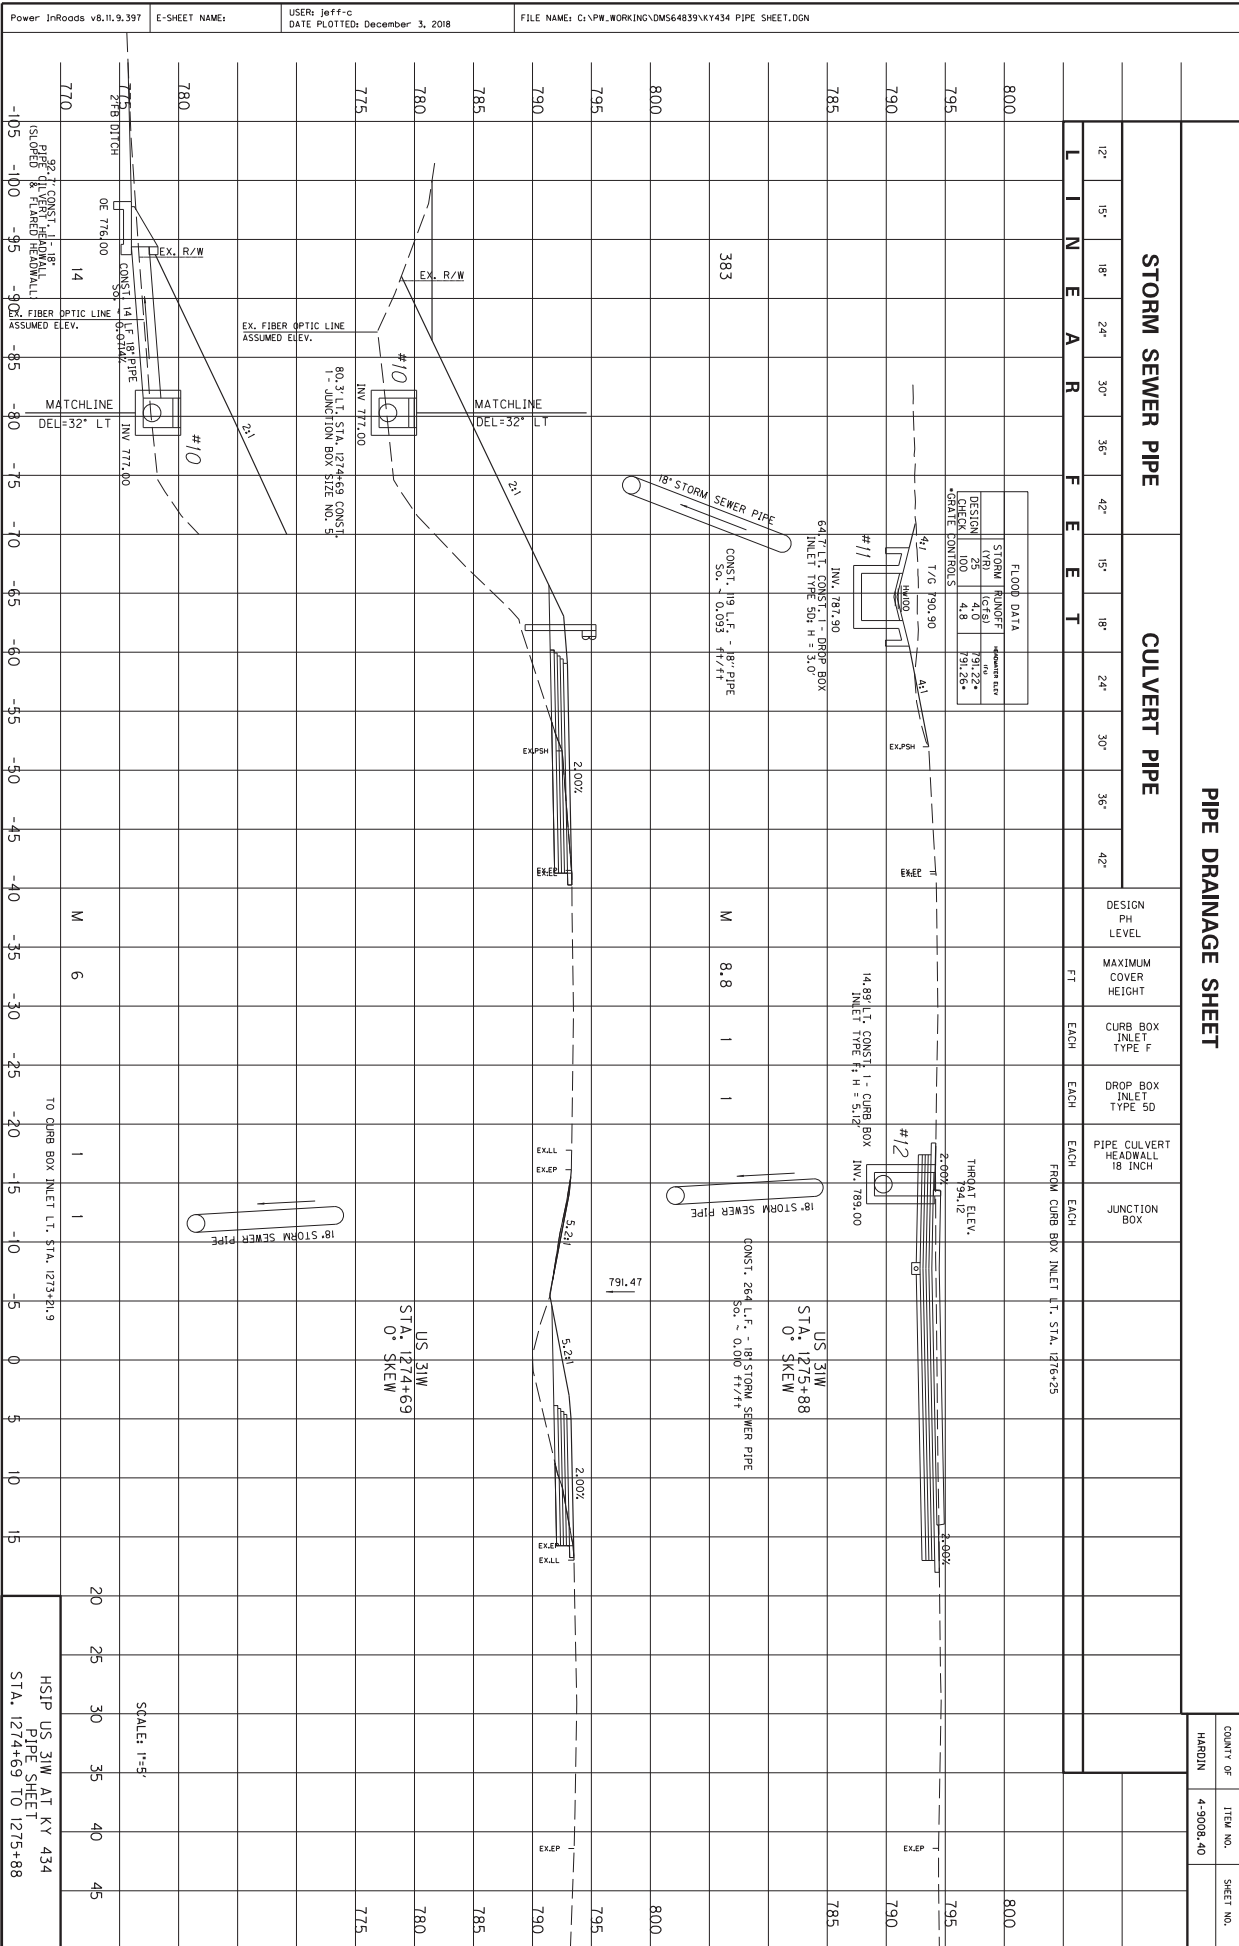

COUNT OF	ITEM NO.	SHEET NO.
HARDIN	4-9008, 40	

PIPE DRAINAGE SHEET

STORM SEWER PIPE

LINE	FEET	DESIGN PH LEVEL	MAXIMUM COVER HEIGHT	CURB BOX INLET TYPE	DROP BOX INLET TYPE	PIPE CULVERT HEADWALL 18 INCH	JUNCTION BOX
12"	15'						
18"	24'						
24"	30'						
30"	36'						
36"	42'						
42"	15'						
18"	18'						
24"	24'						
30"	30'						
36"	36'						
42"	42'						

FLOOD DATA	
DESIGN STORM (CFR)	4.0
DESIGN FLOOD (CFR)	4.0
CHECK FLOOD (CFR)	4.0
DESIGN CONDUITS	4.0
DESIGN CONDUITS	4.0

64 FT. TYP. 50' H = 3.0'


CONST. 19 L.F. - 18" PIPE
SO. = 0.0093 41/4"


CONST. 26 L.F. - 18" STORM SEWER PIPE
SO. = 0.010 41/4"


CONST. 31 L.F. STA. 1274+69 CONST. 1" JUNCTION BOX SIZE 18" X 18"


SCALE: 1"=4'


HSIP US 31W AT KY 434
PIPE SHEET
STA. 1274+69 TO 1275+88

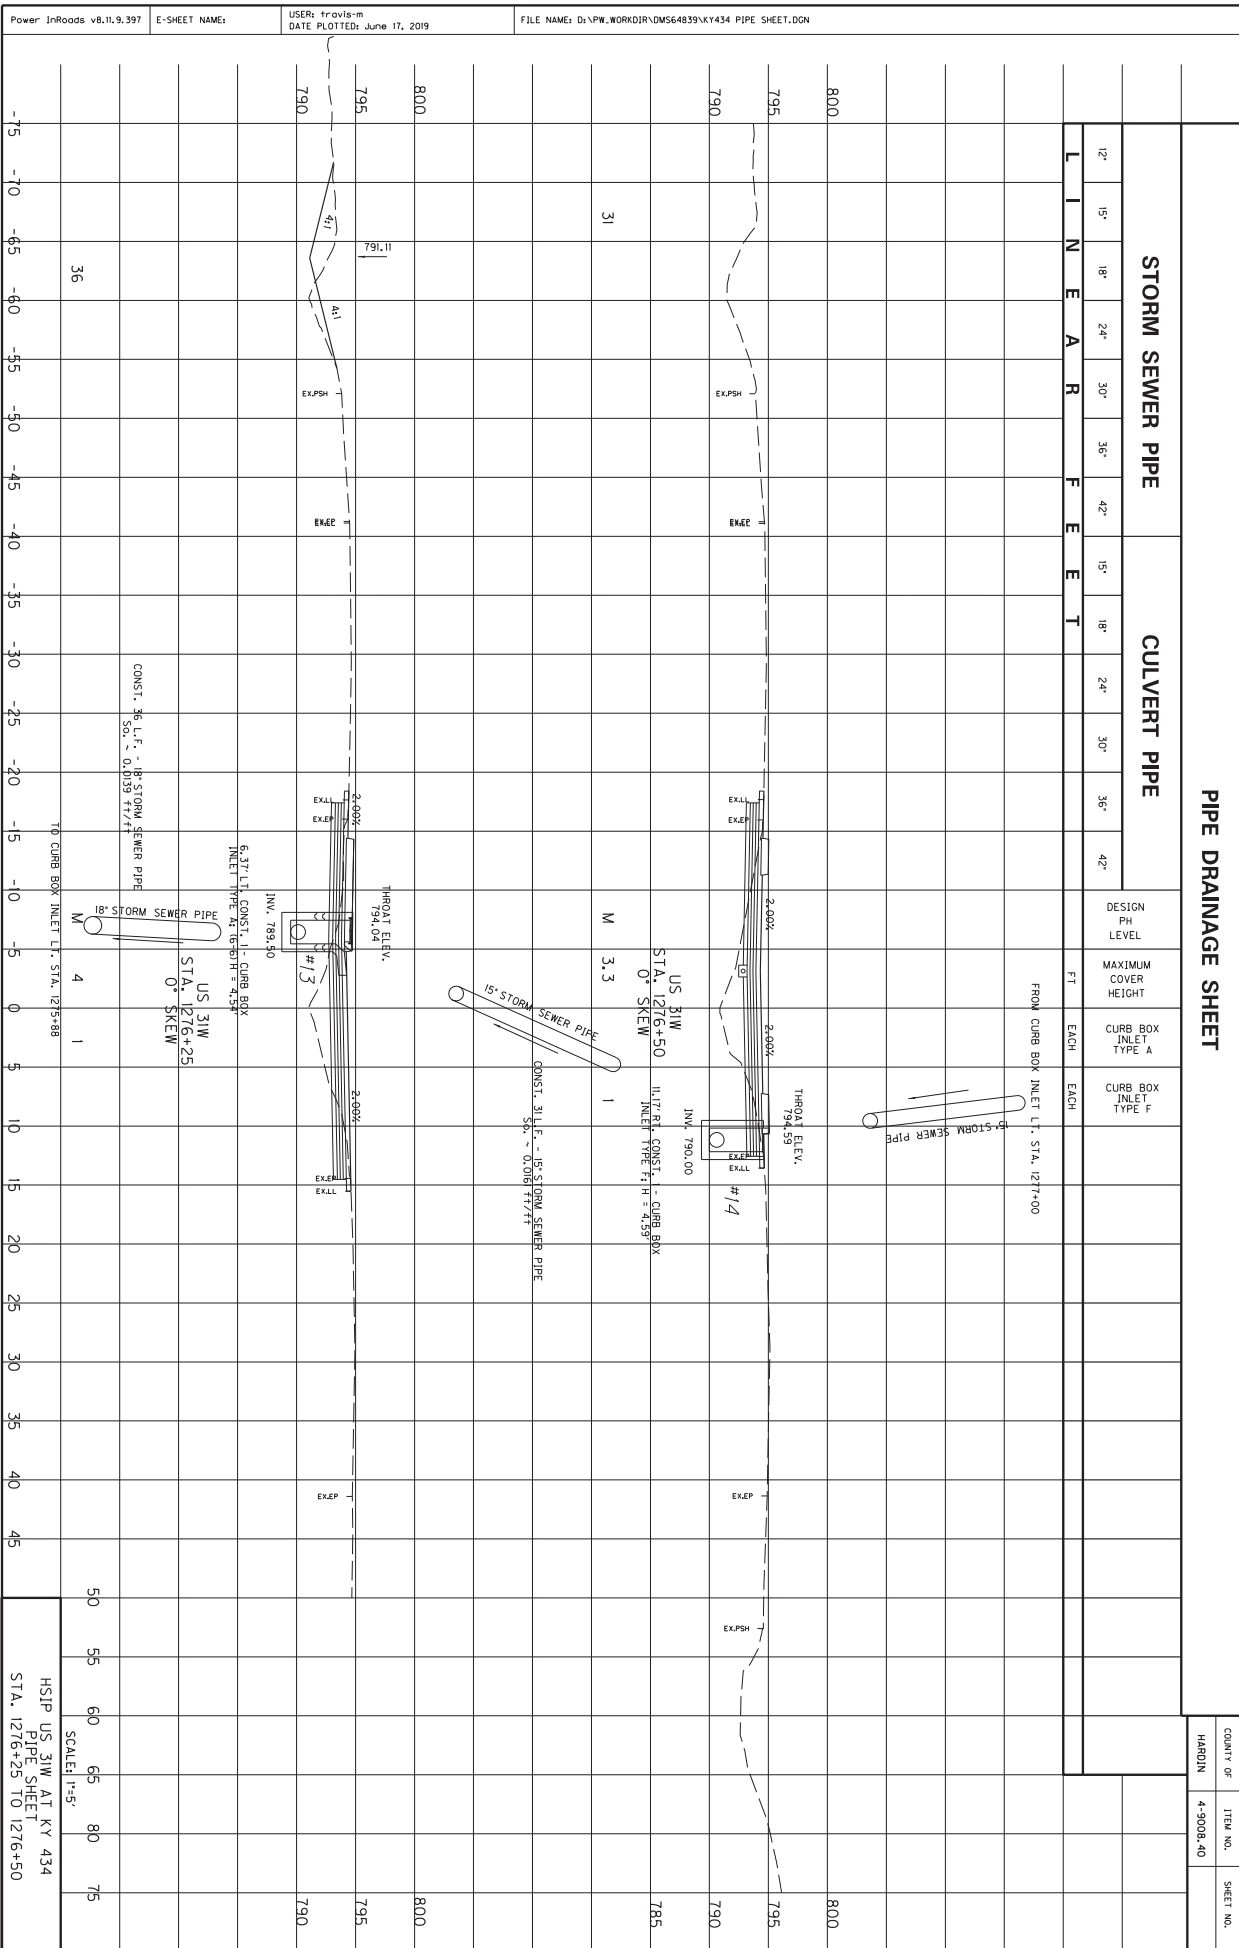


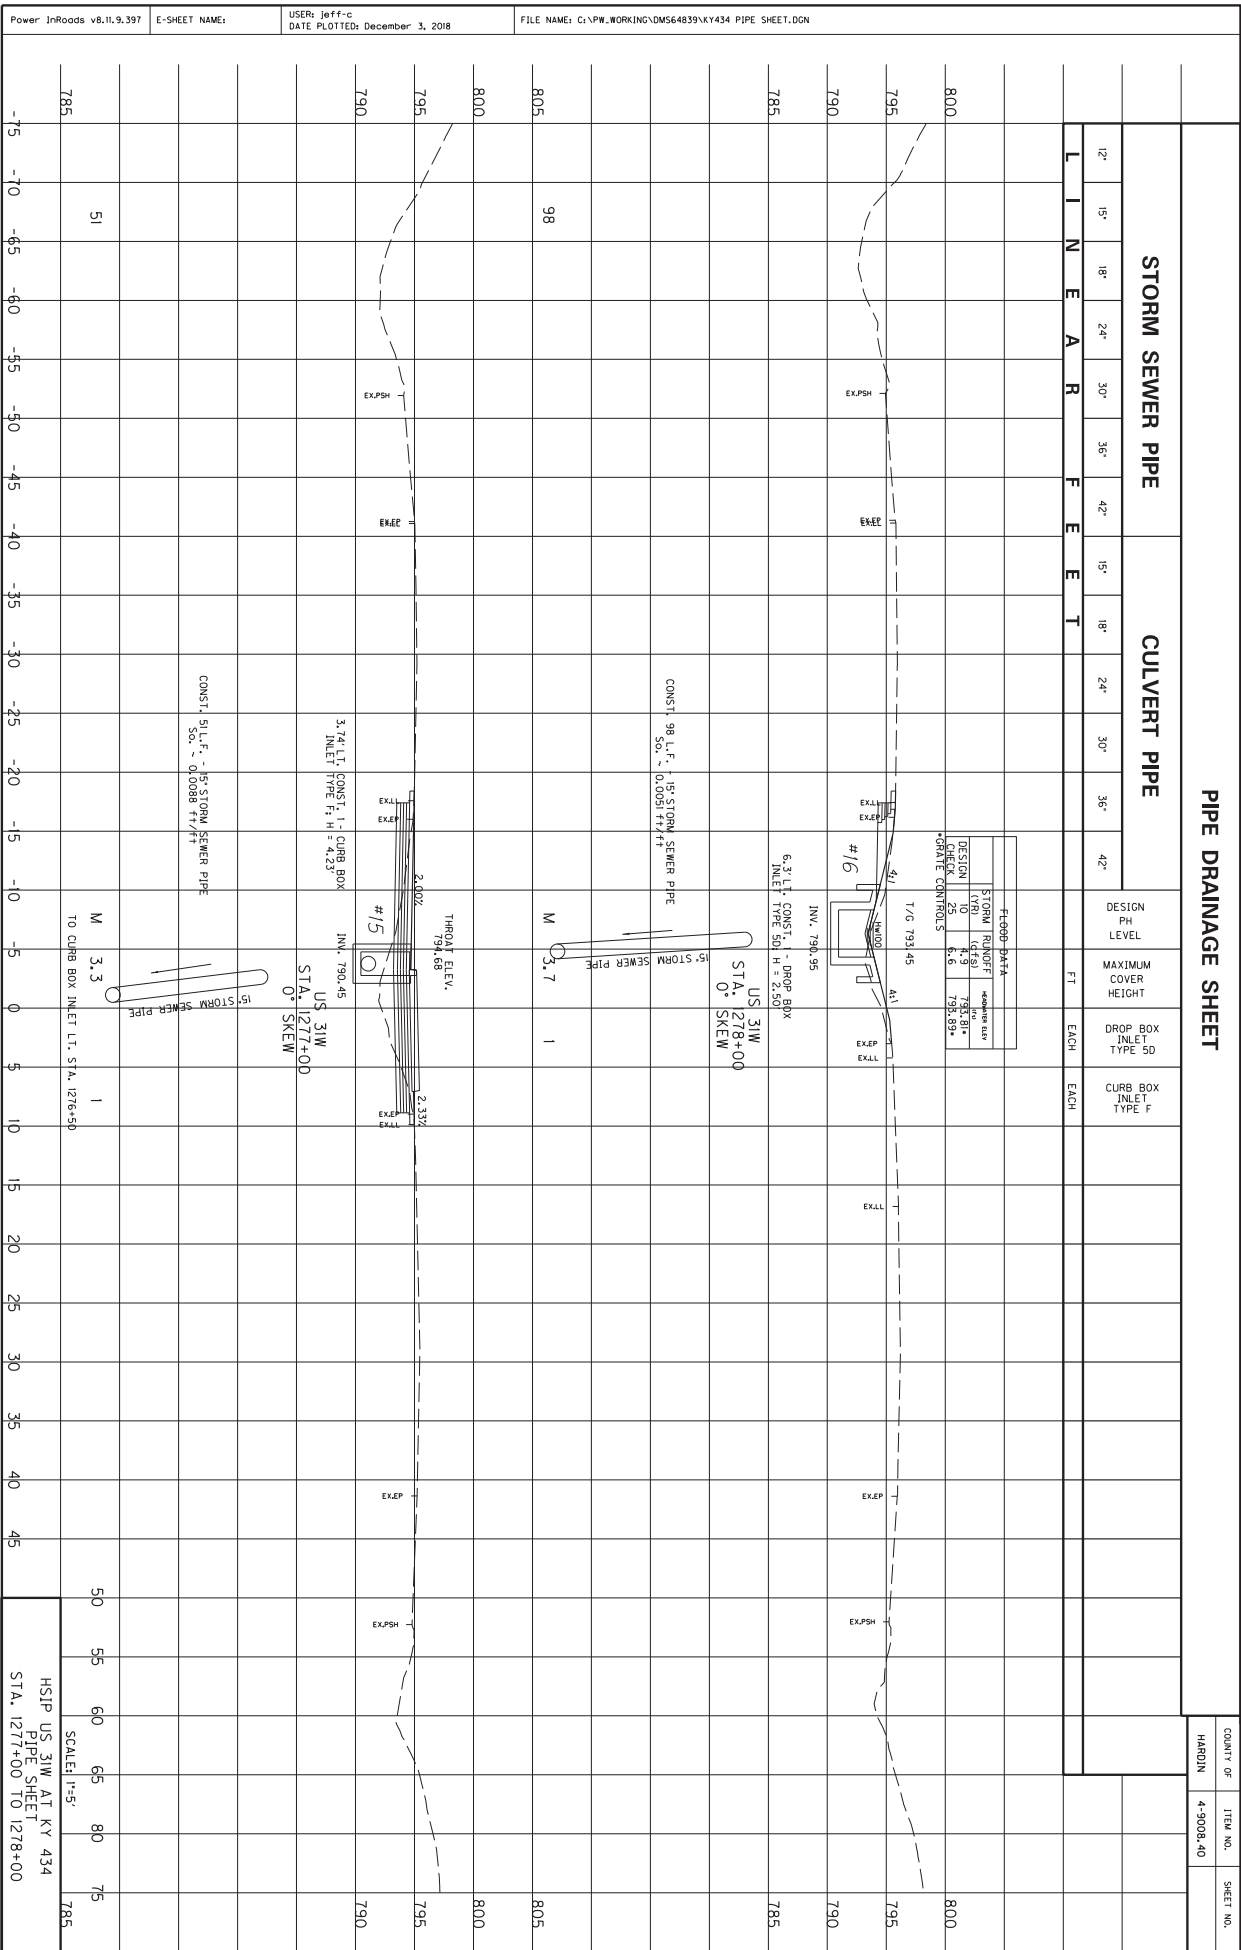


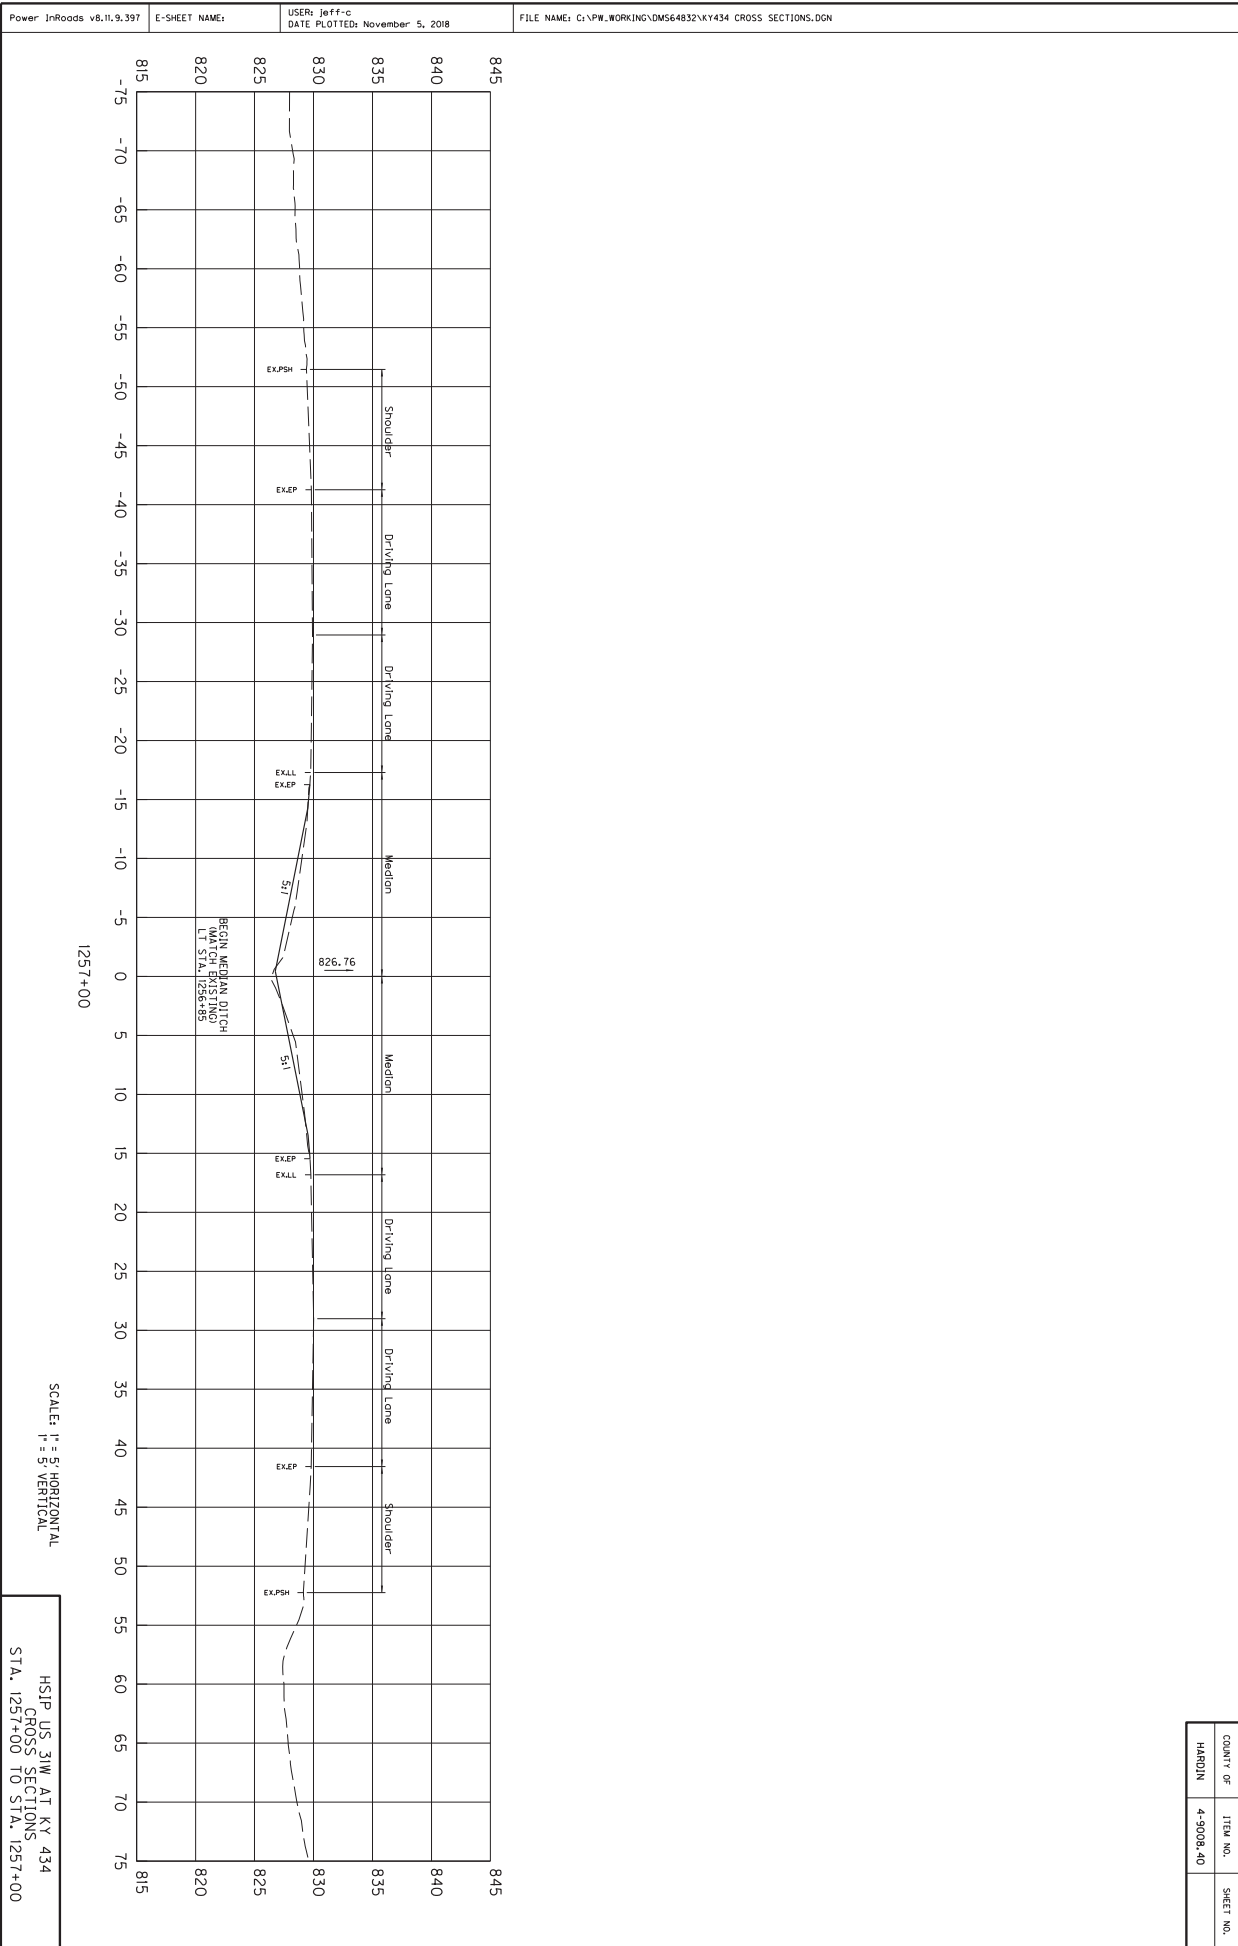

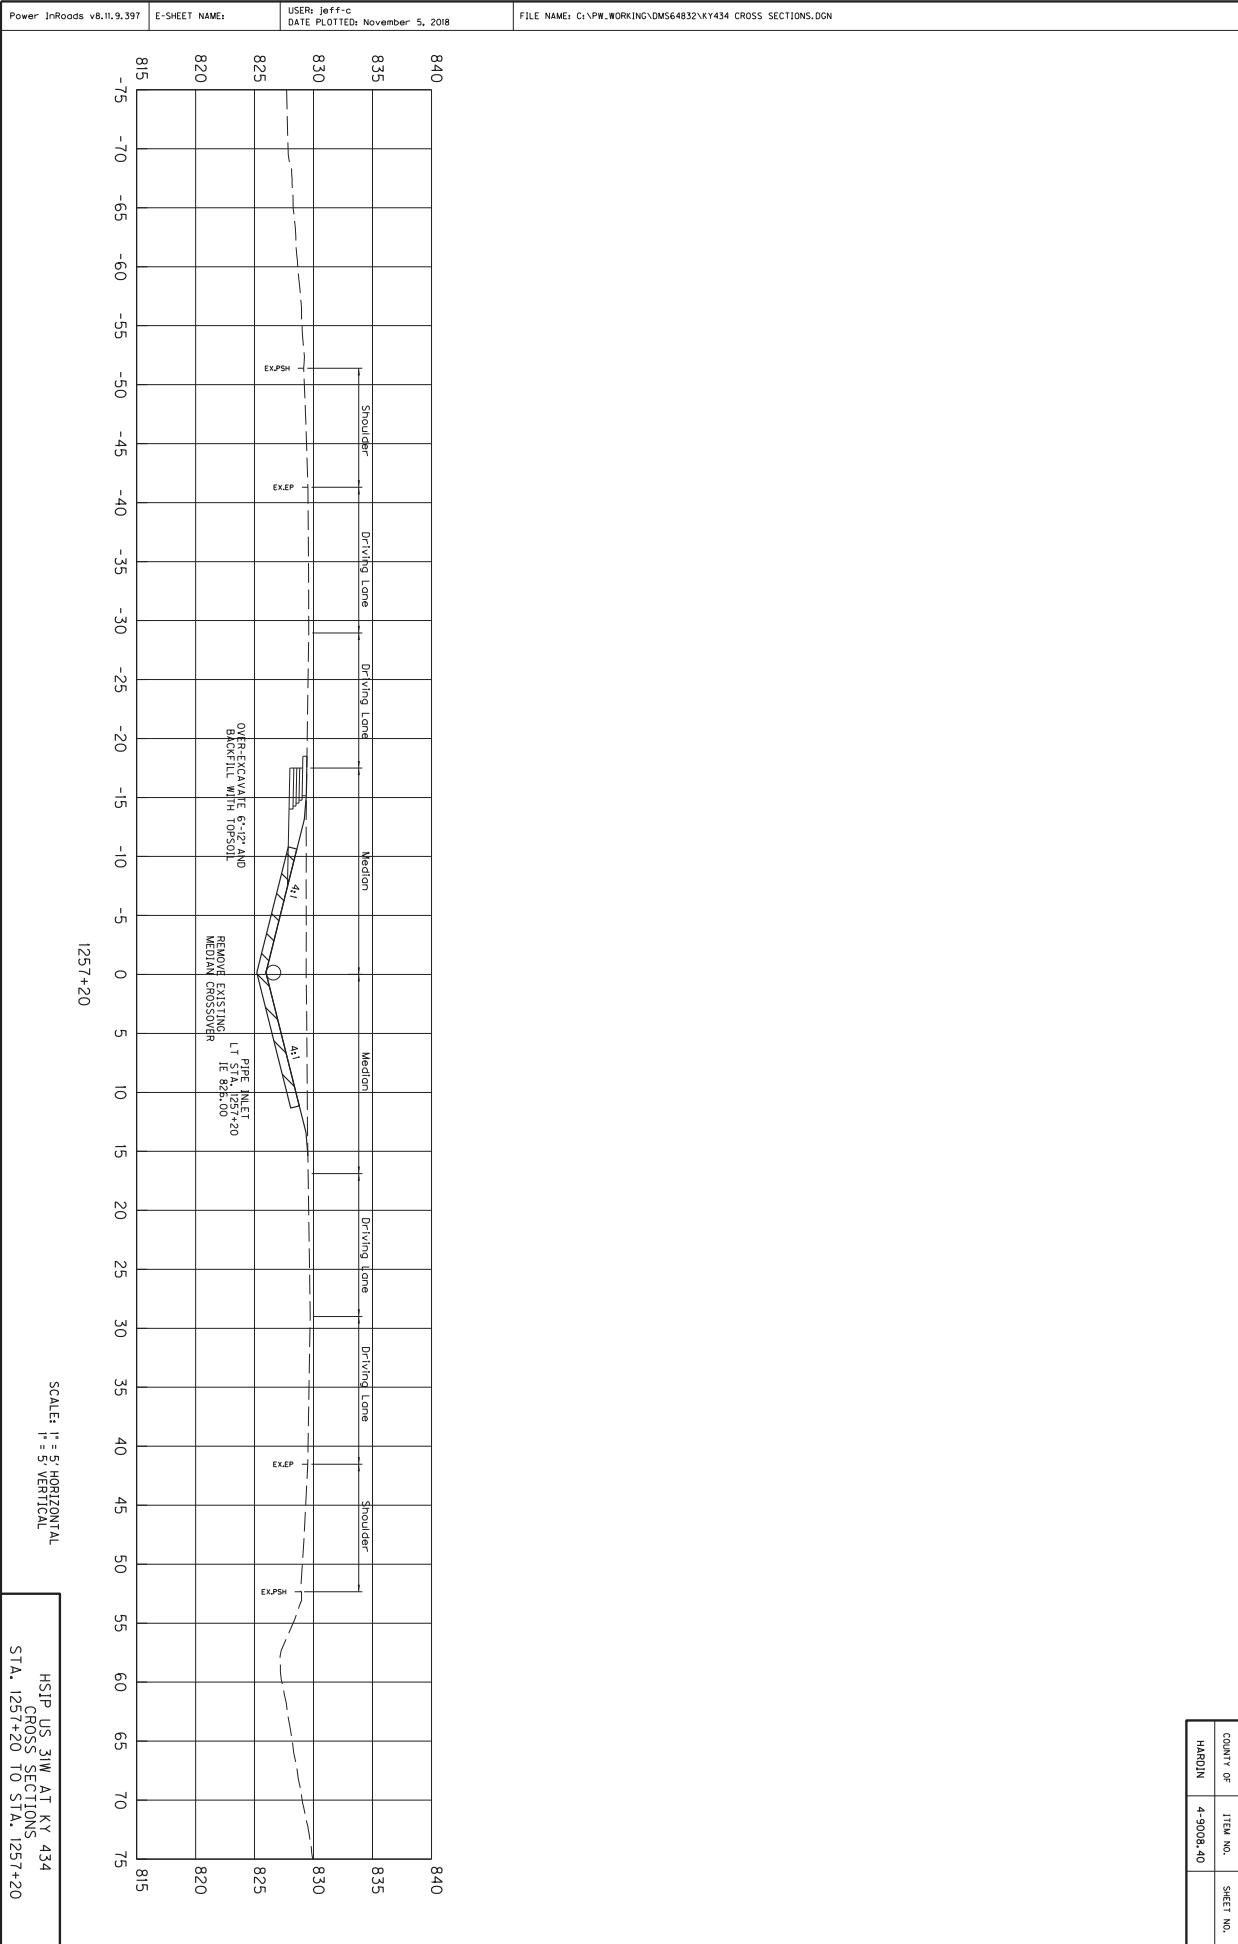

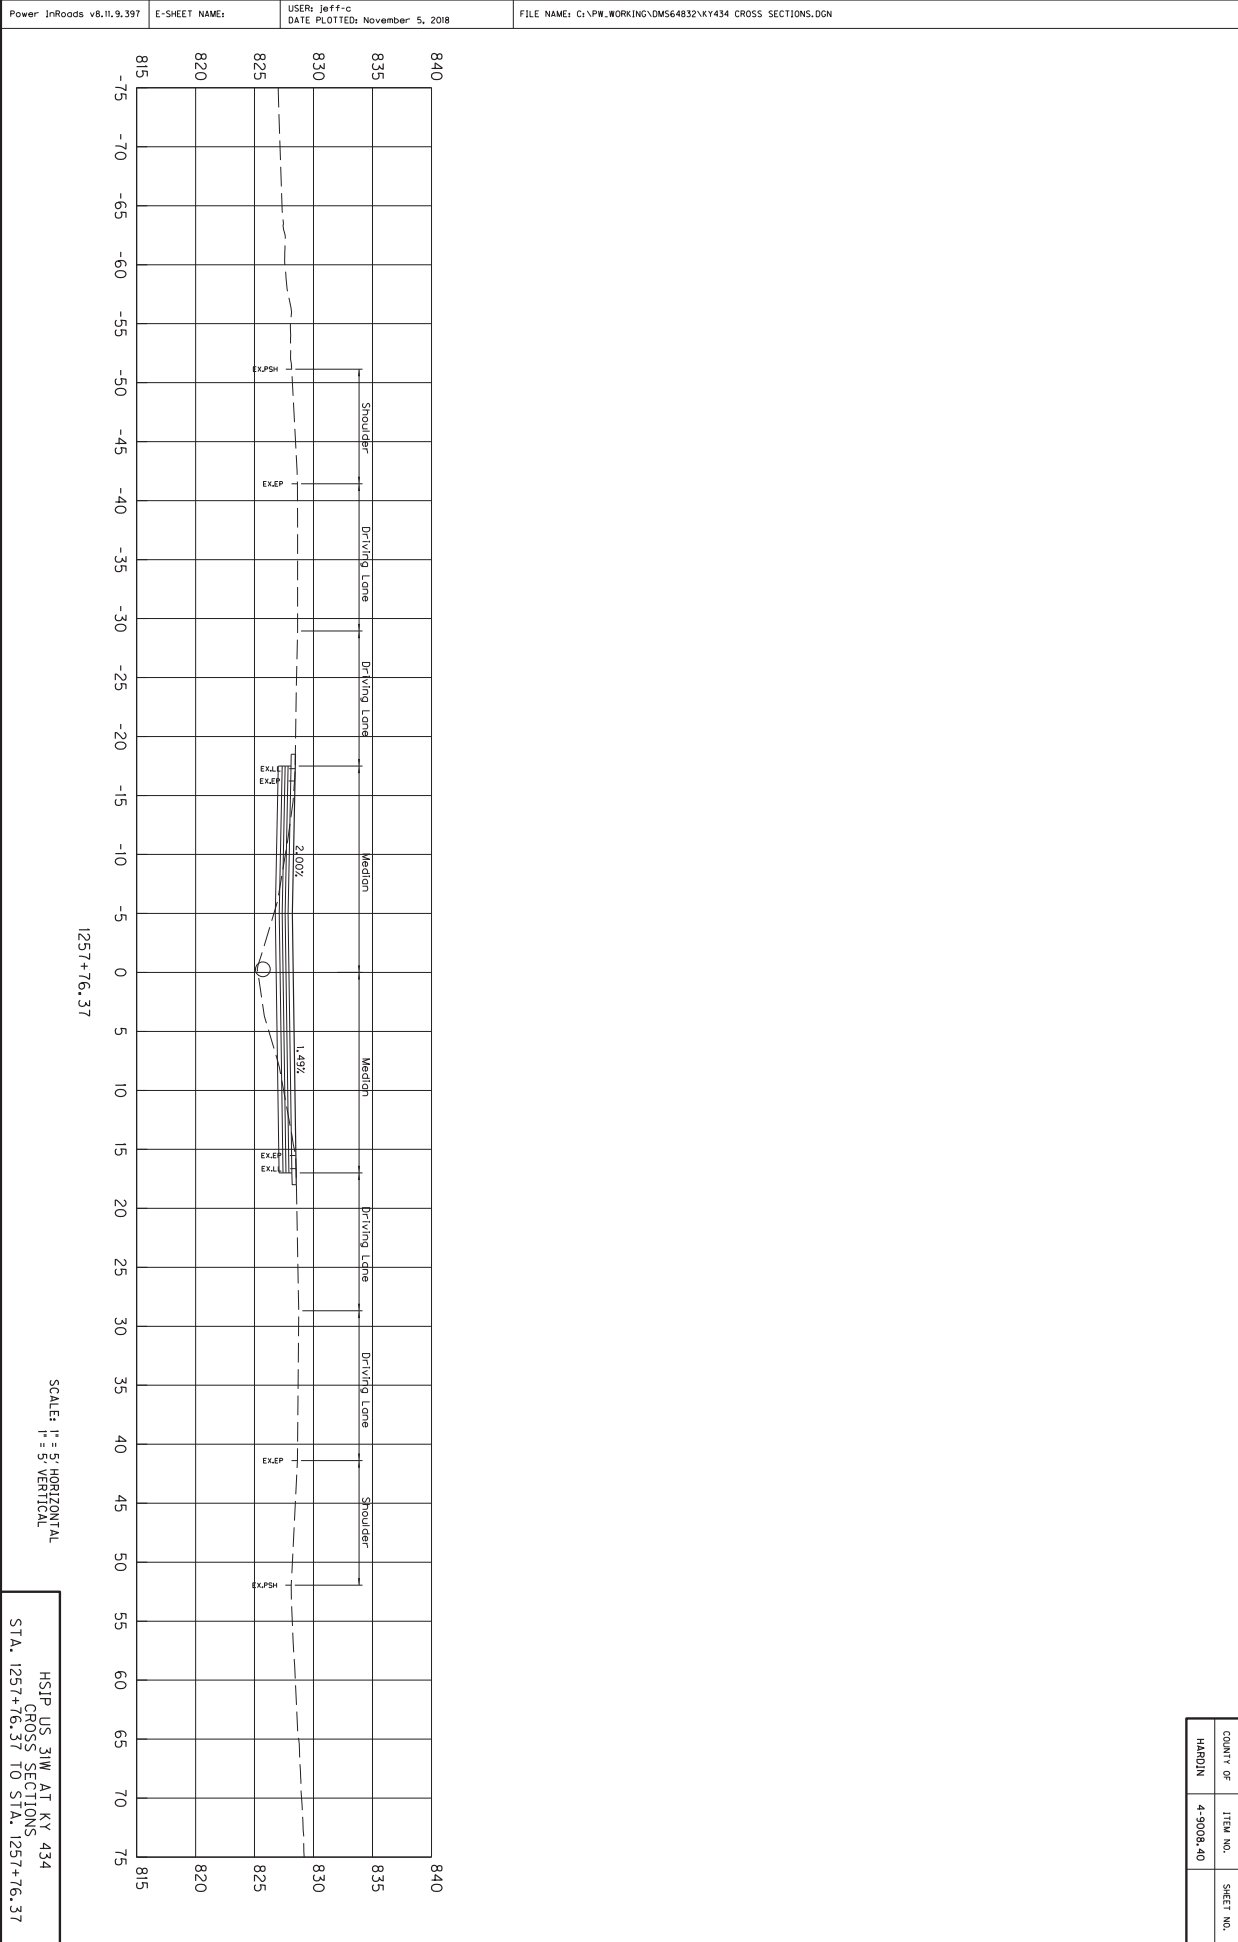

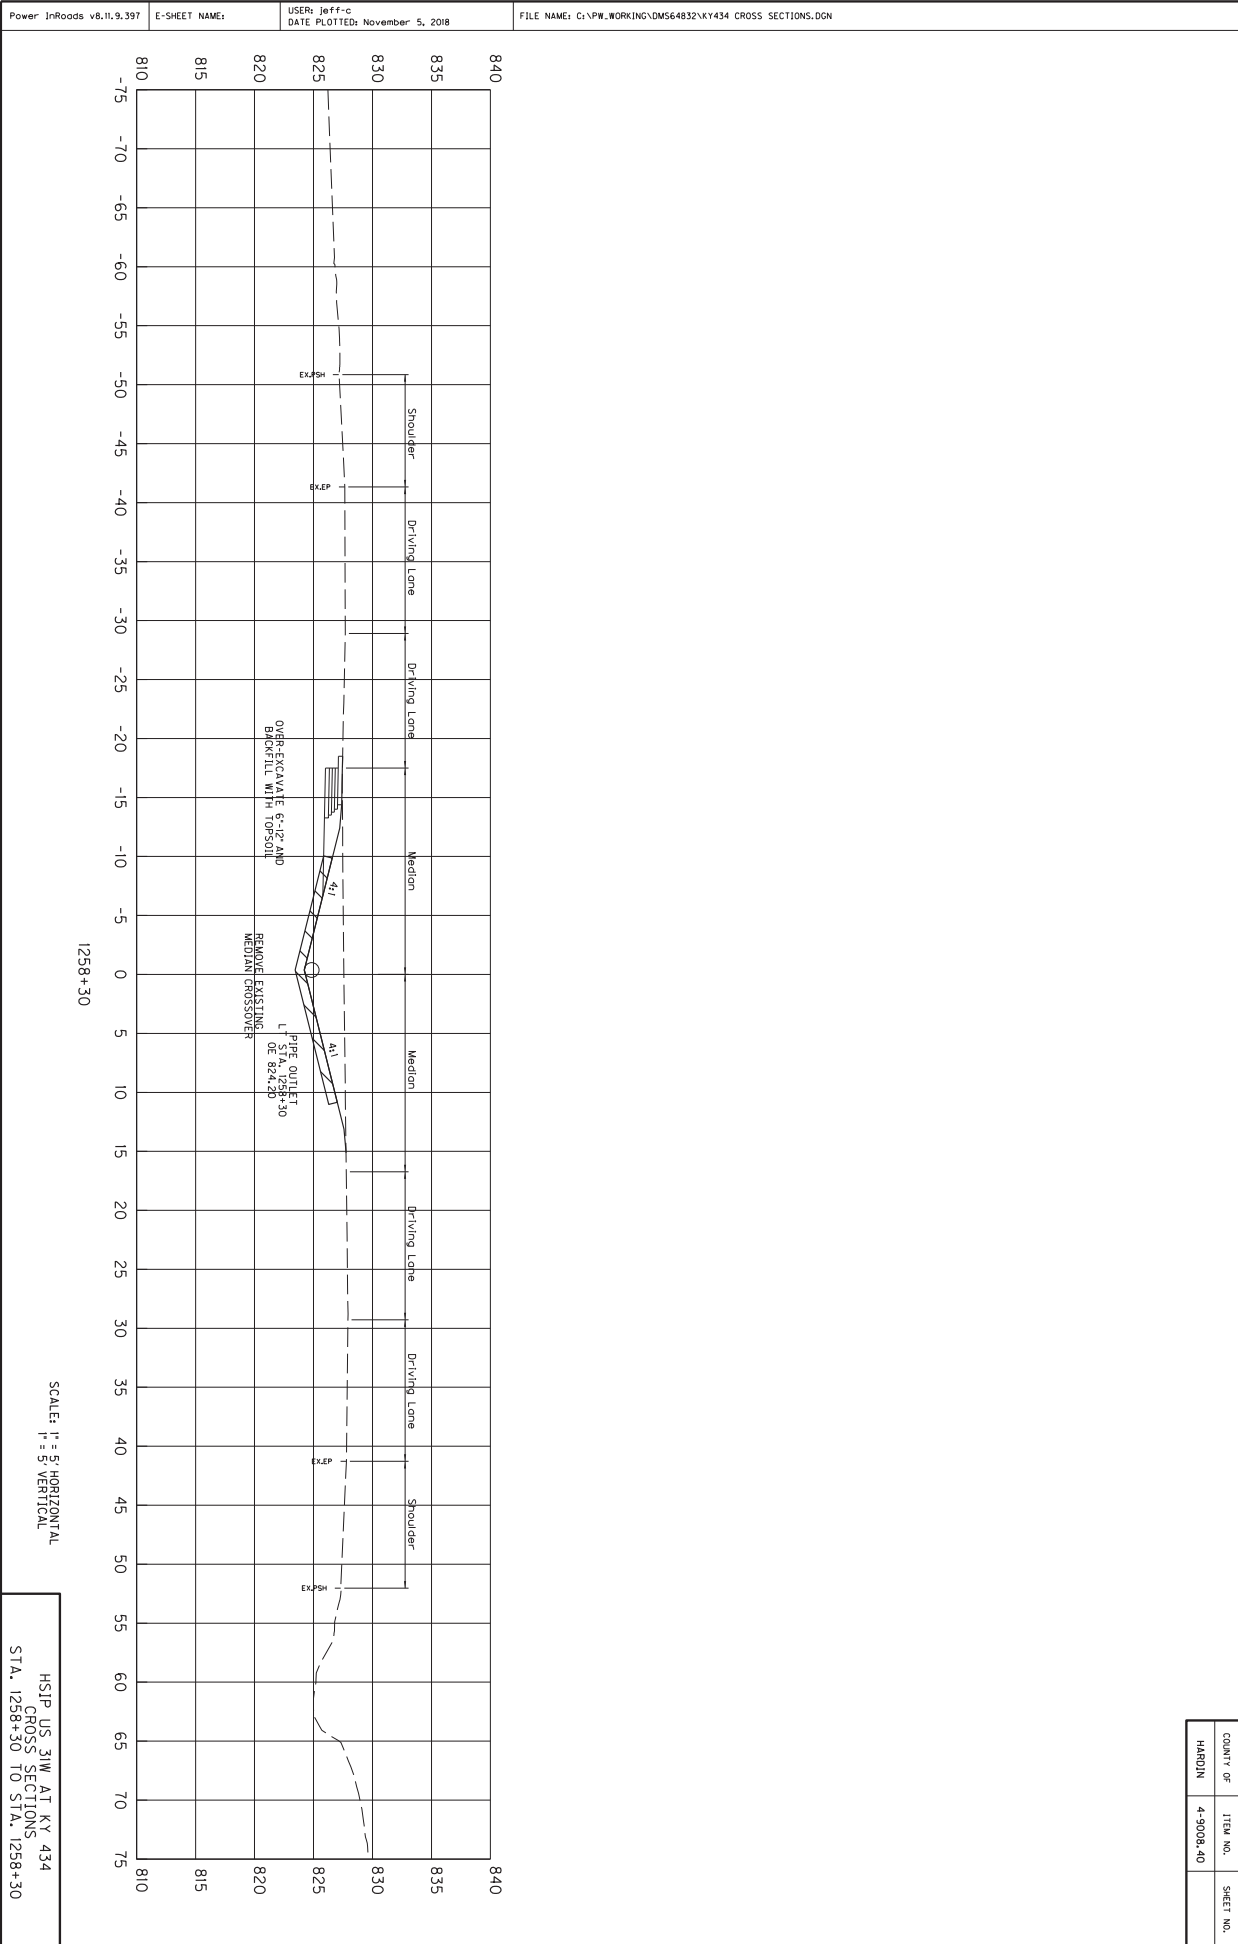


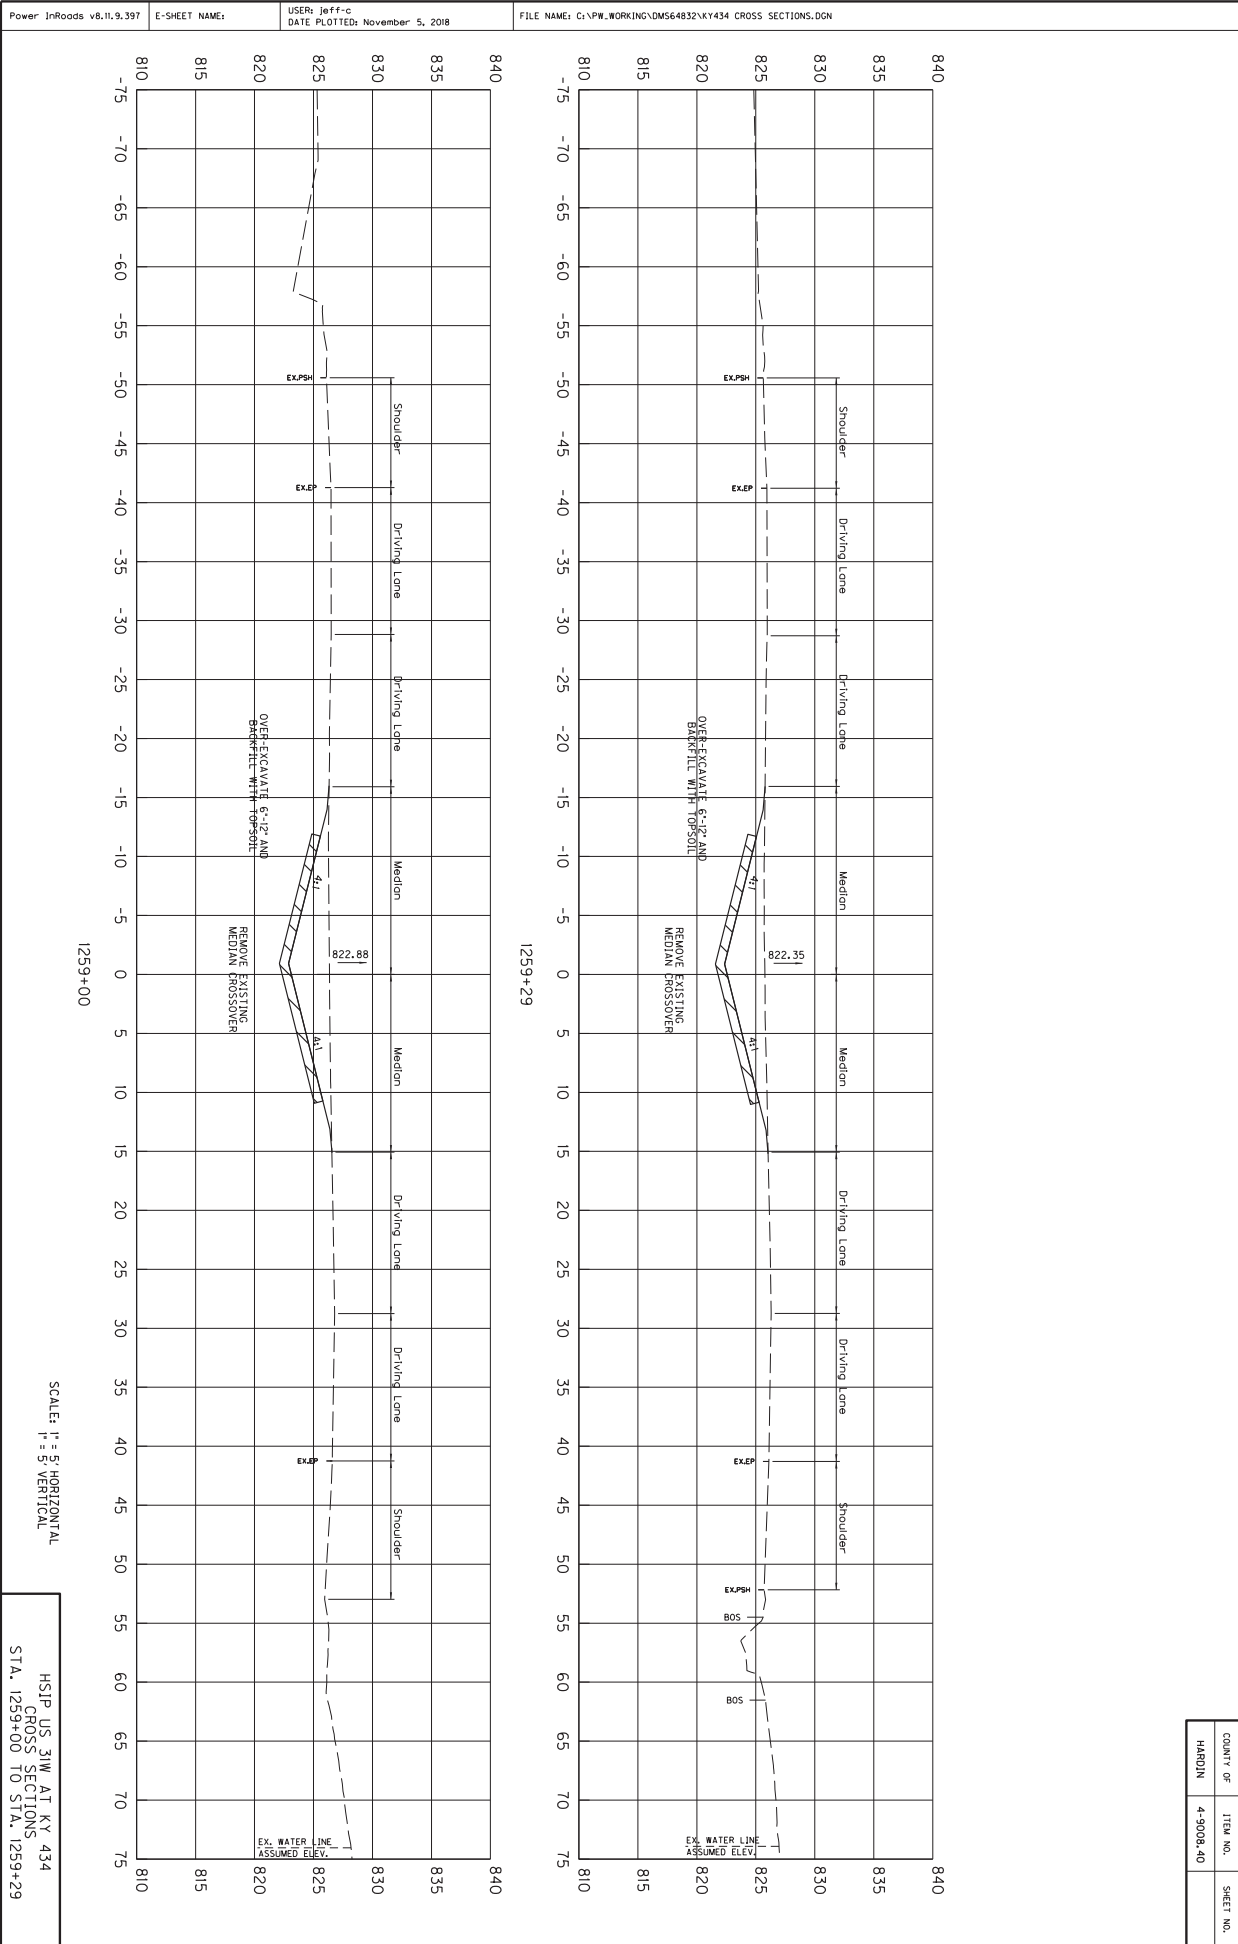



SCALE: H = 5' HORIZONTAL
V = 5' VERTICAL


HSIP US 31W AT KY 434
CROSS SECTIONS
STA. 1259+00 TO STA. 1259+29


COUNTY OF	ITEM NO.	SHEET NO.
HARDIN	4-9008.40	

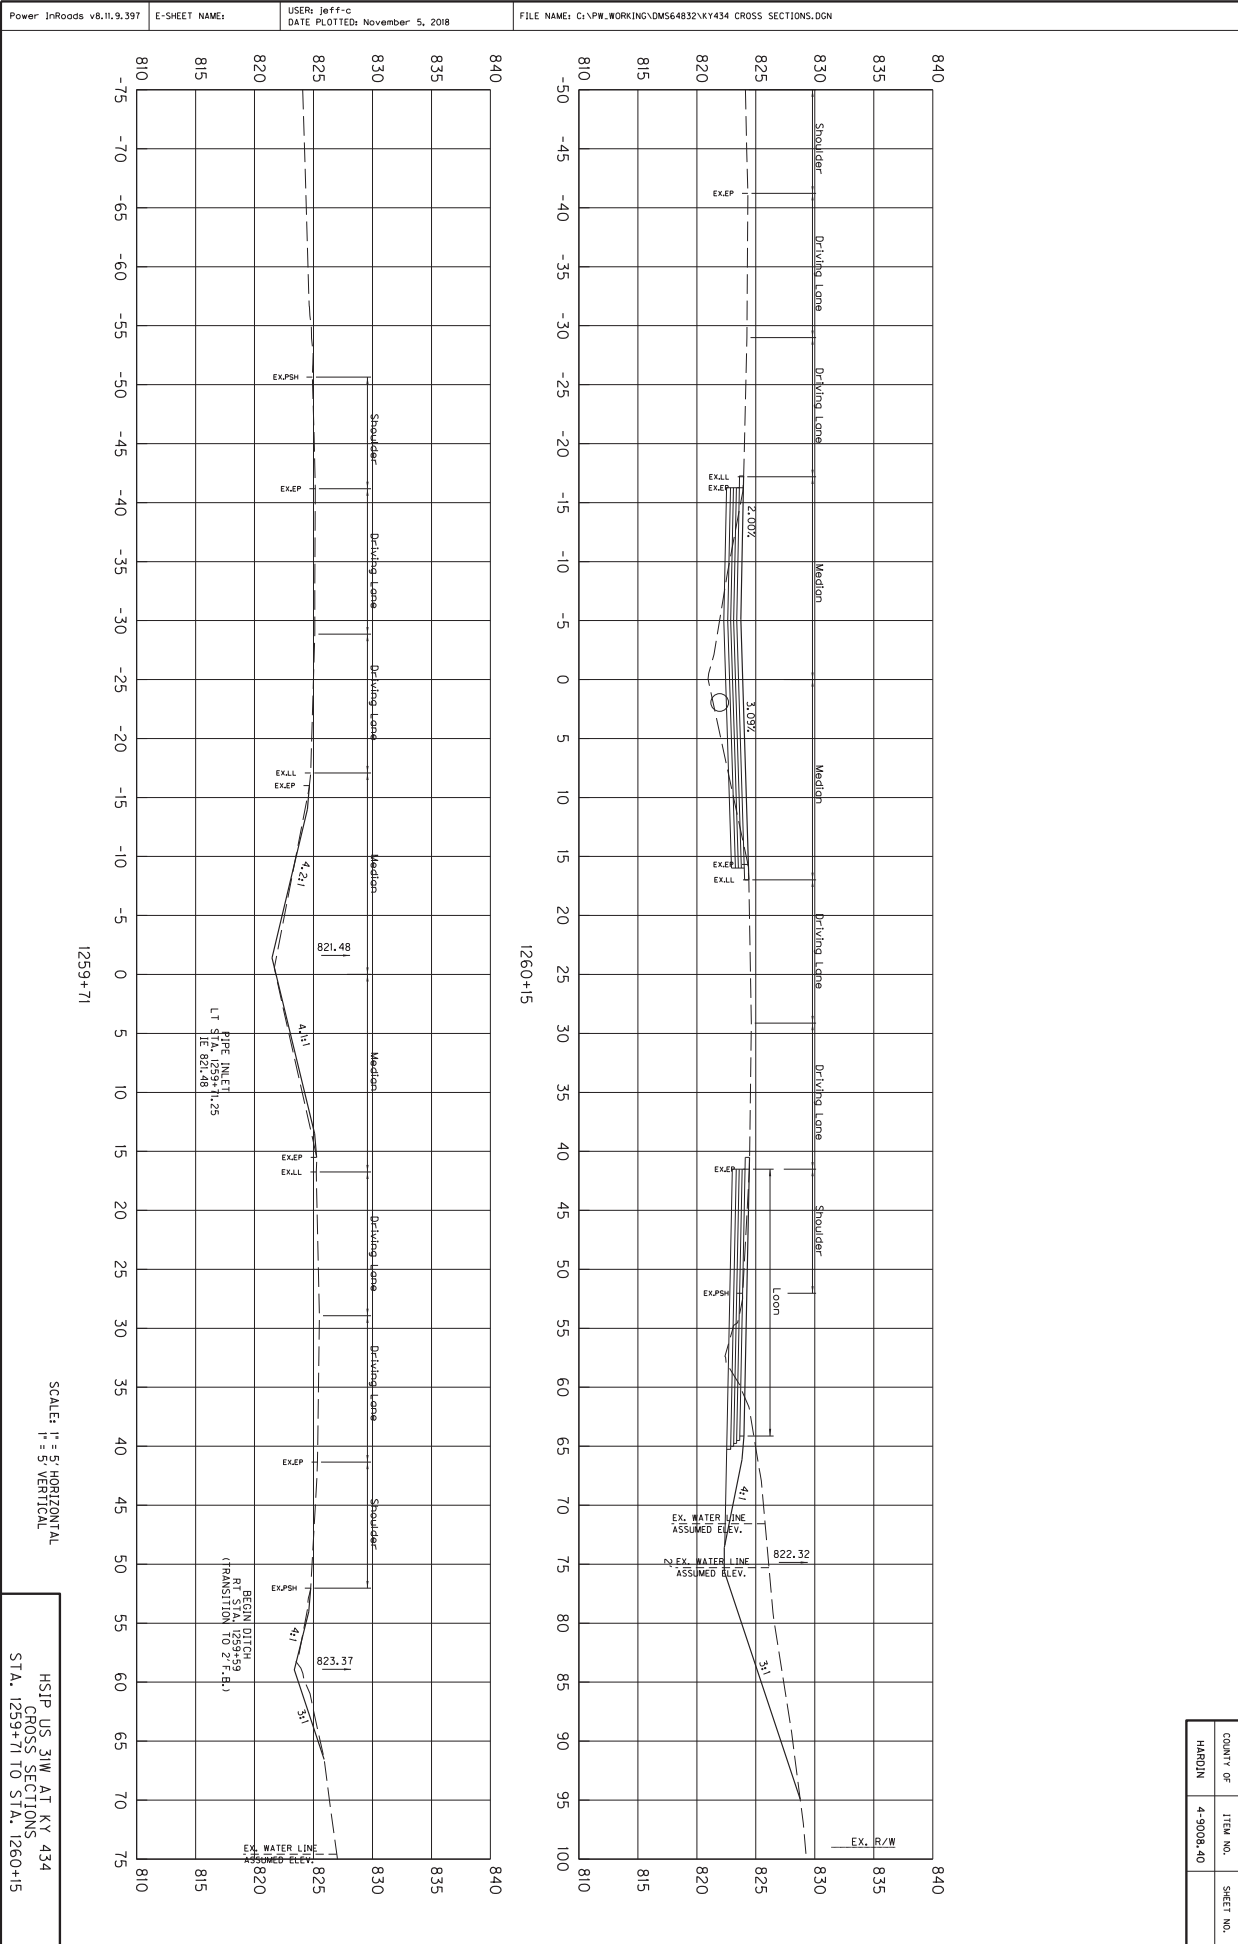


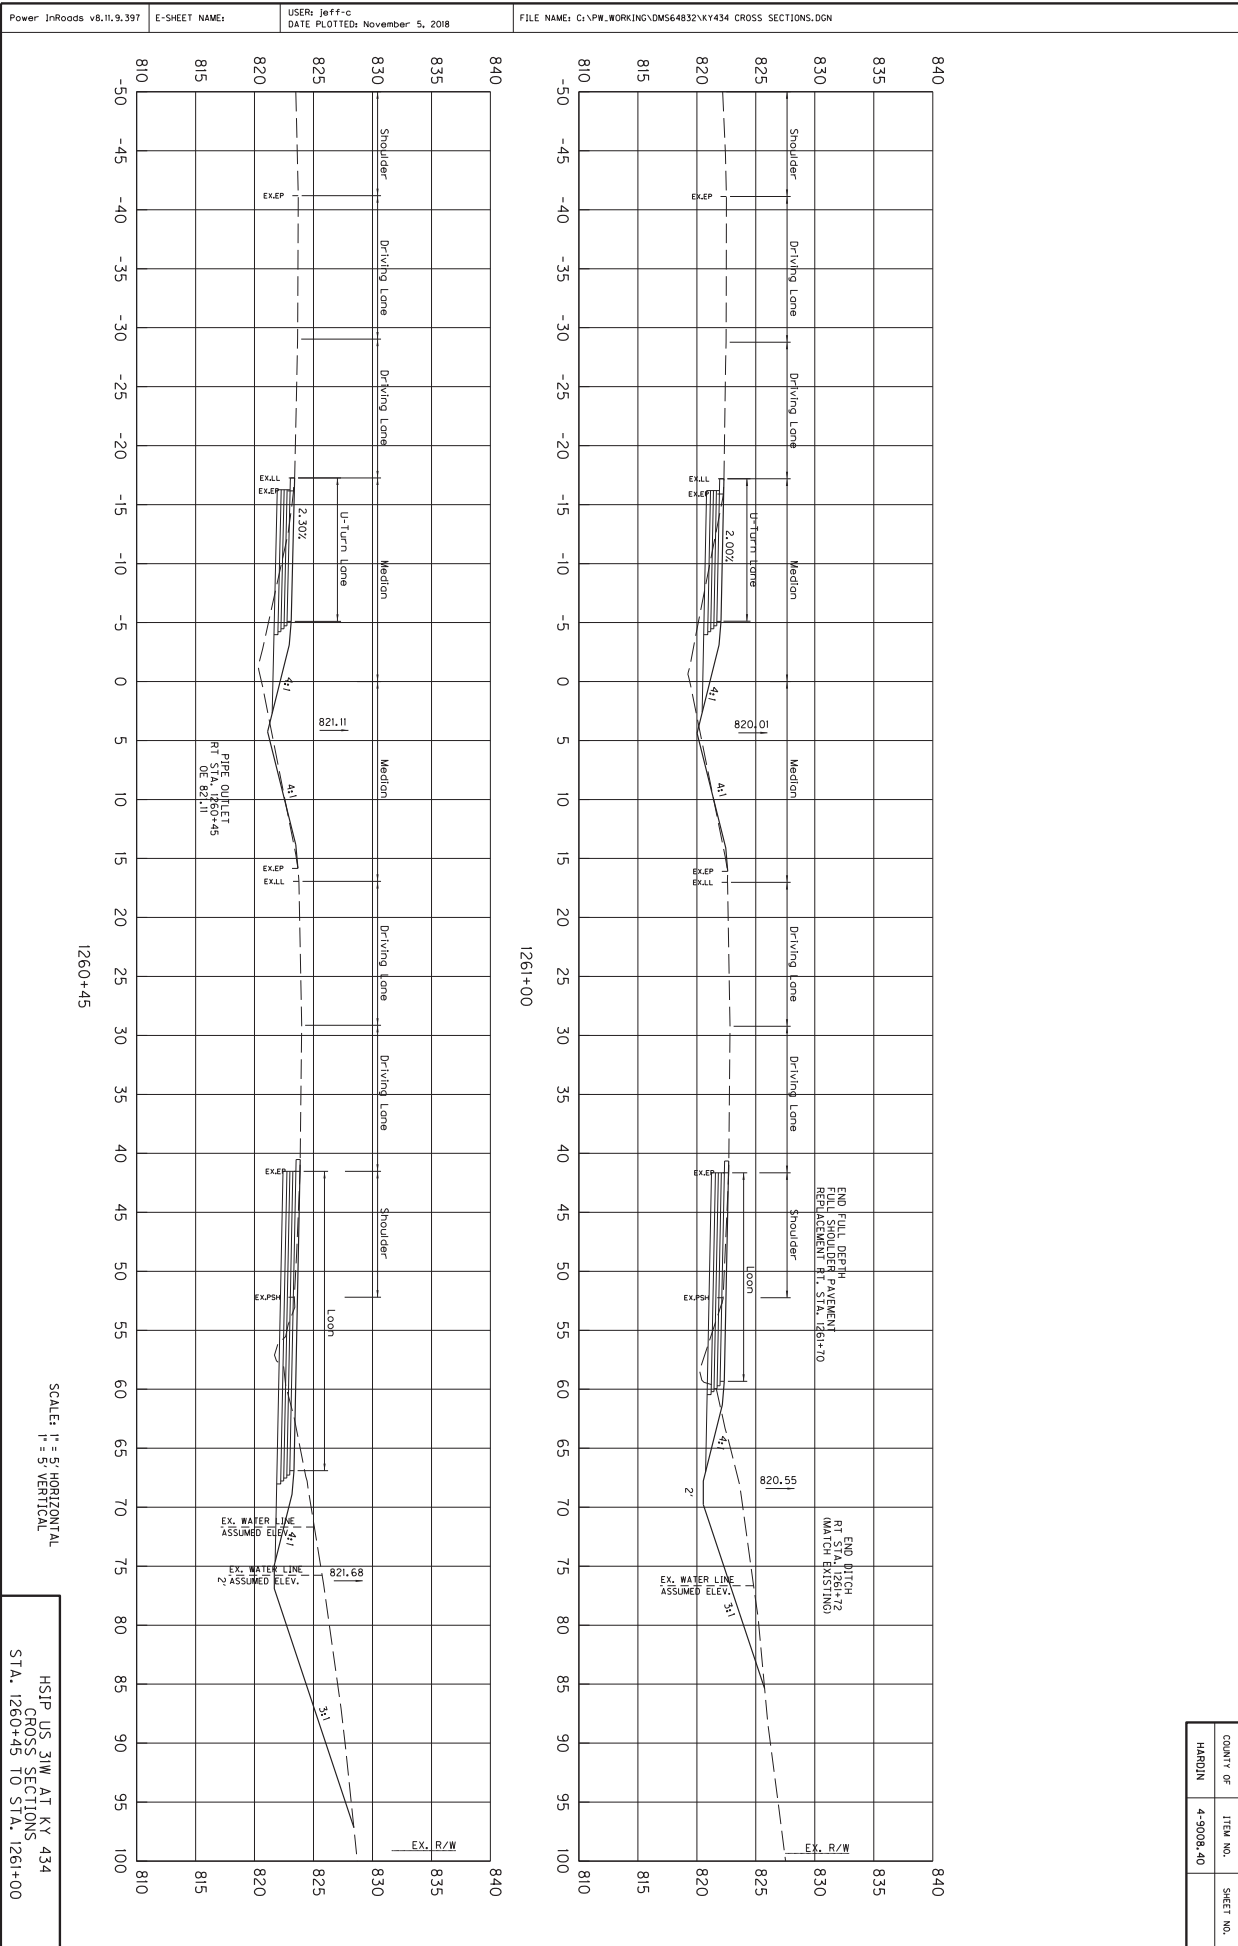


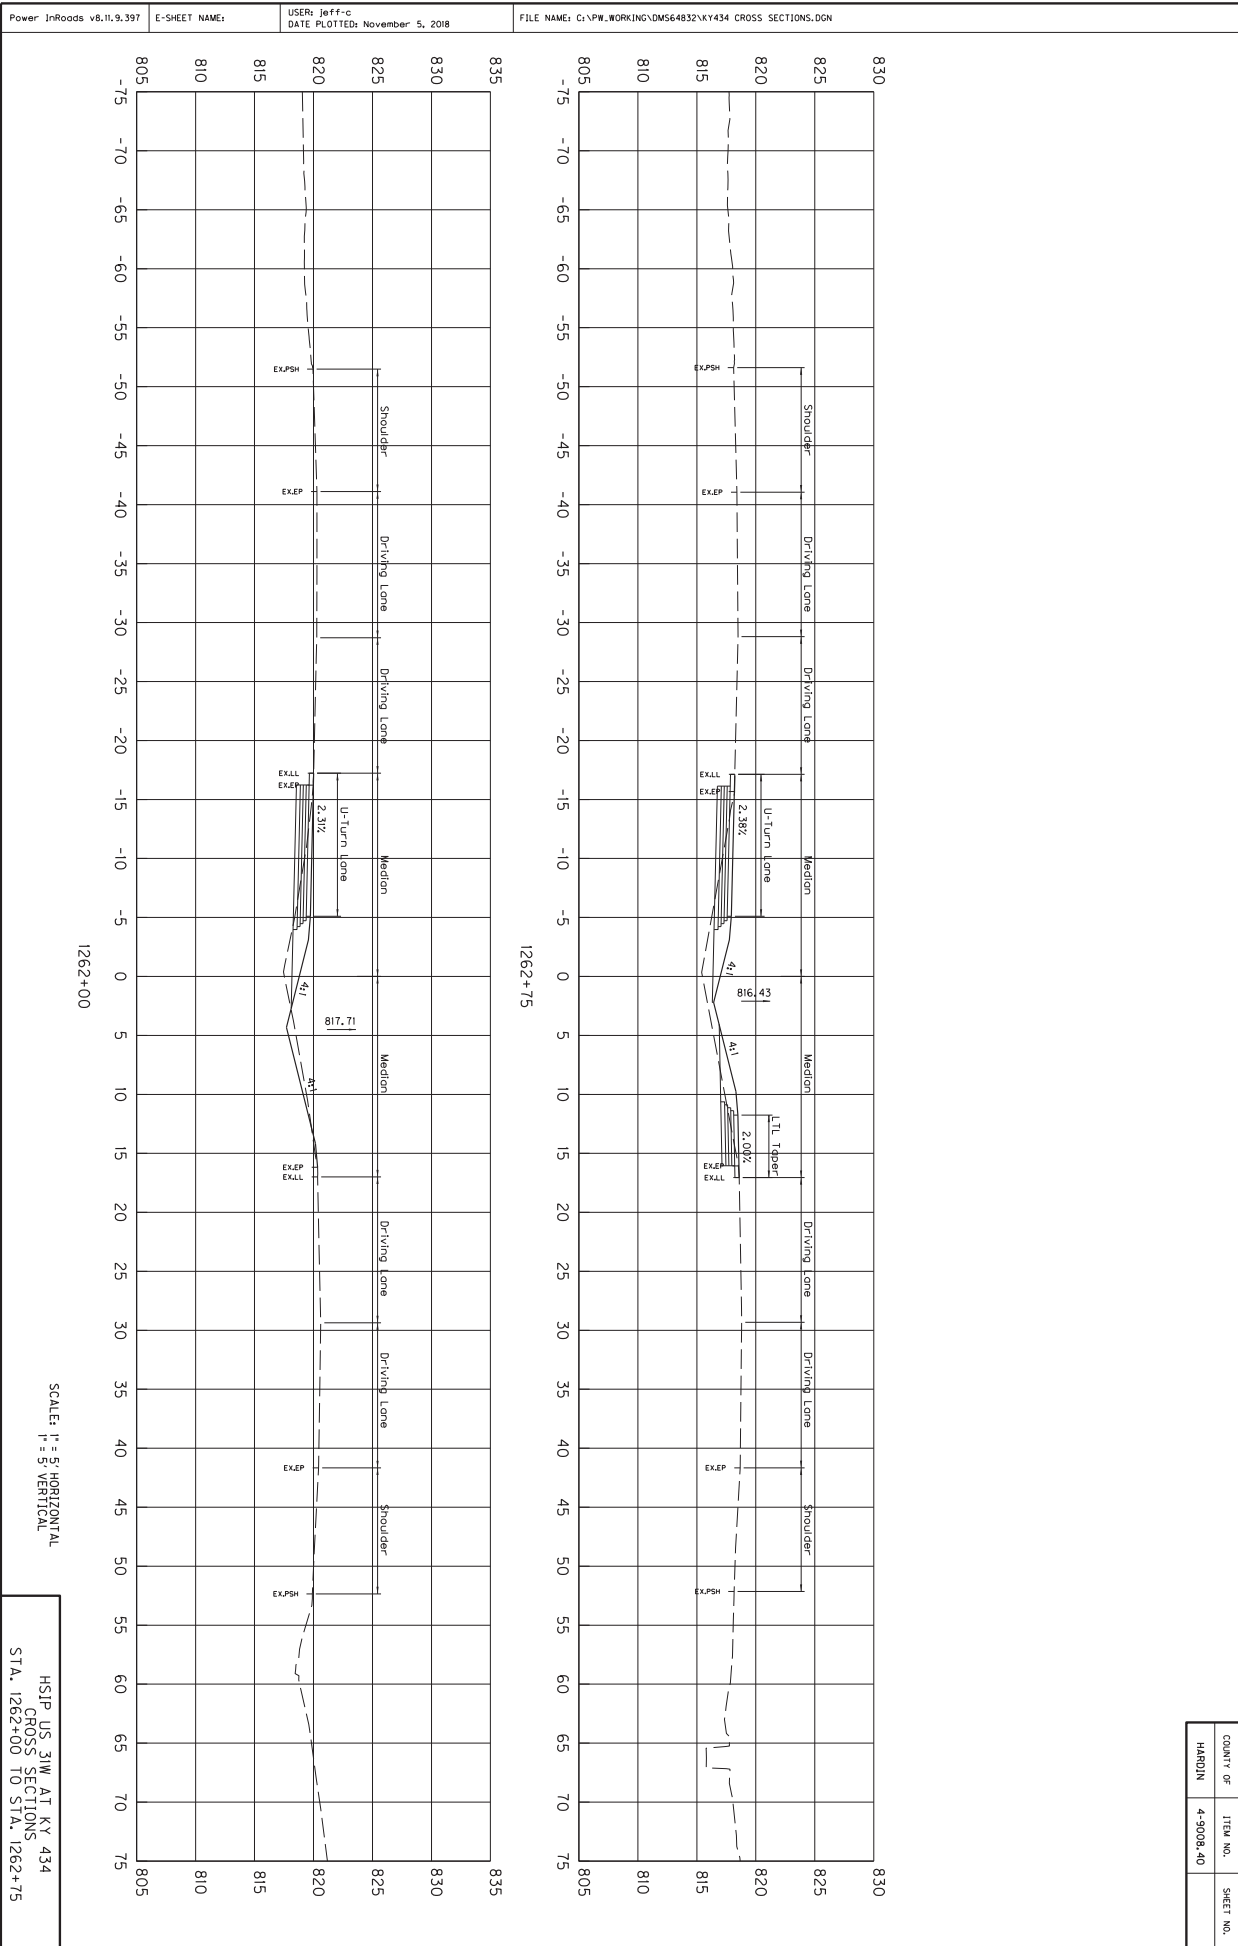


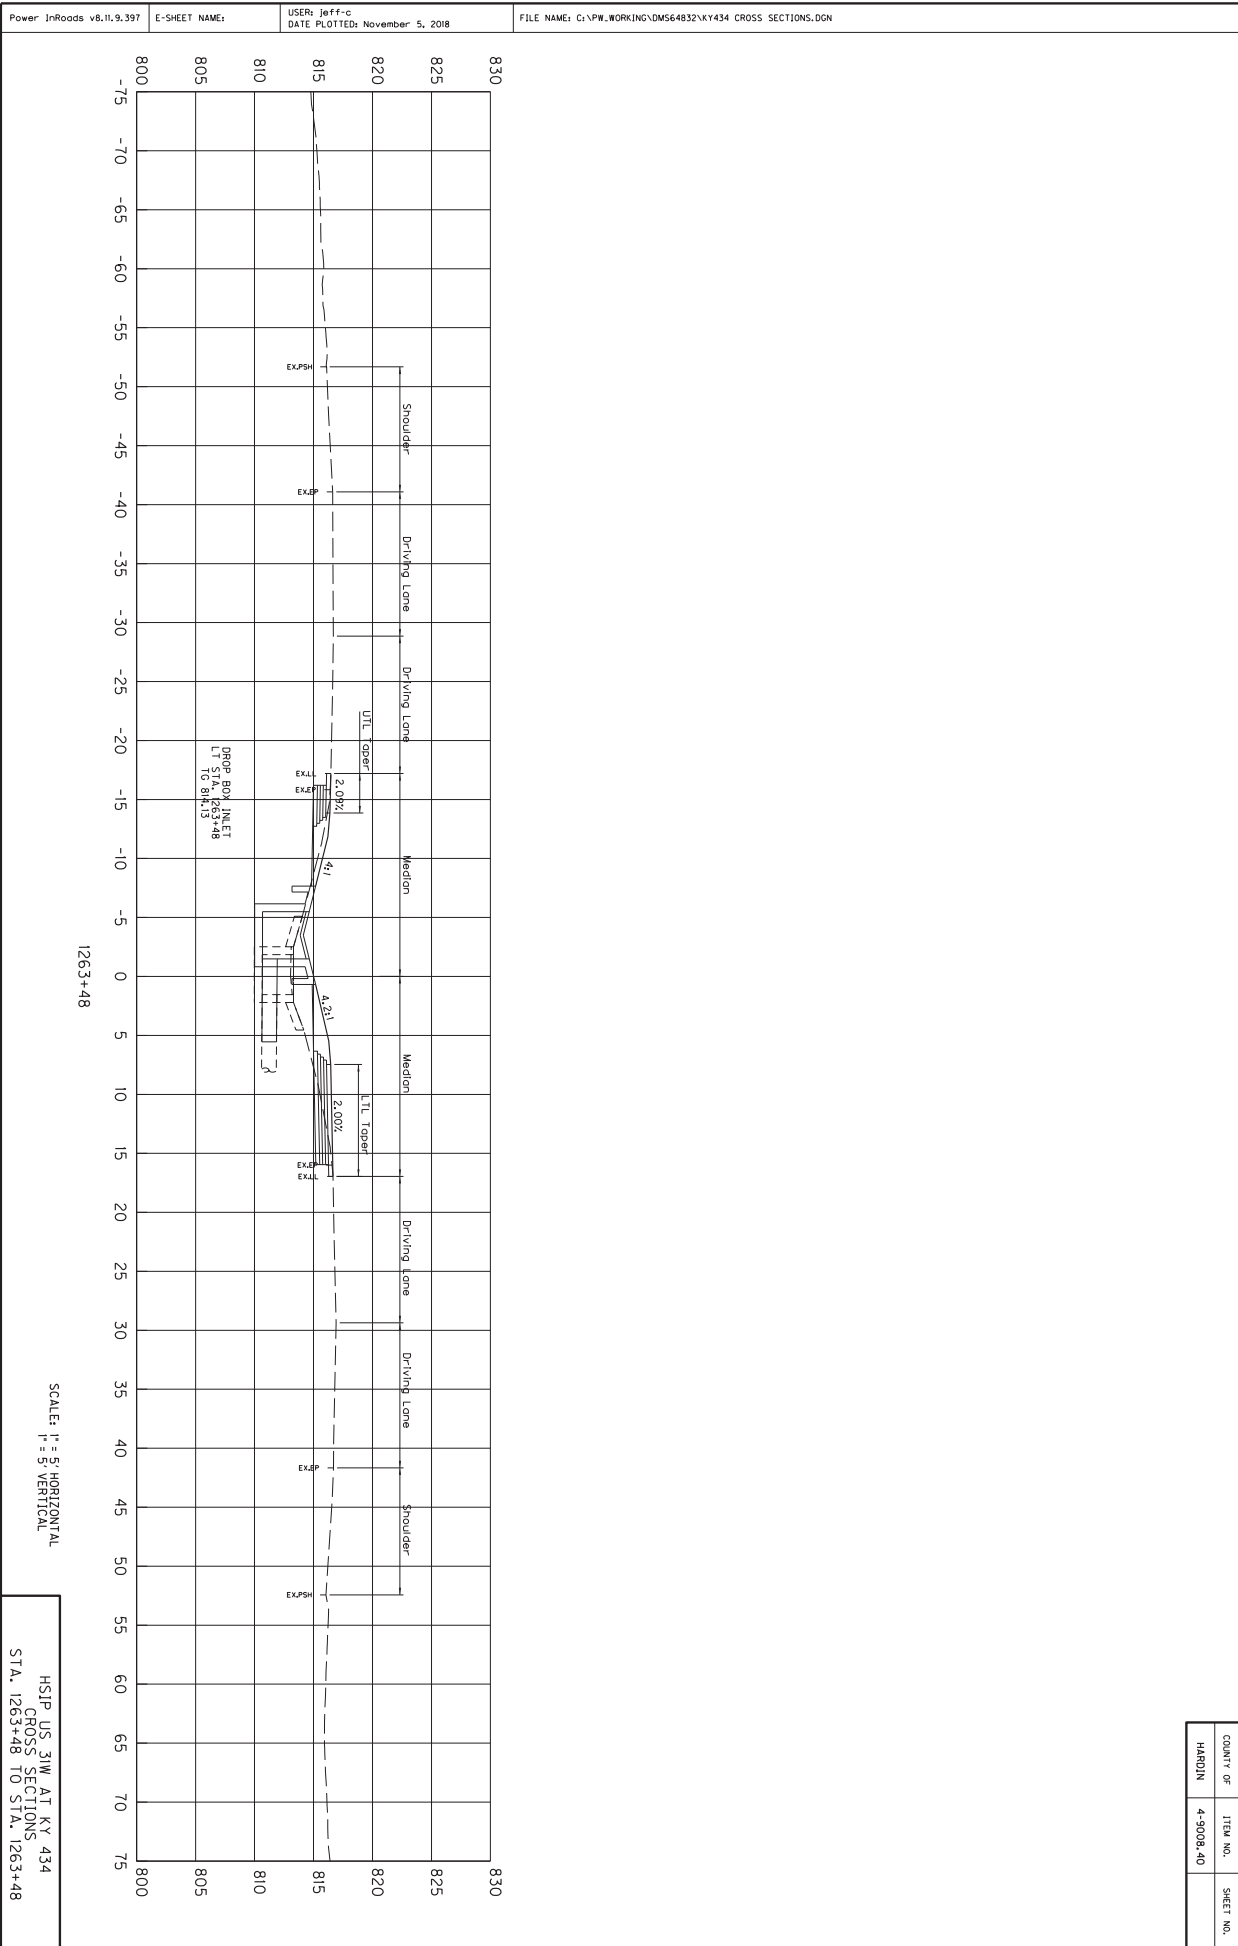


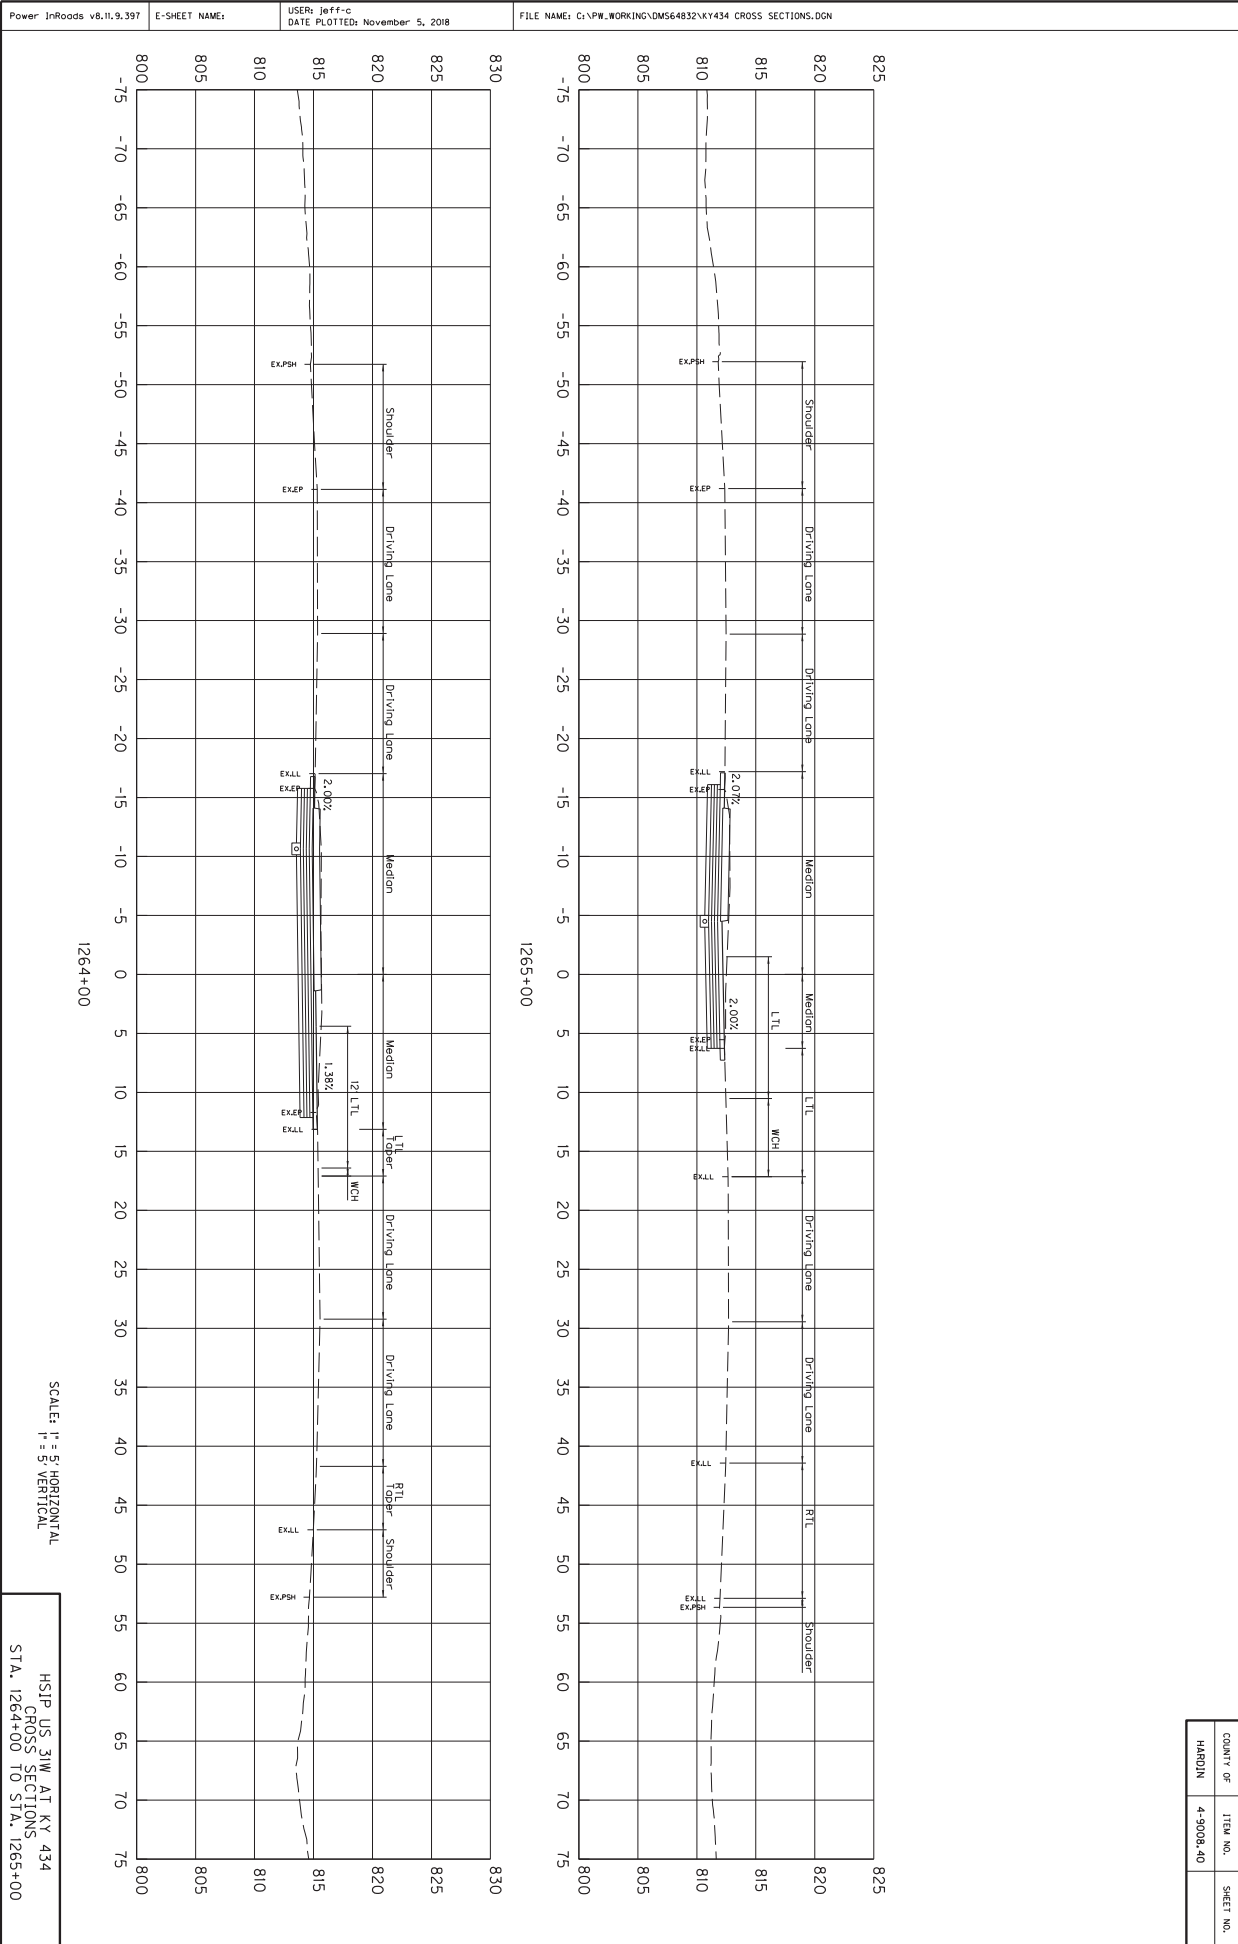


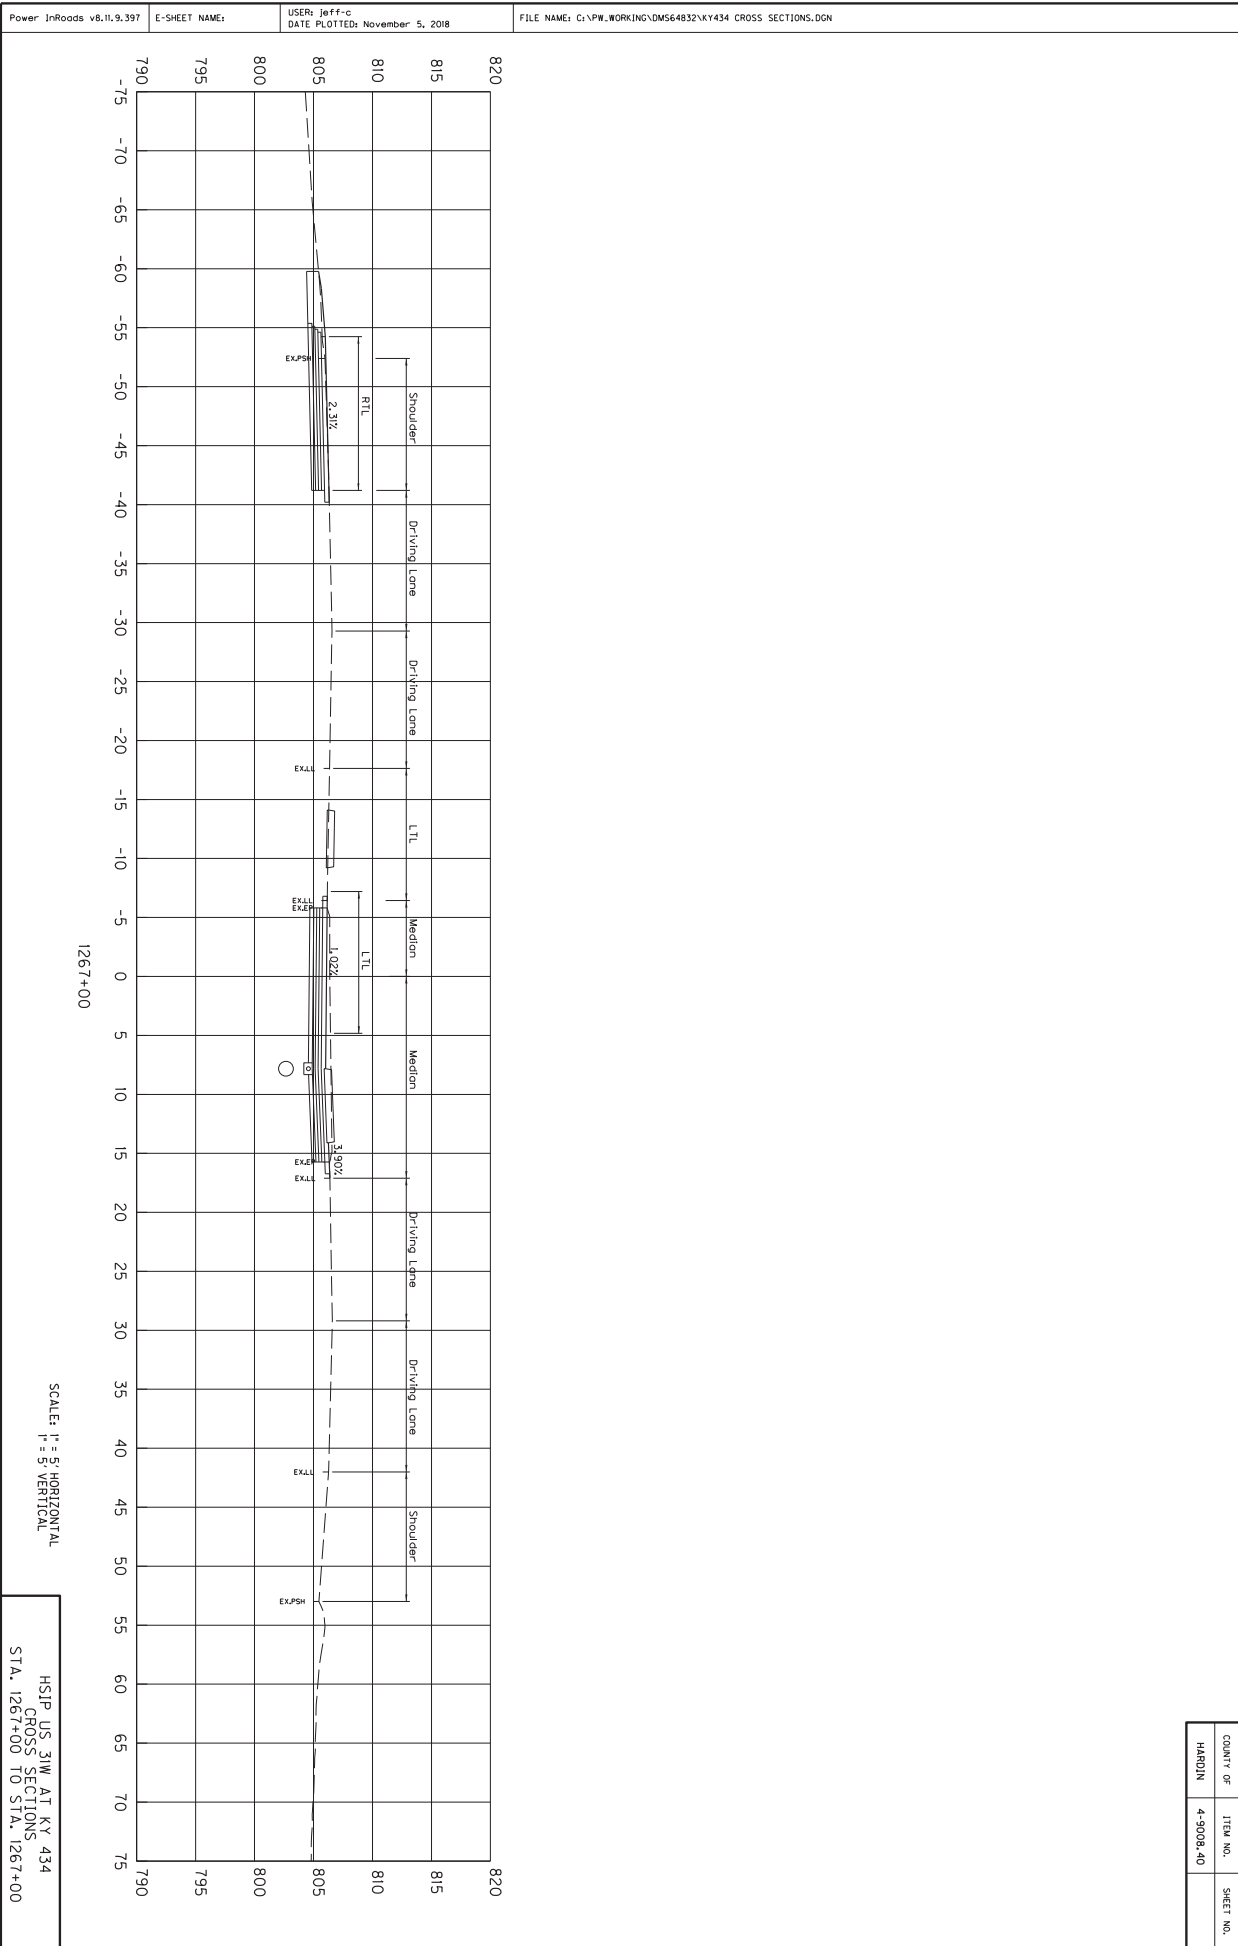


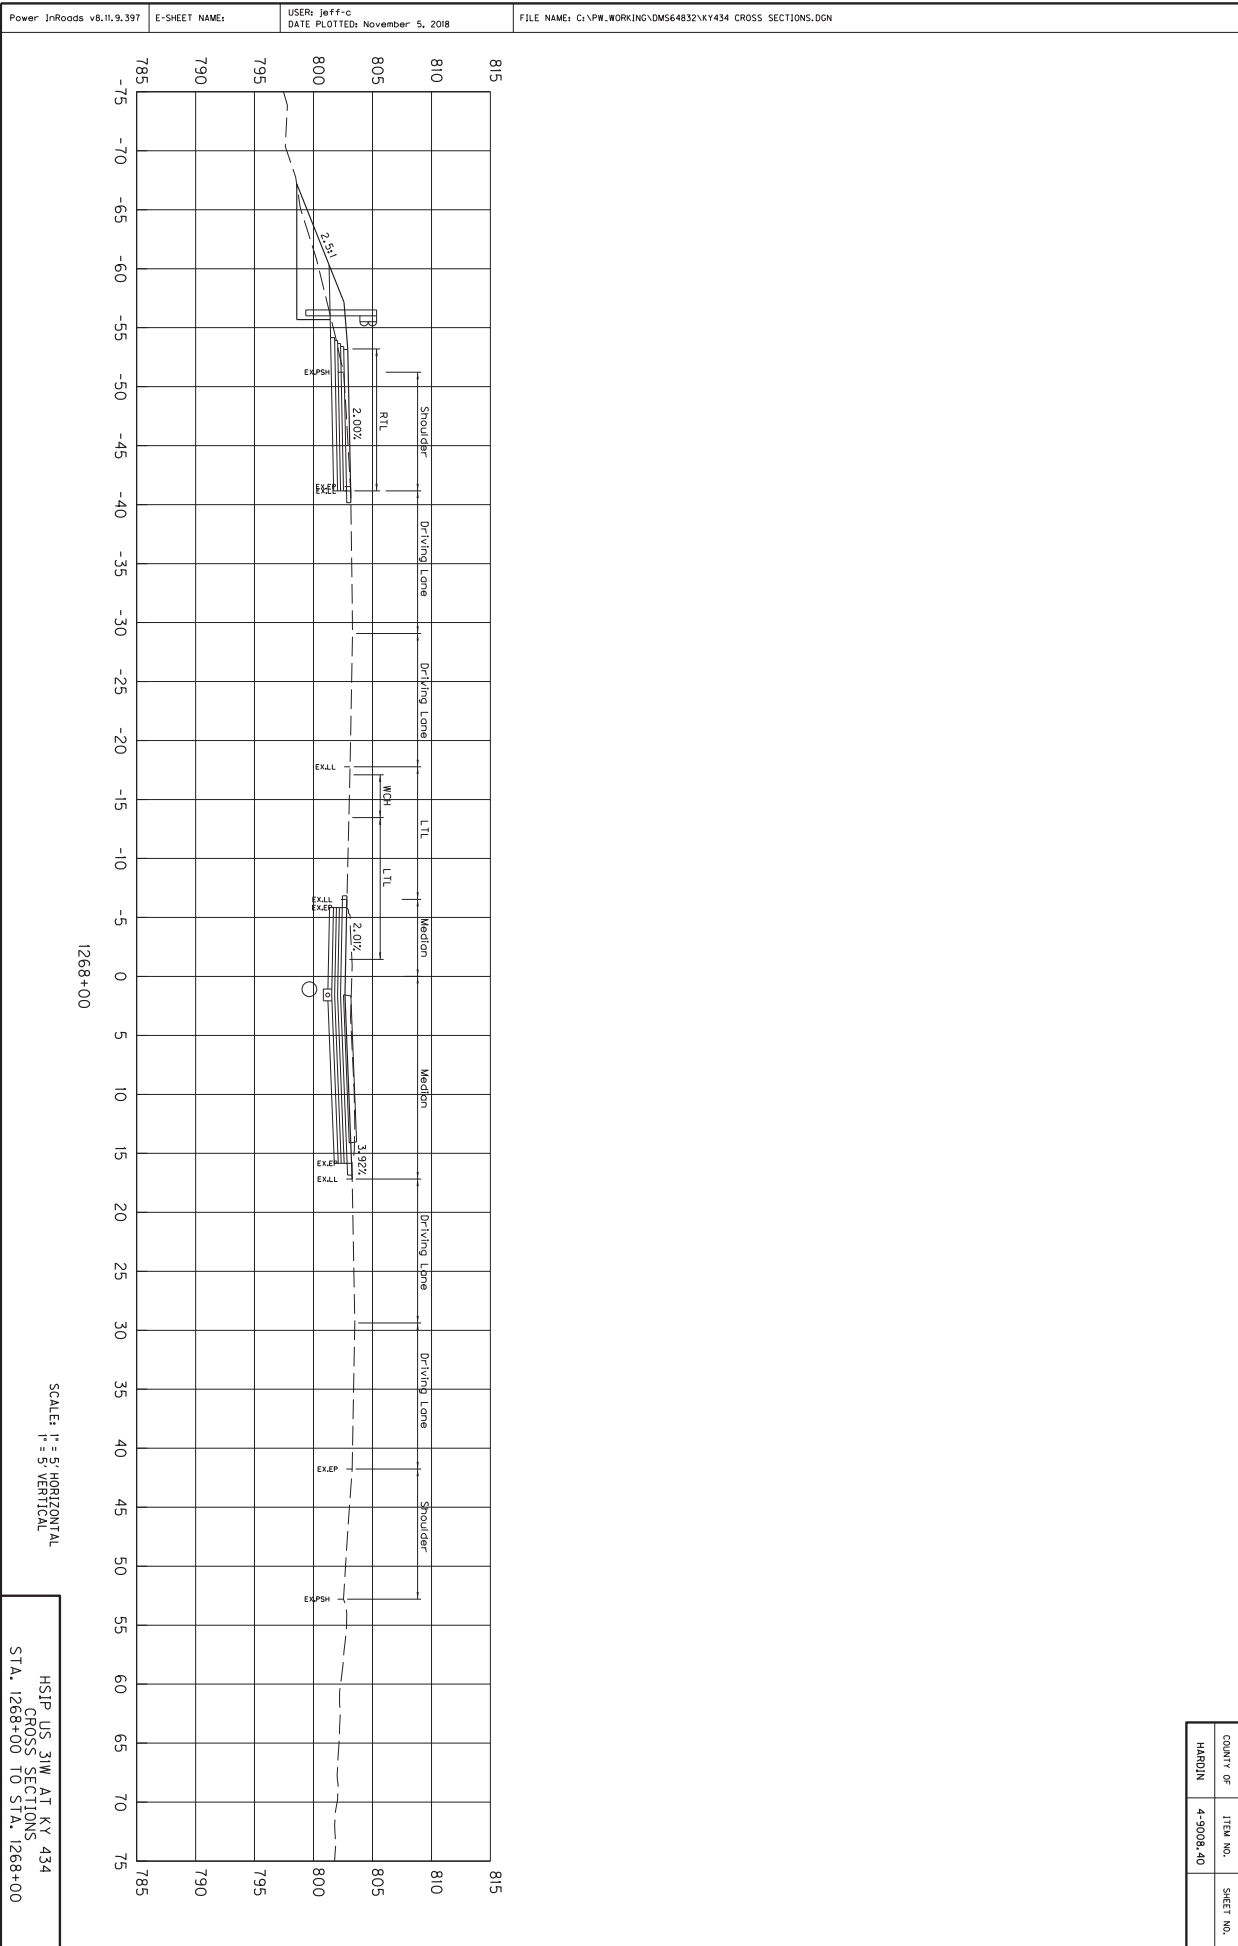


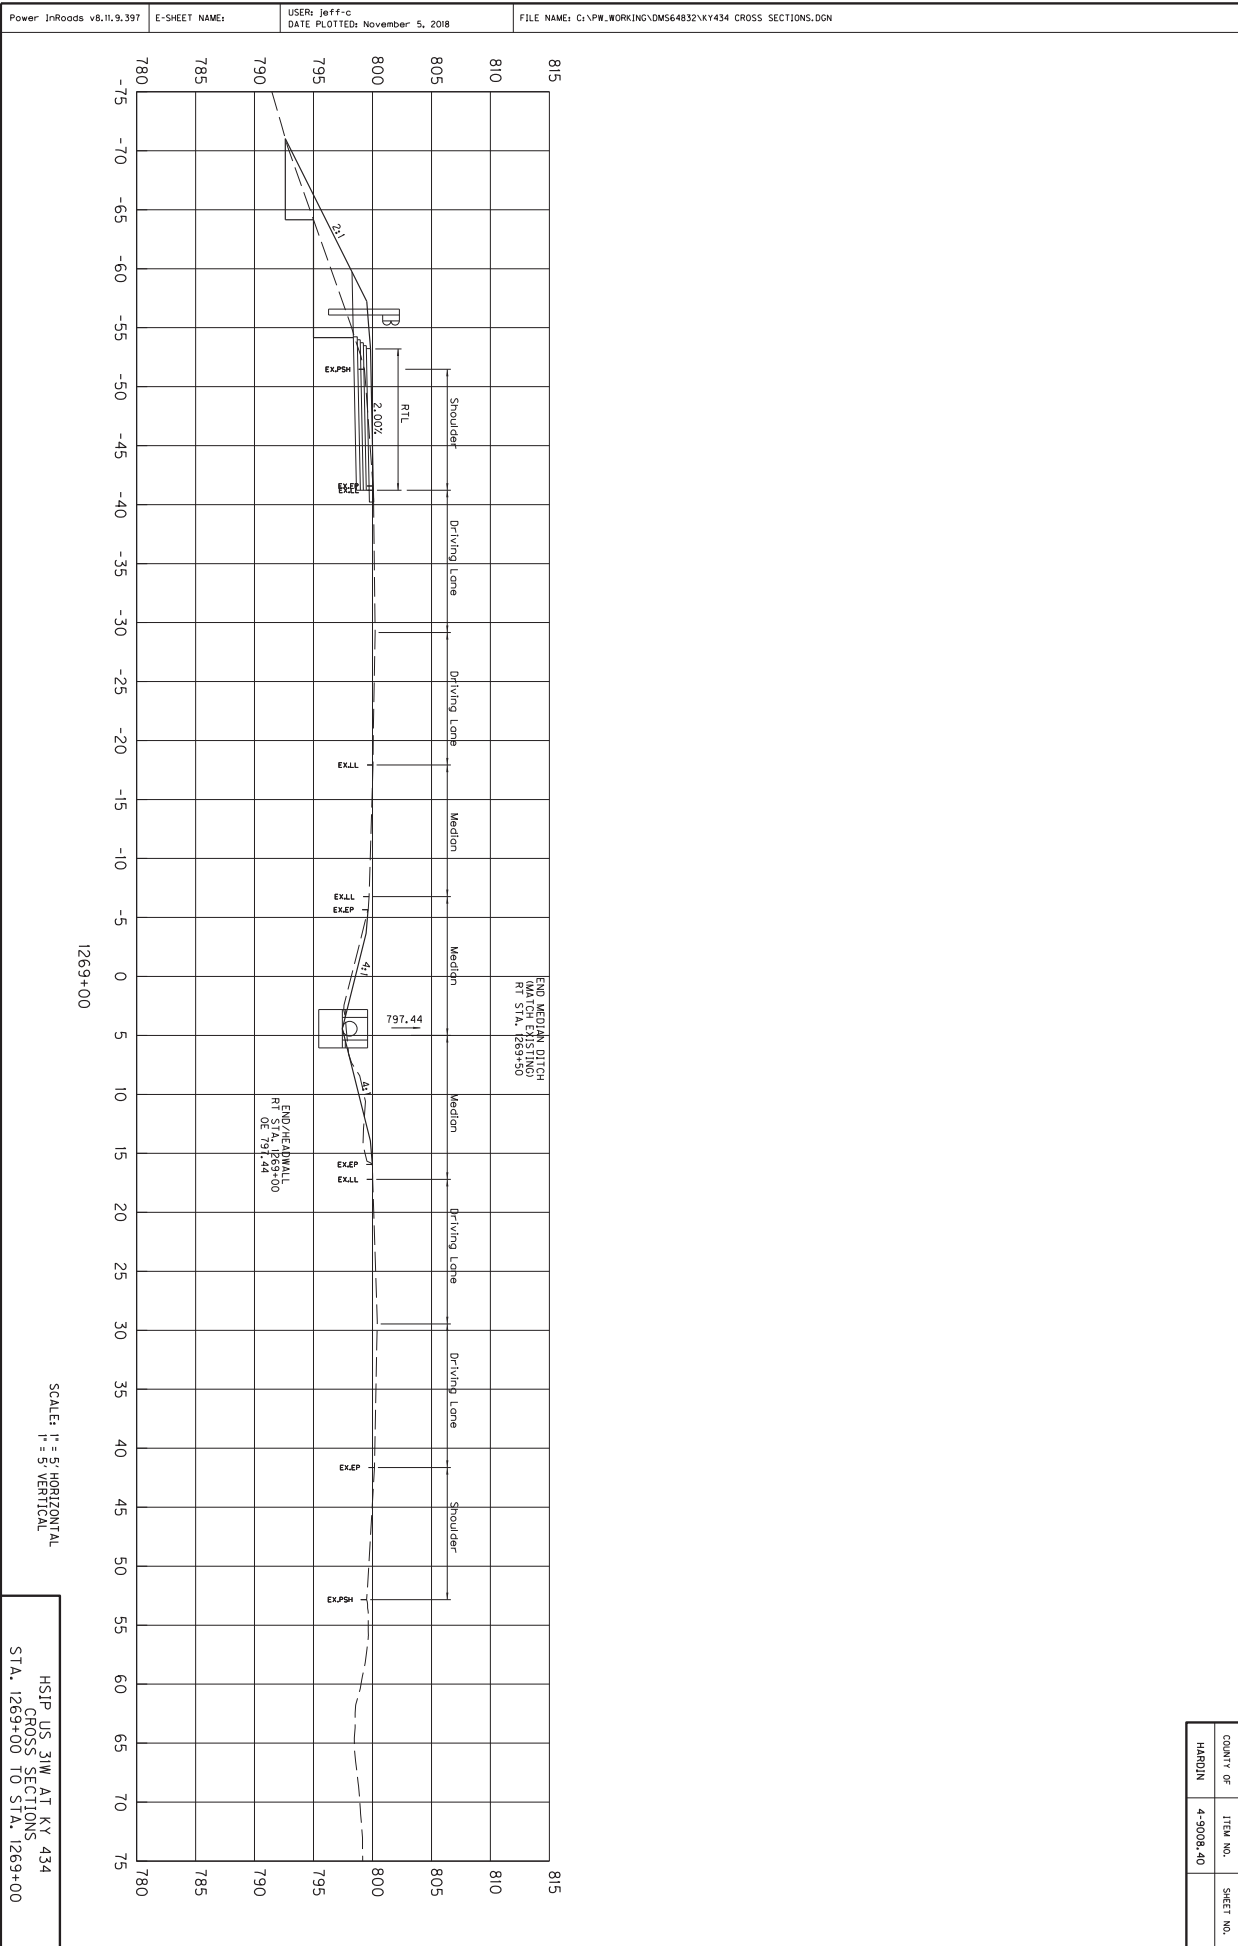


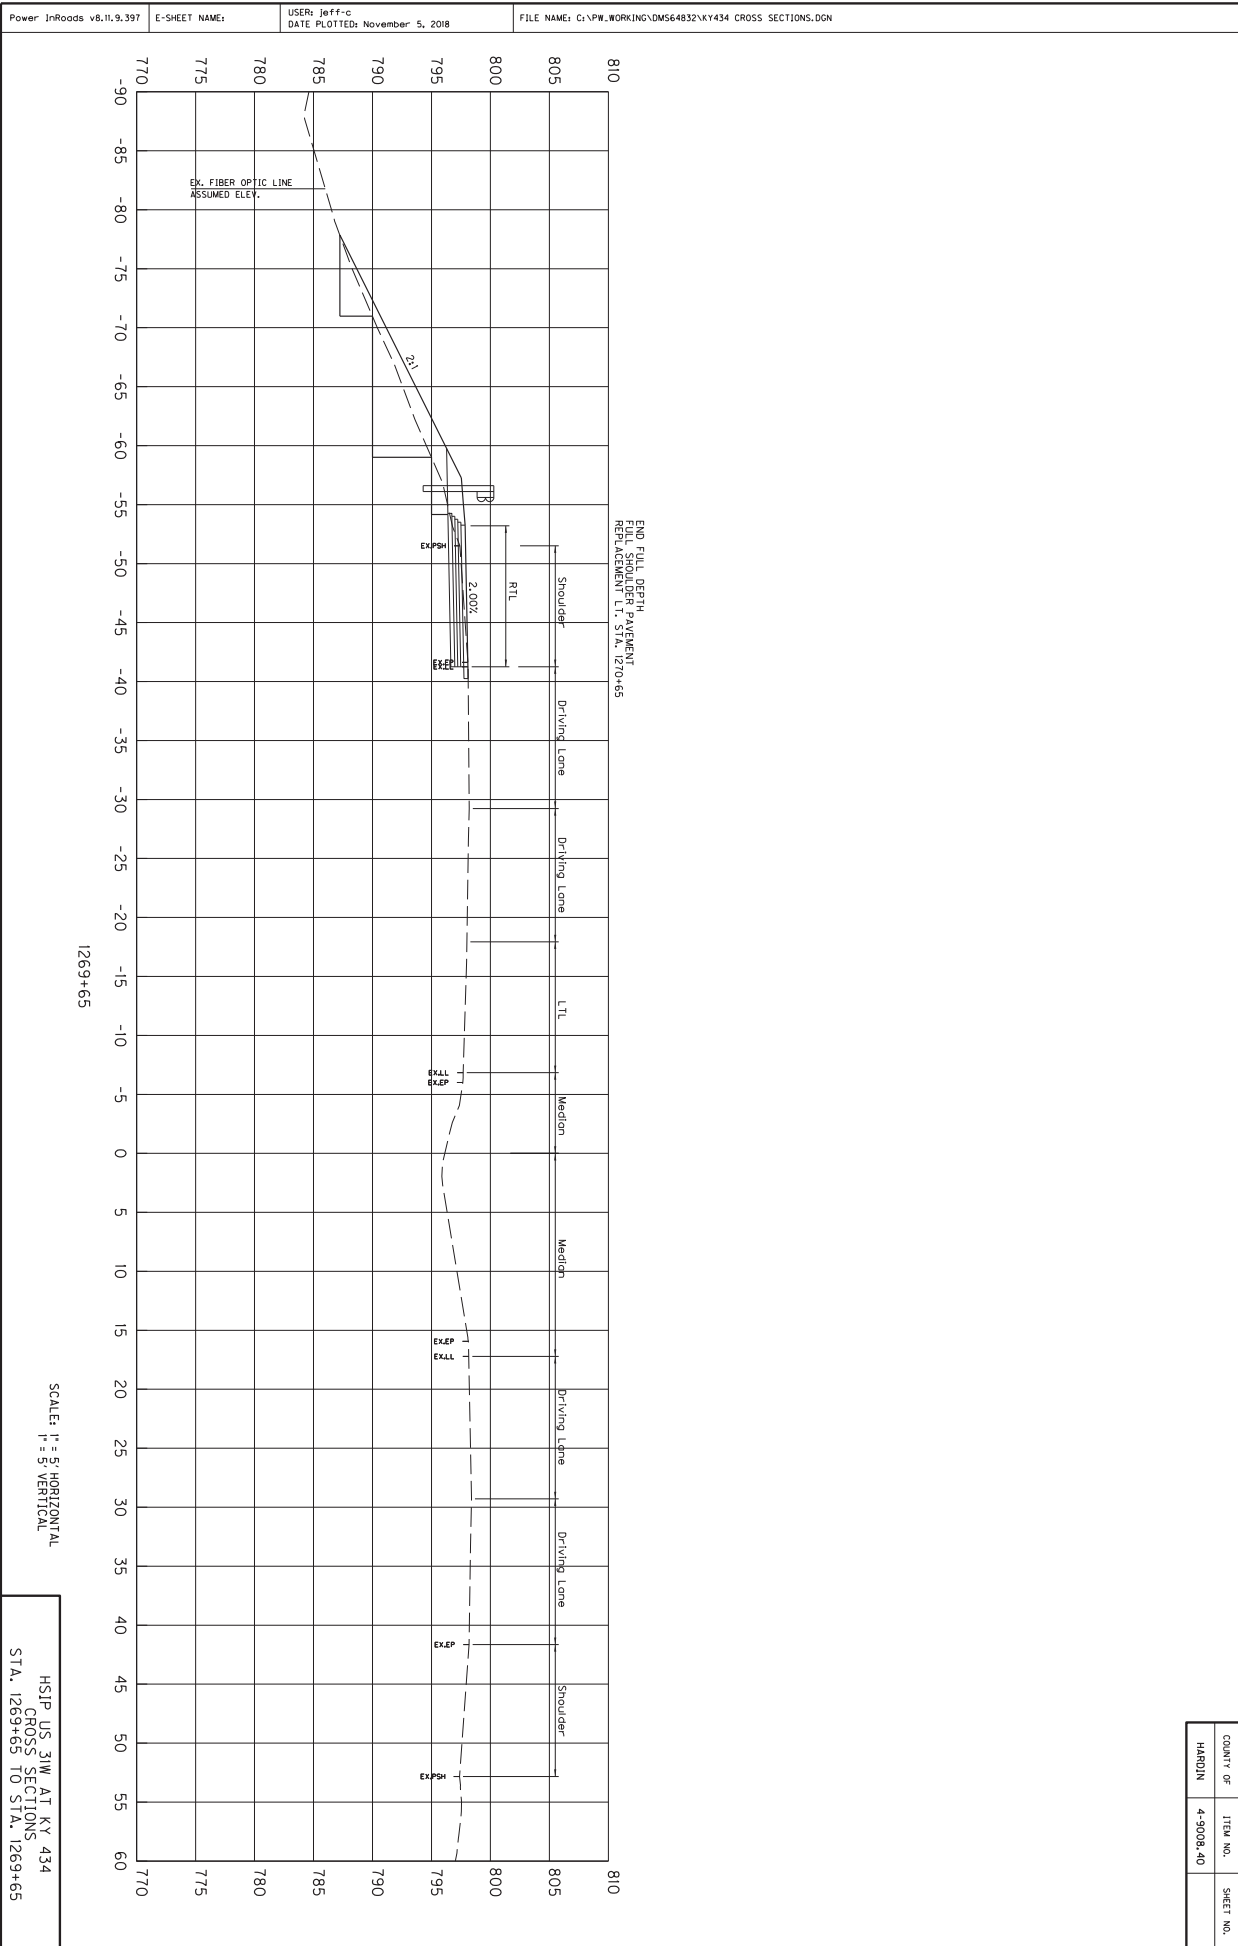

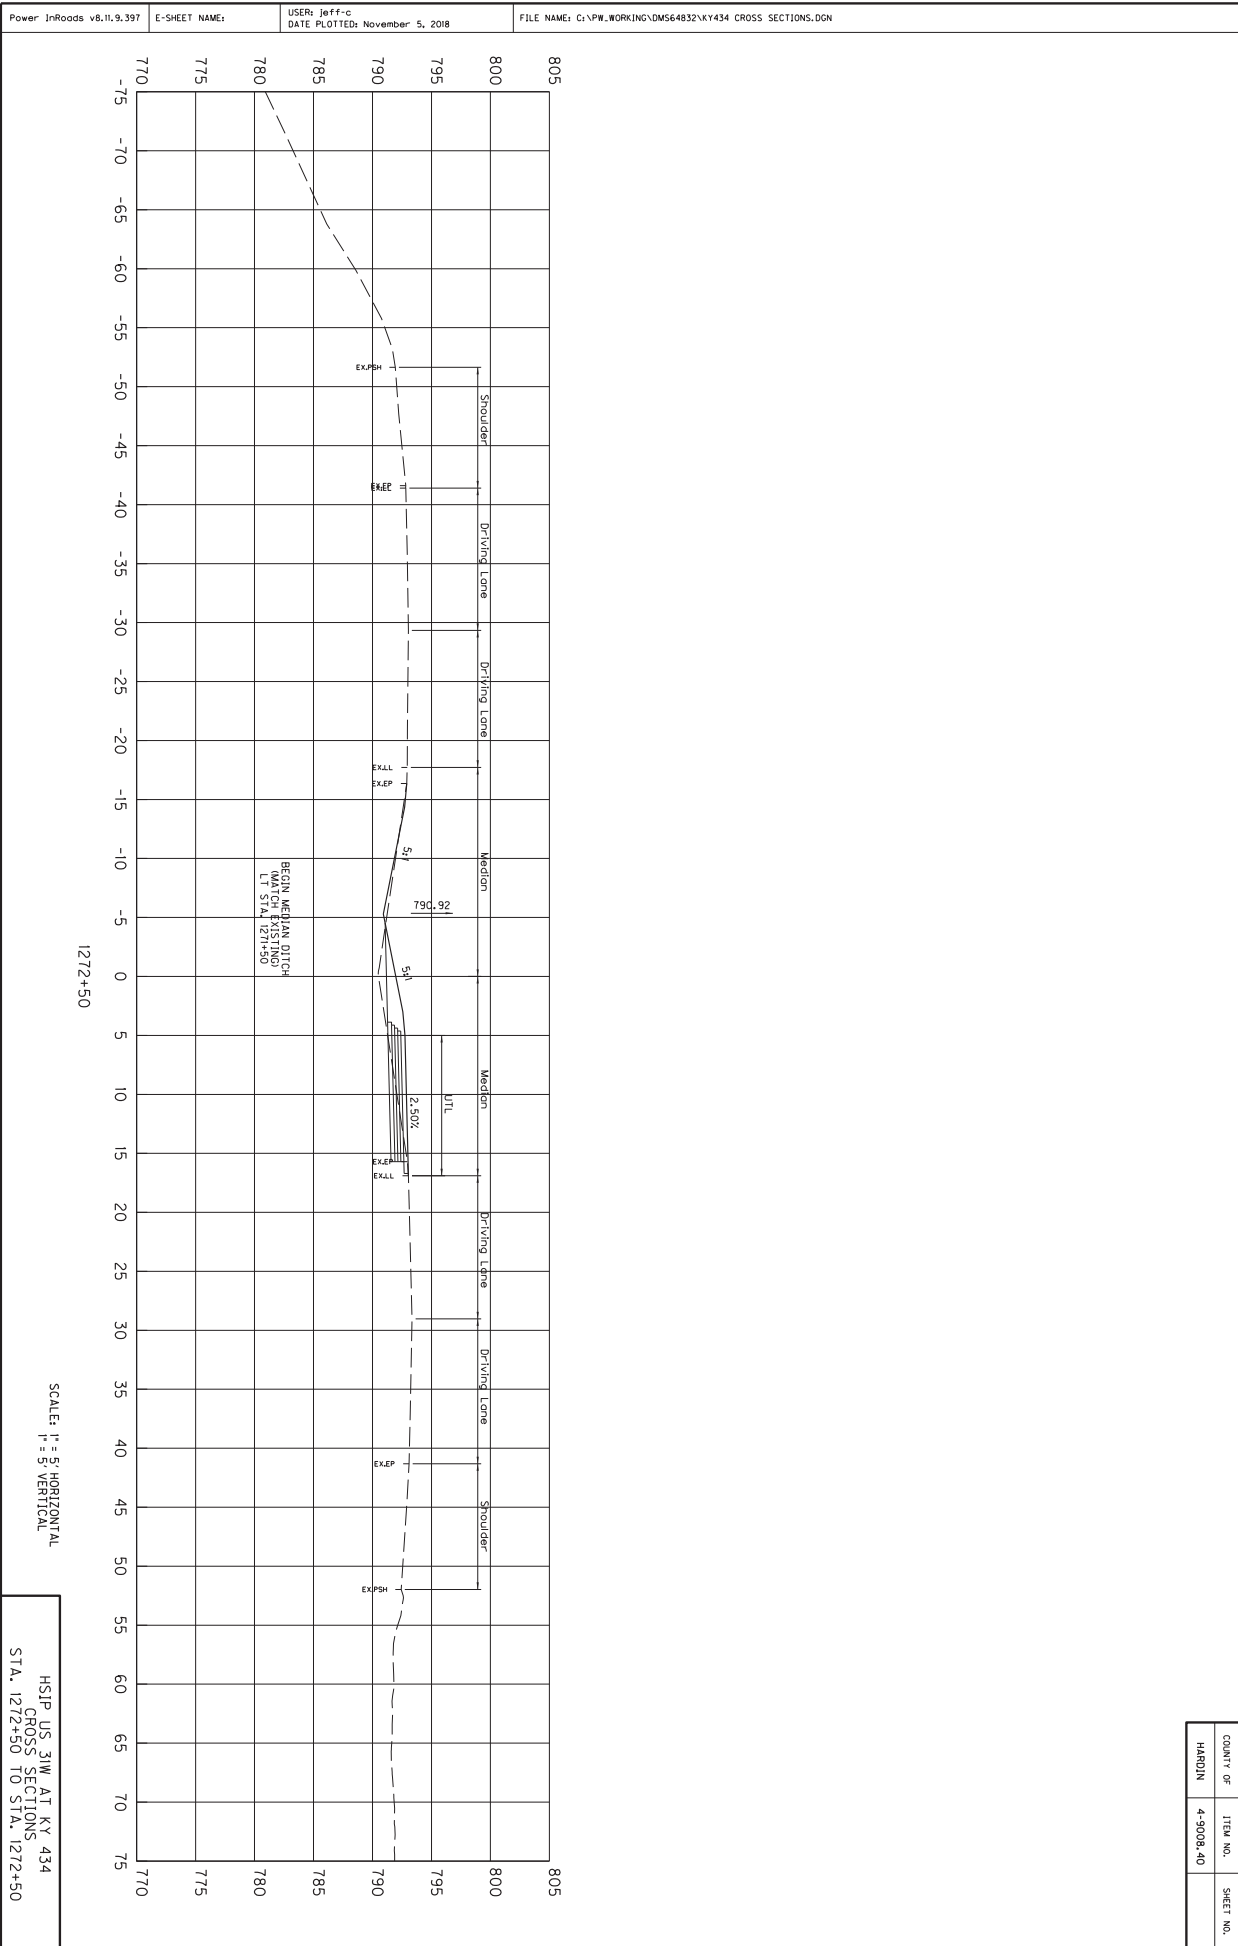


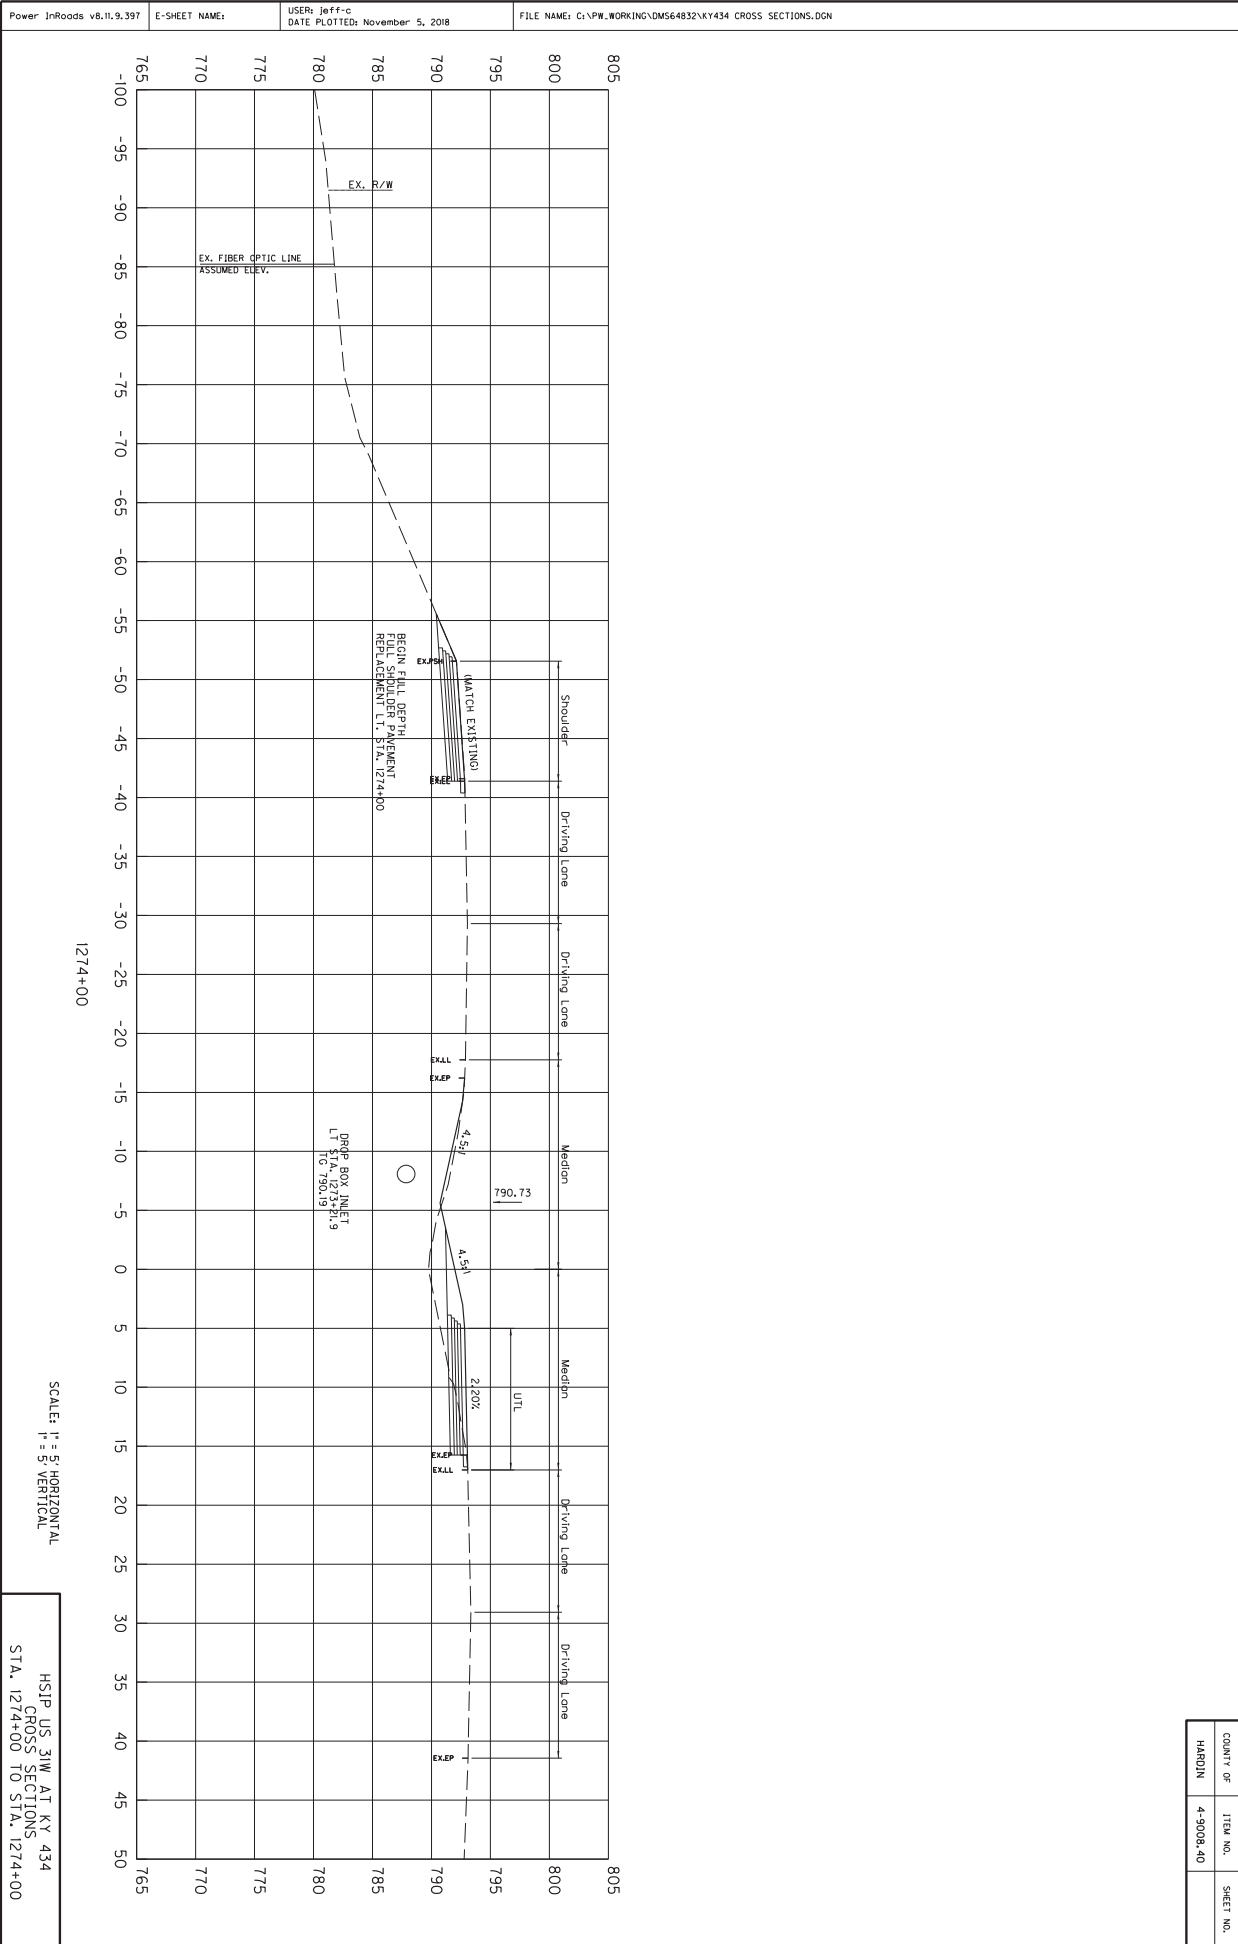

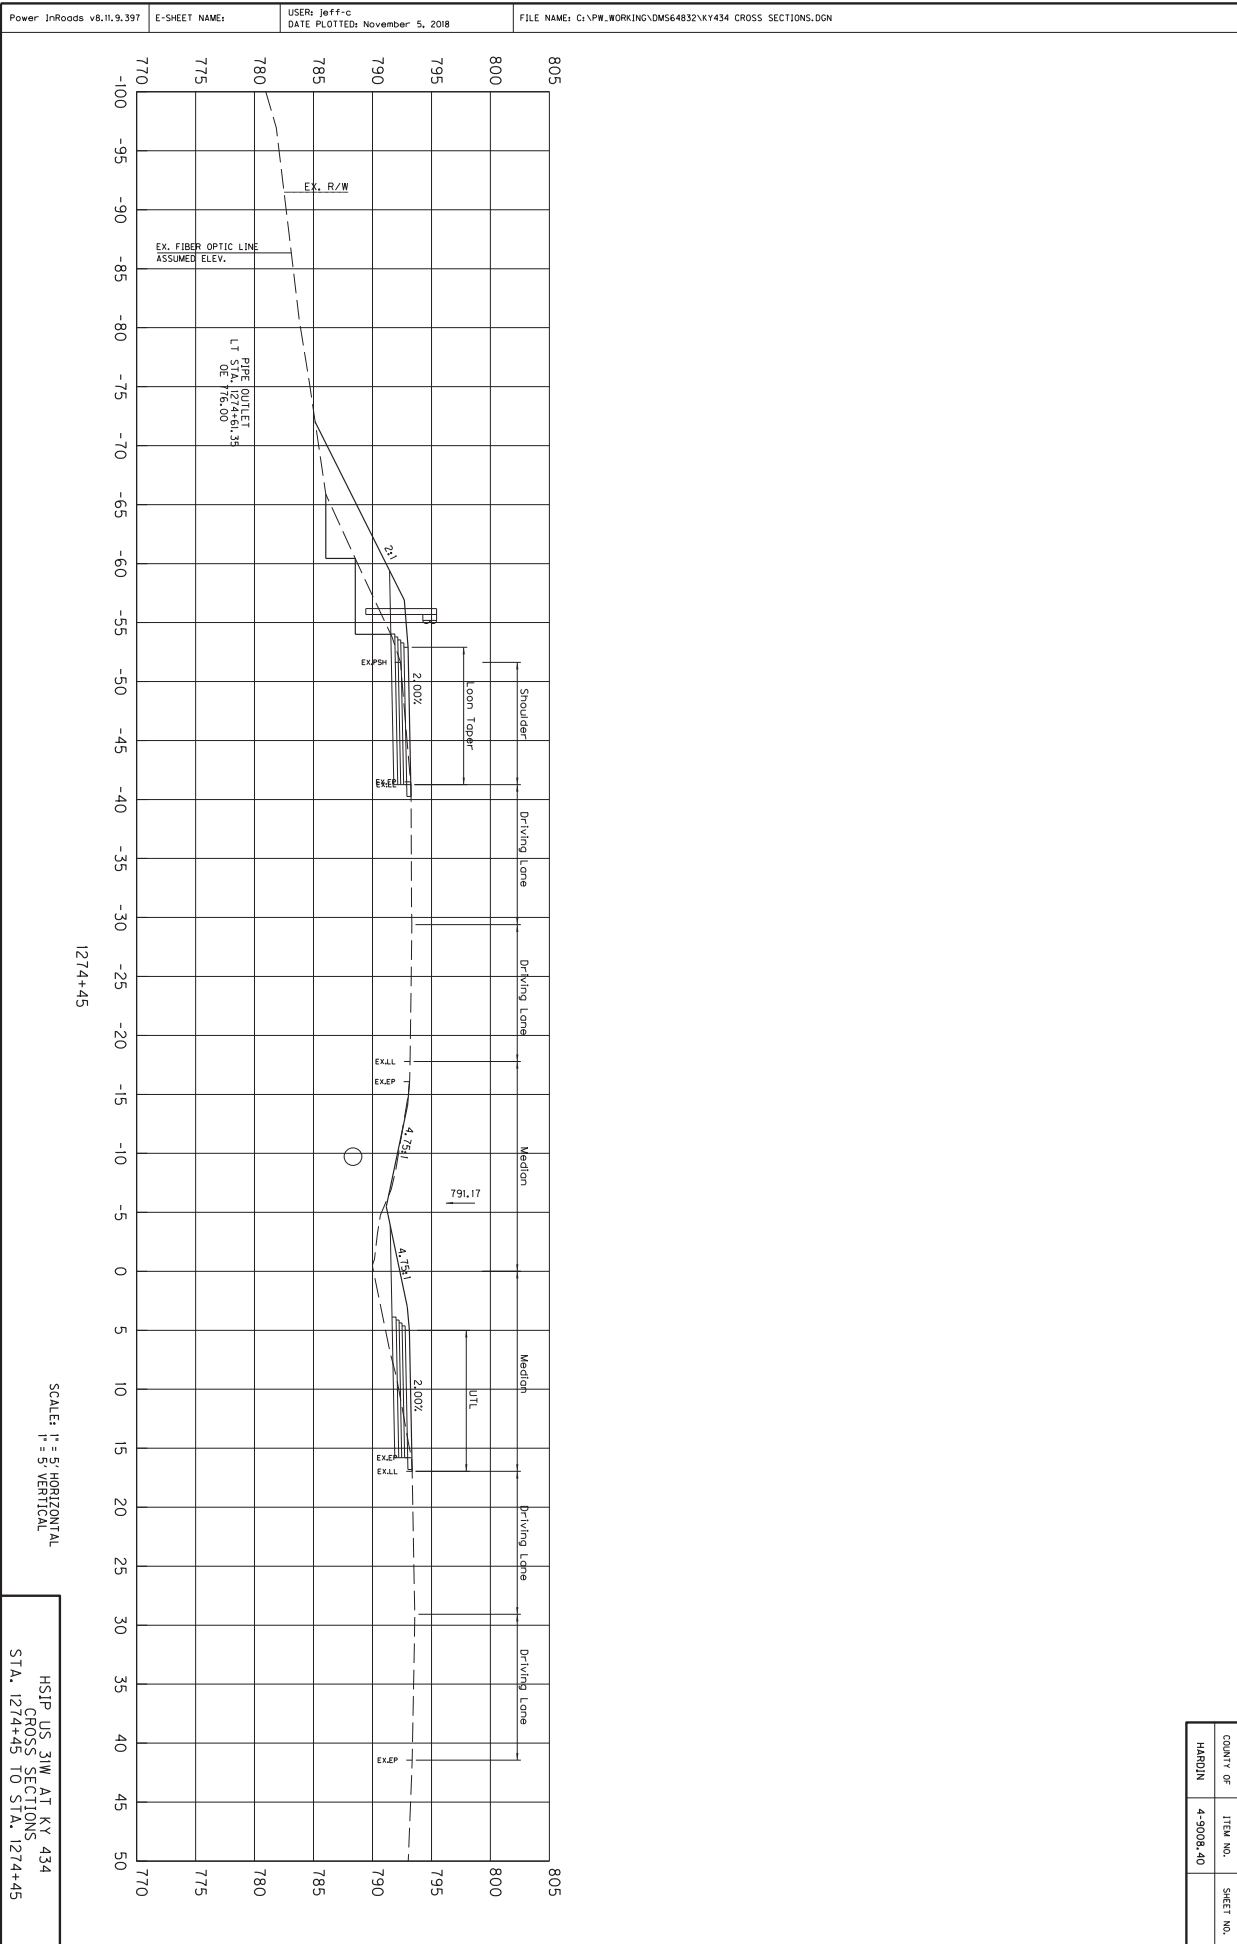

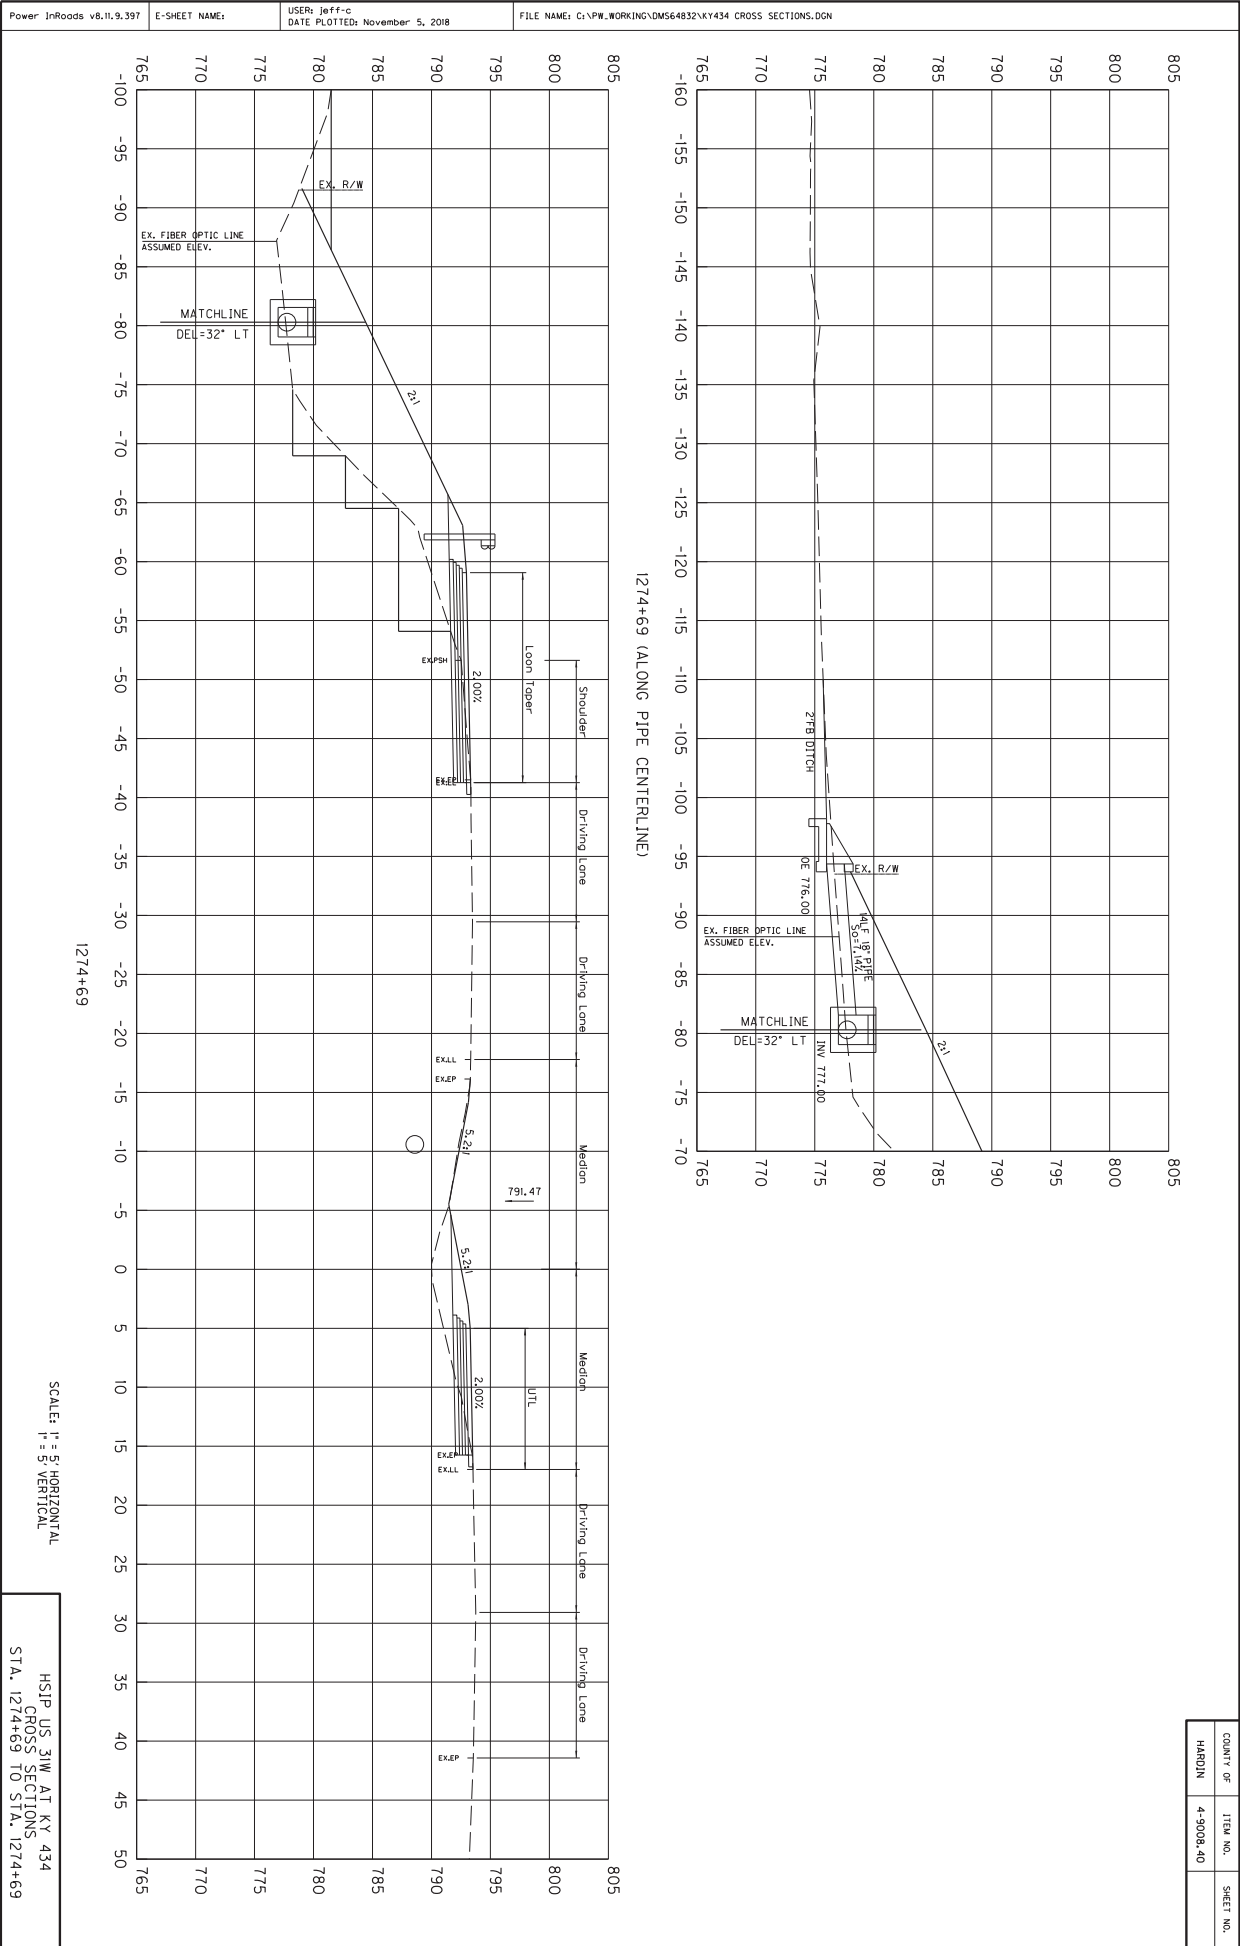


Power InRoads v8.11.9.397 E-SHEET NAME: USER: jeff-c DATE PLOTTED: November 5, 2018 FILE NAME: C:\PW\WORKING\DM564832\KY434 CROSS SECTIONS.DGN

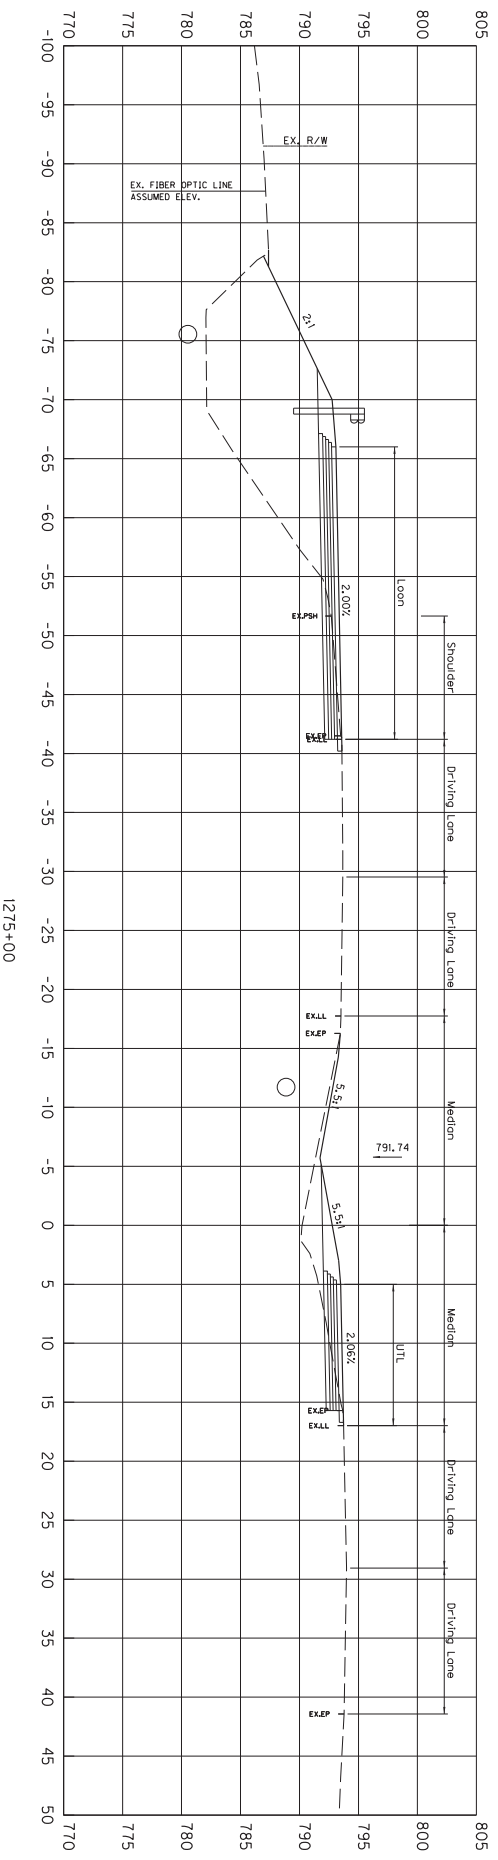


SCALE: H = 5' HORIZONTAL
V = 5' VERTICAL

HSIP US 31W AT KY 434
CROSS SECTIONS
STA. 1275+00 TO STA. 1275+00


COUNTY OF	ITEM NO.	SHEET NO.
HARDIN	4-9008.40	

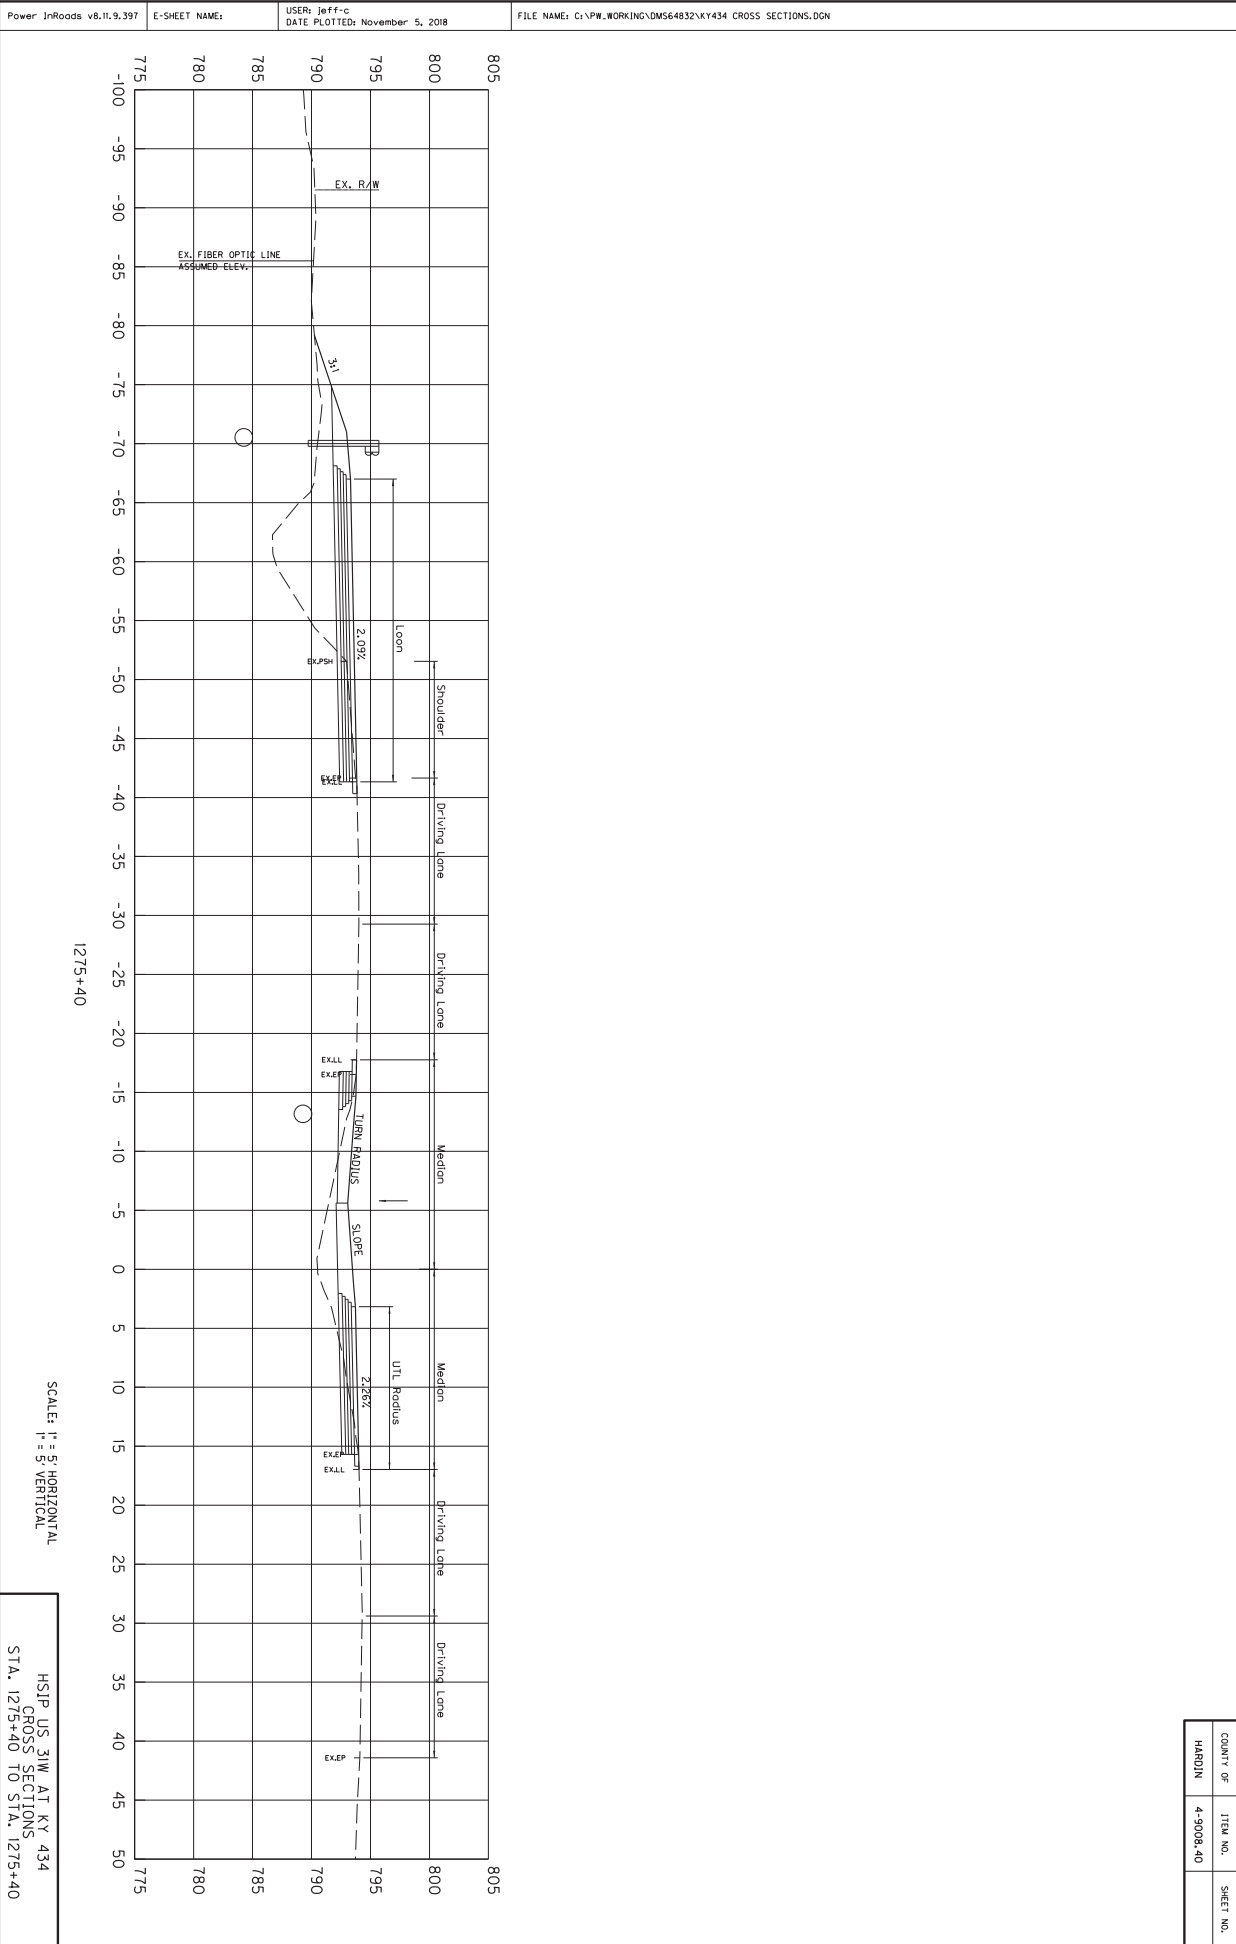


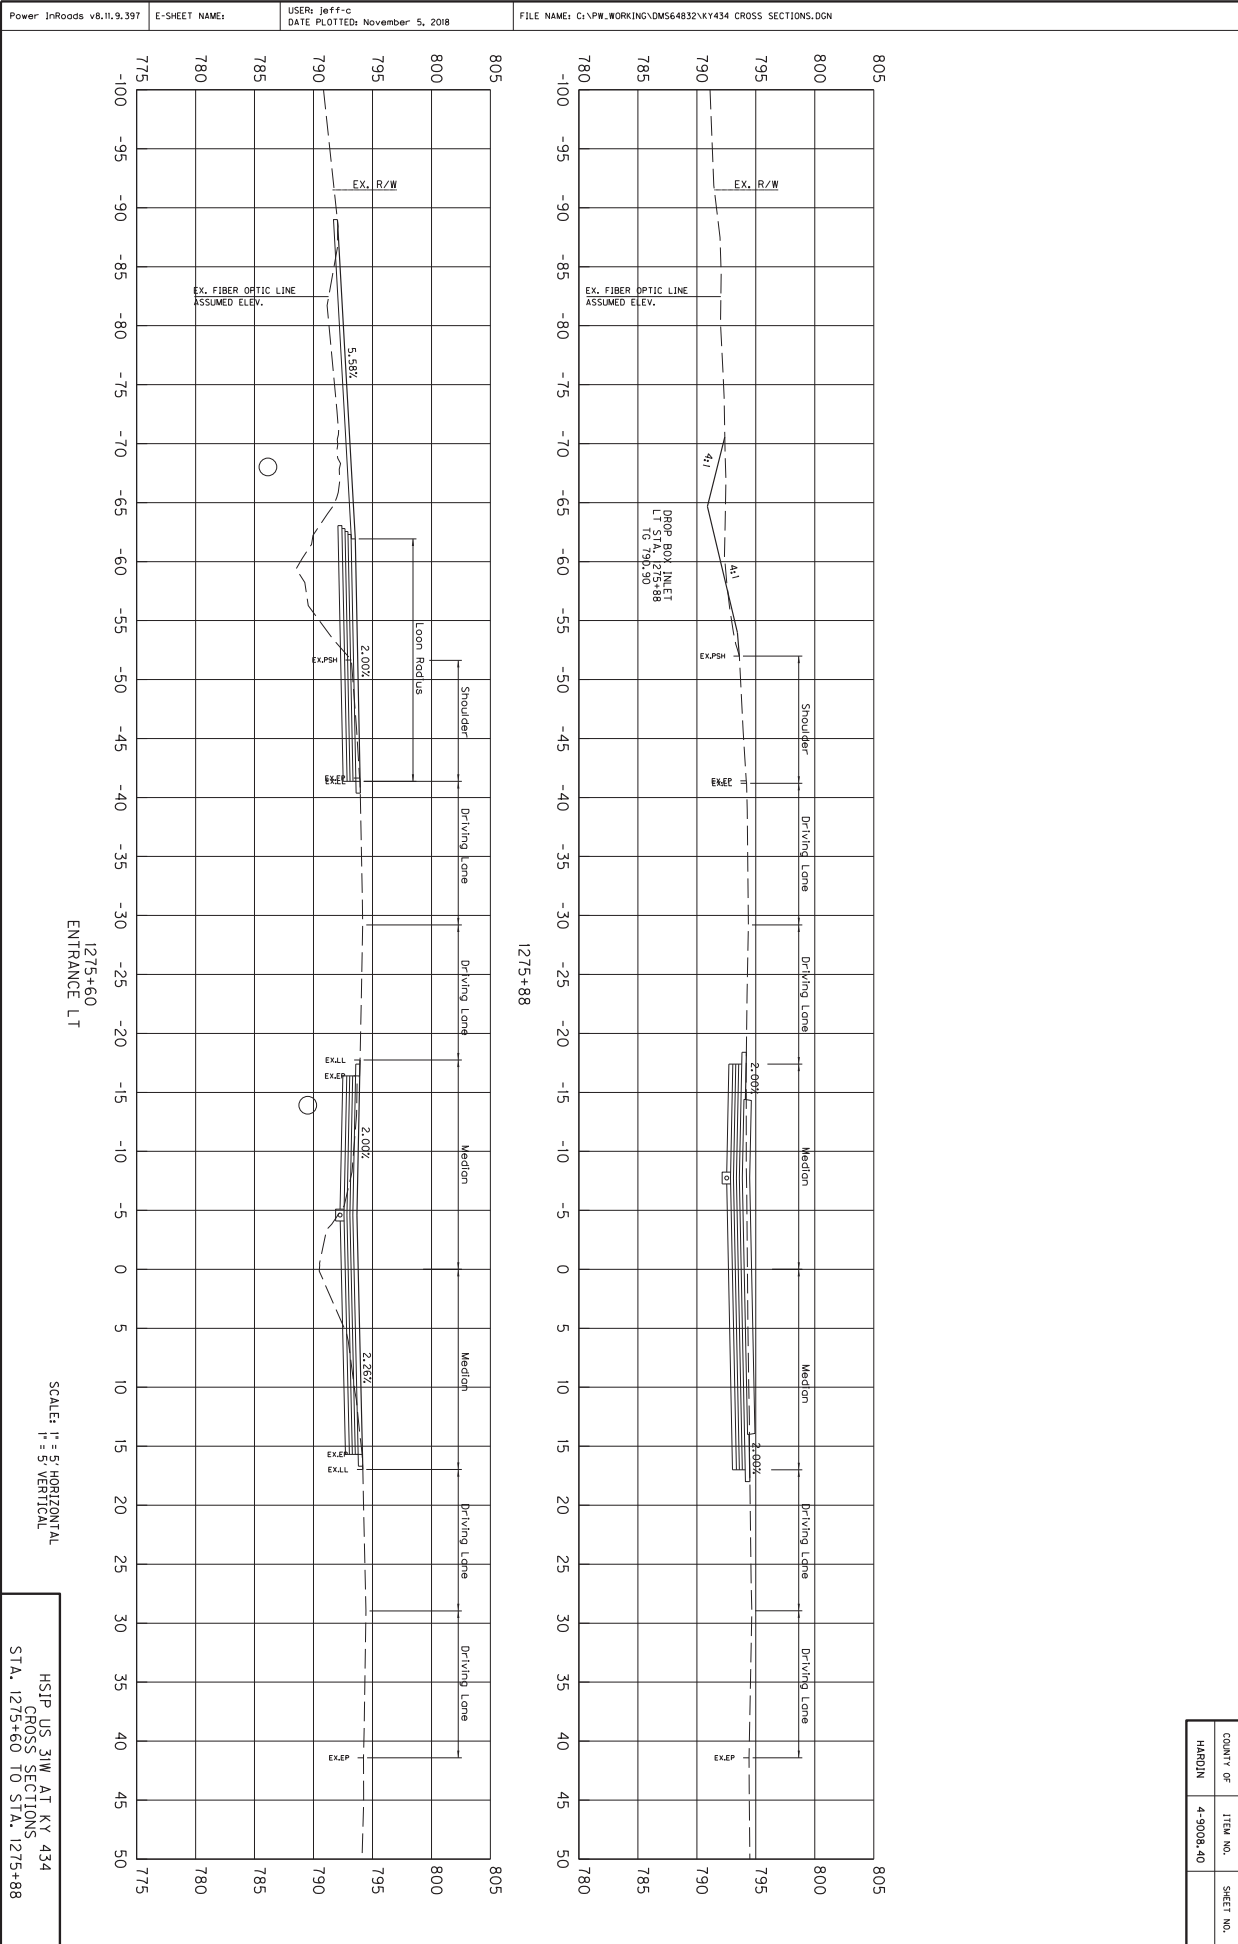

COUNTY OF	ITEM NO.	SHEET NO.
HARDIN	4-9008.40	

Power InRoads v8.11.9.397 E-SHEET NAME: USER: Jeff-C DATE PLOTTED: November 5, 2018 FILE NAME: G:\PW_WORKING\DM564832\KY434 CROSS SECTIONS.DGN

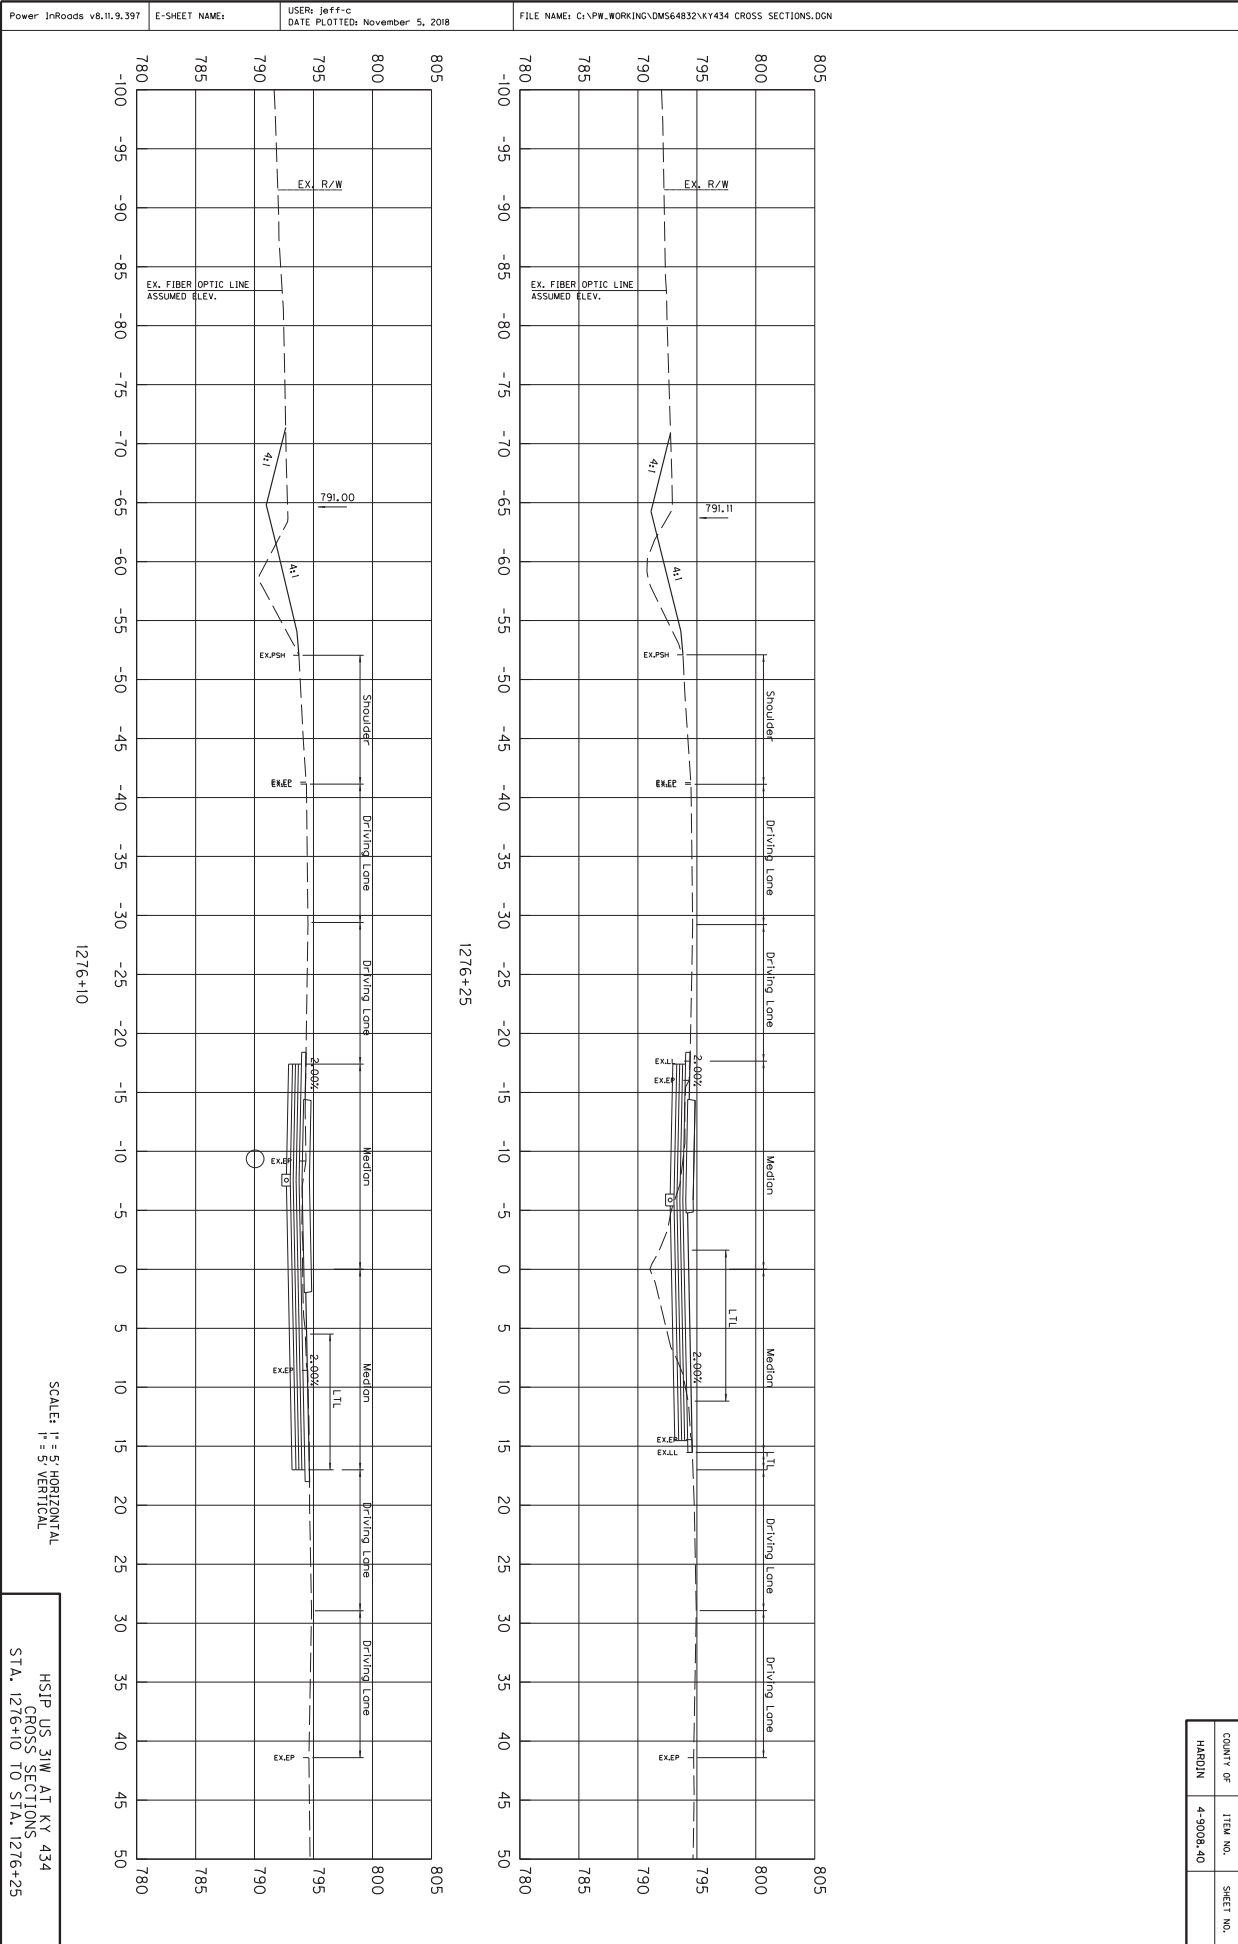


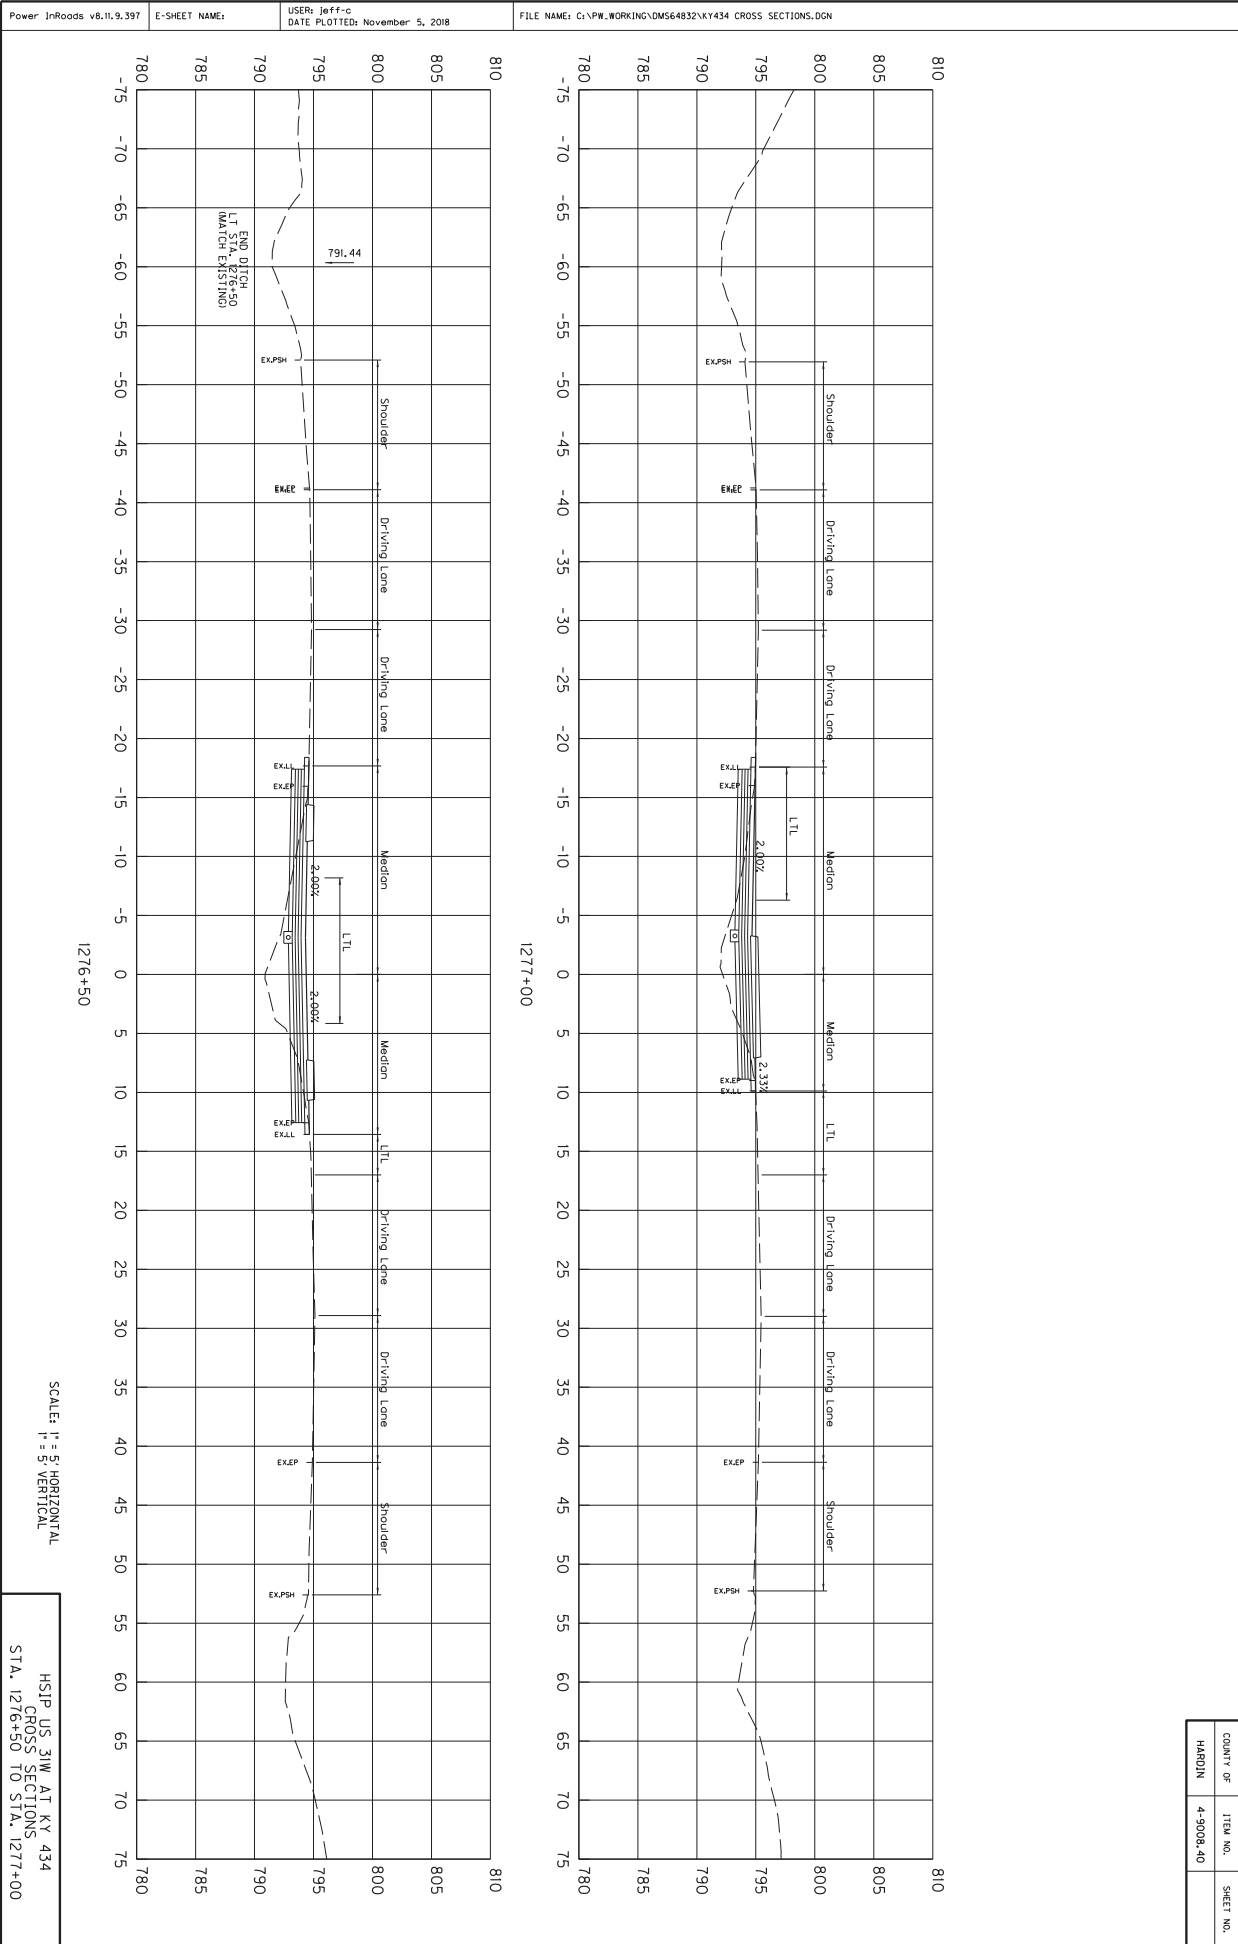

SCALE: H = 5' HORIZONTAL
V = 5' VERTICAL

HSIP US 31W AT KY 434
CROSS SECTIONS
STA. 1276+50 TO STA. 1277+00


COUNTY OF	ITEM NO.	SHEET NO.
HARDIN	4-9008.40	

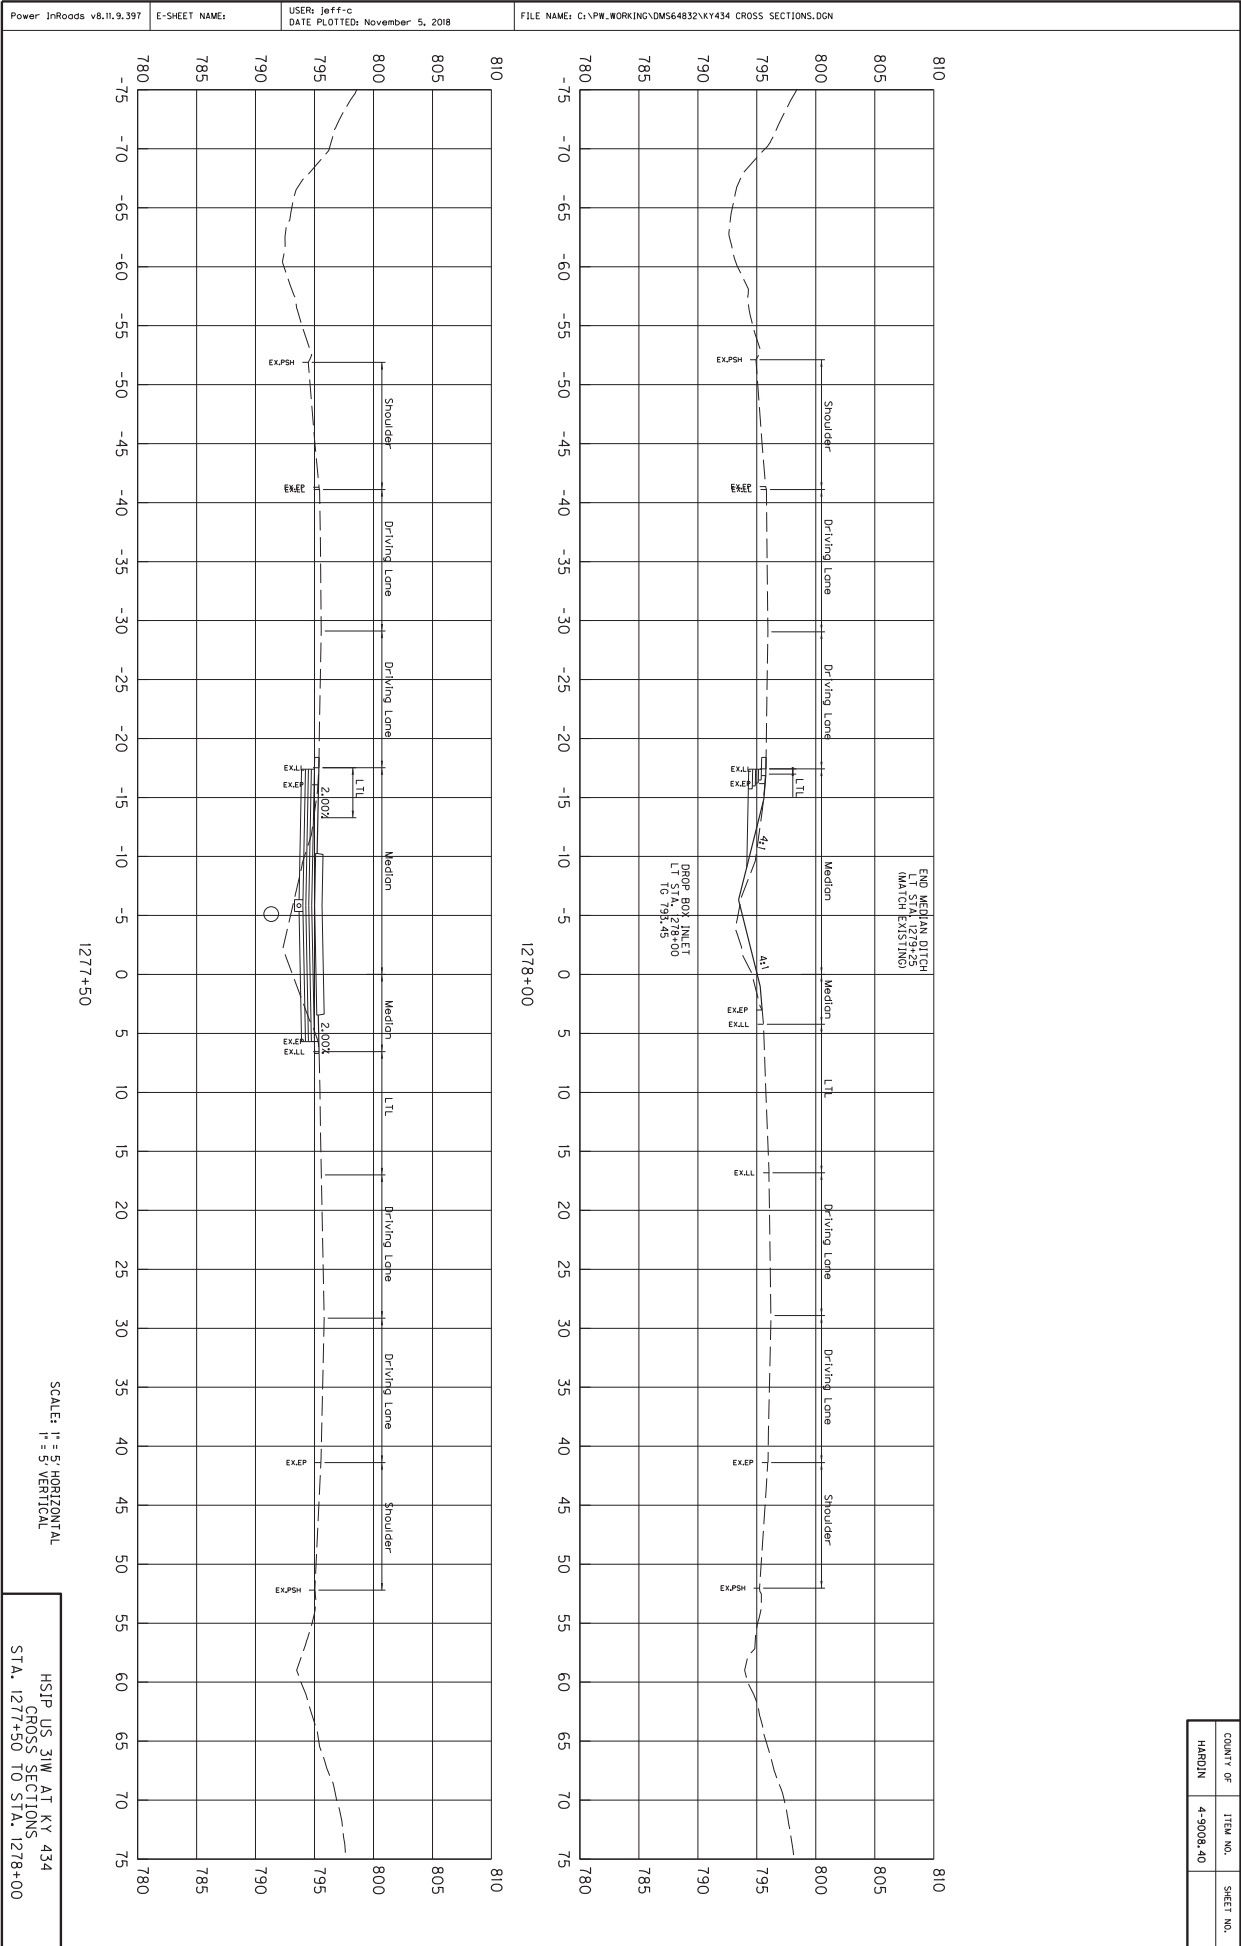


SCALE: H = 5' HORIZONTAL
V = 5' VERTICAL

HSIP US 31W AT KY 434
CROSS SECTIONS
STA. 1277+50 TO STA. 1278+00




Power InRoads v8.11.9.397 E-SHEET NAME: USER: jeff-c DATE PLOTTED: November 5, 2018 FILE NAME: G:\PW_WORKING\DM564832\KY434 CROSS SECTIONS.DGN

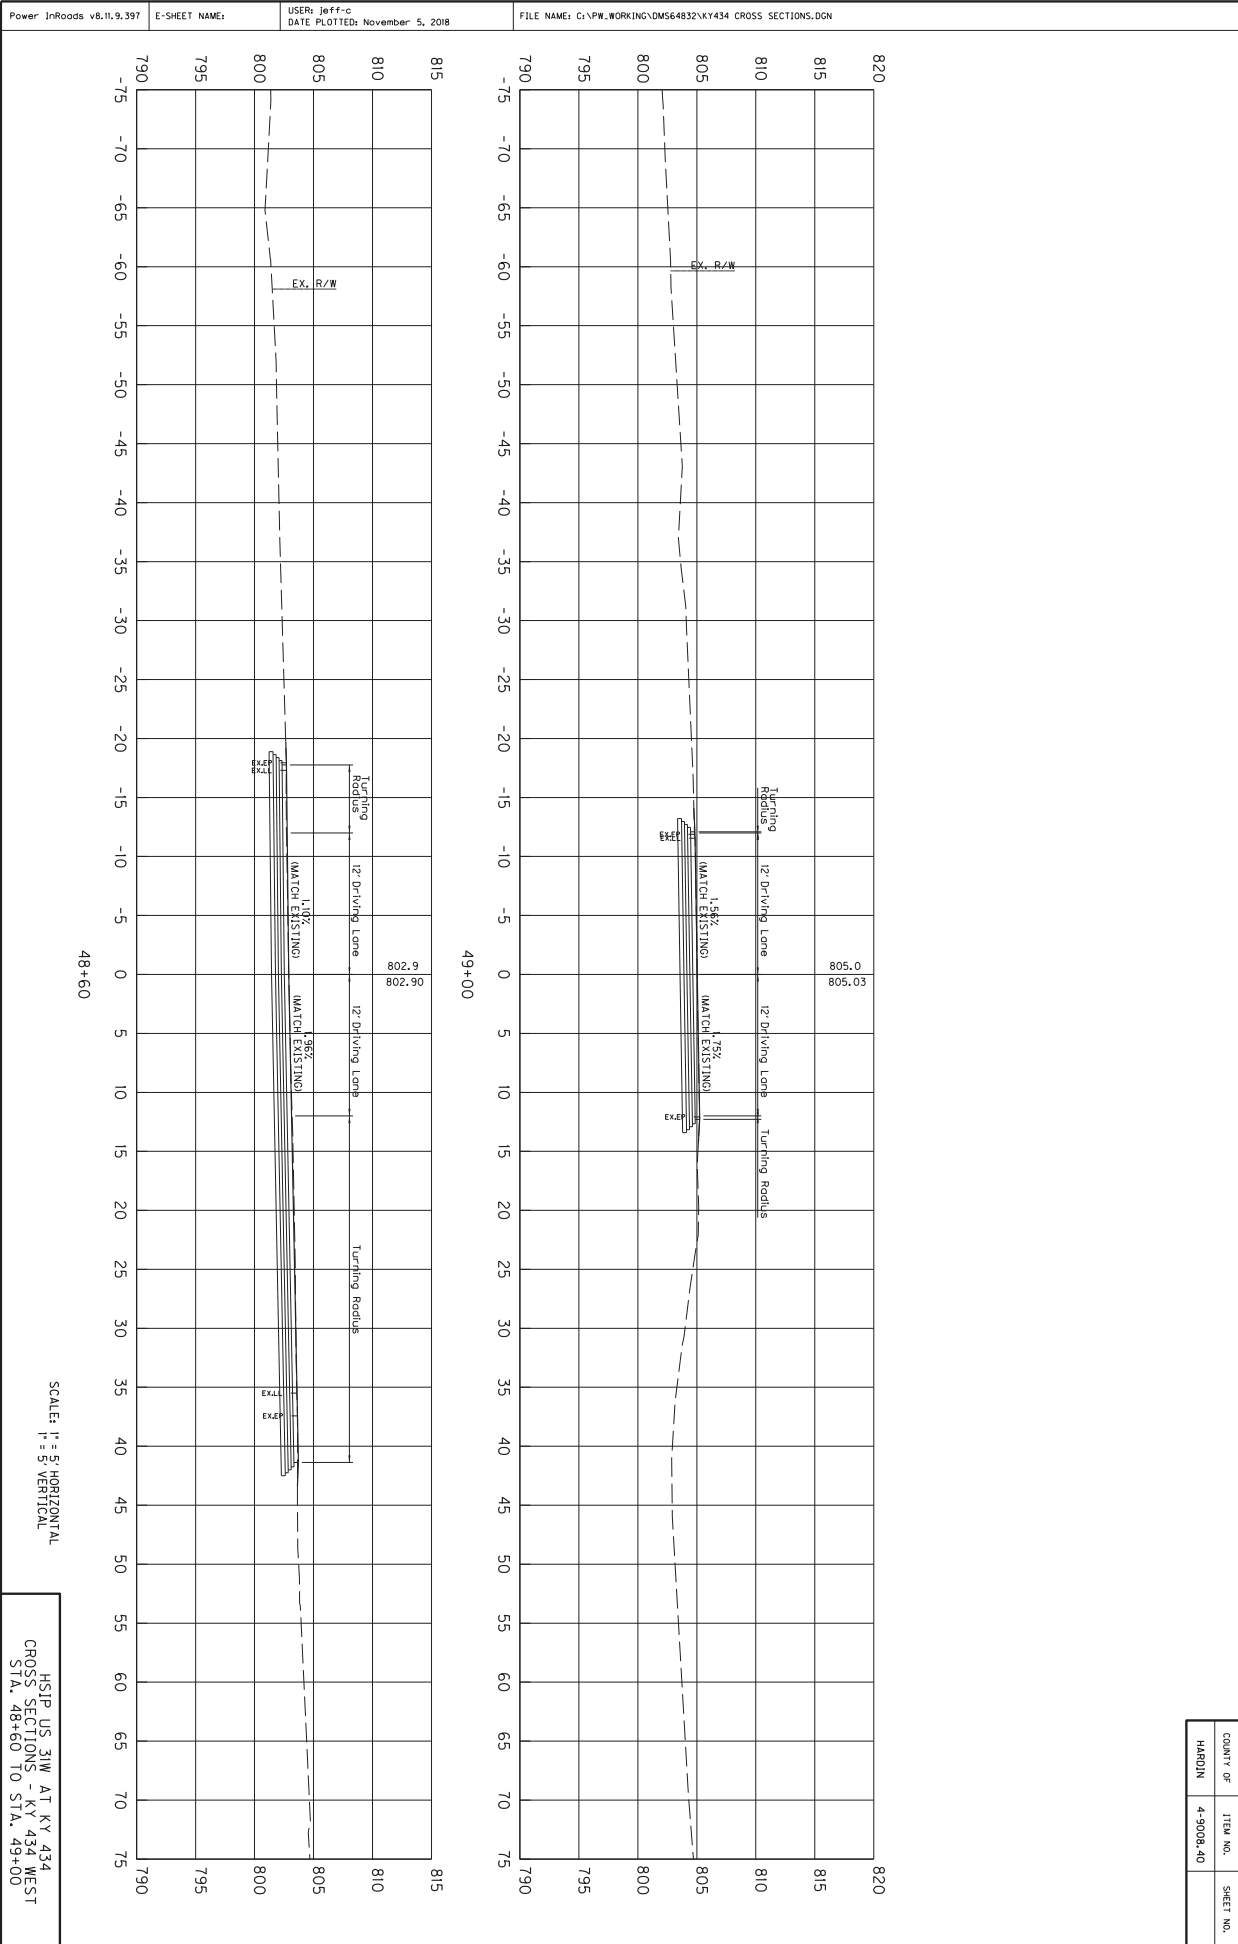

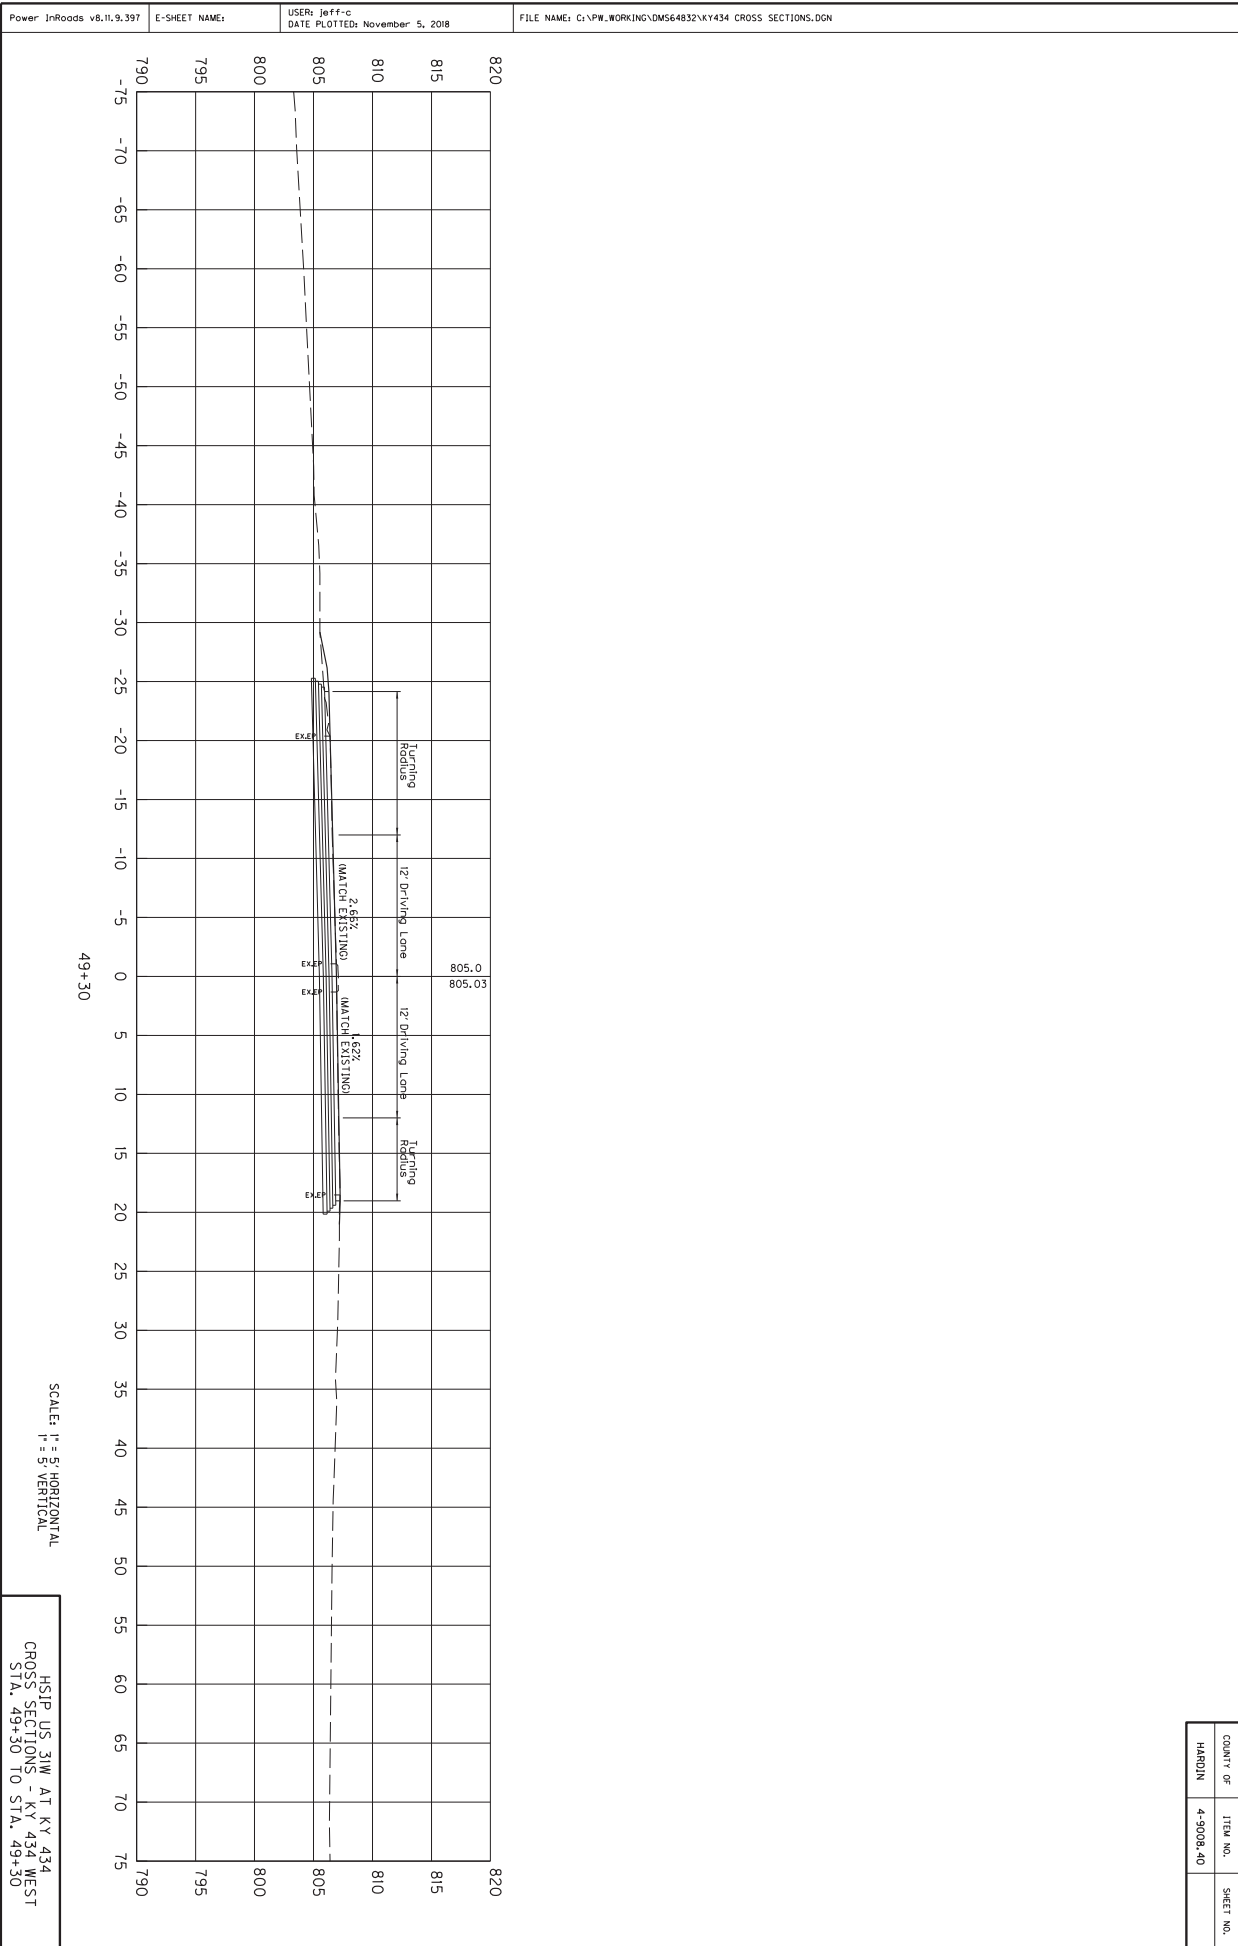

Hardin County
Construction of J-Turns and Intersection Improvements
On US 31W At Blackjack Road
Item No. 4-9008.40

COUNTY OF	ITEM NO.
HARDIN	4-9008.40

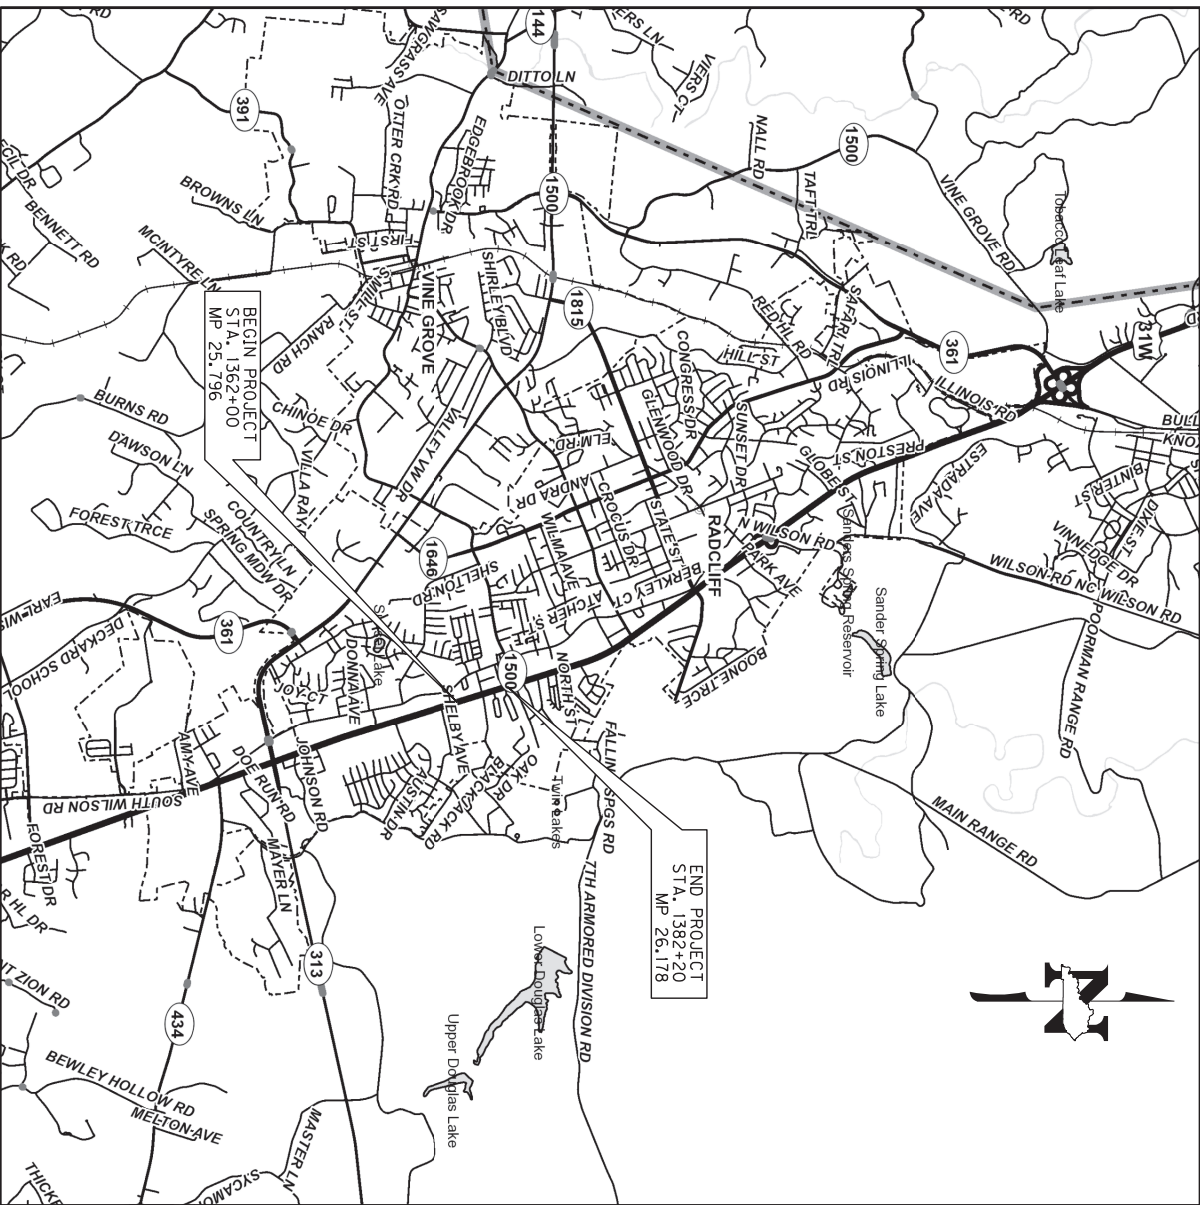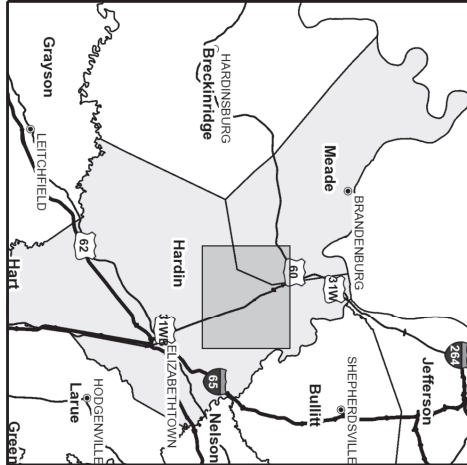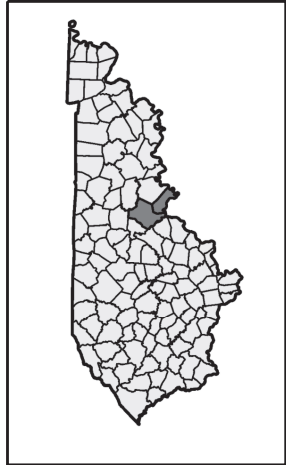


Commonwealth of Kentucky
DEPARTMENT OF HIGHWAYS
 PLANS OF
 PROPOSED PROJECT
HARDIN COUNTY
 US 31W



TYPICAL SECTION AND DETAILS

COUNTY OF	ITEM NO.	SHEET NO.
HARDIN	4-9008.40	




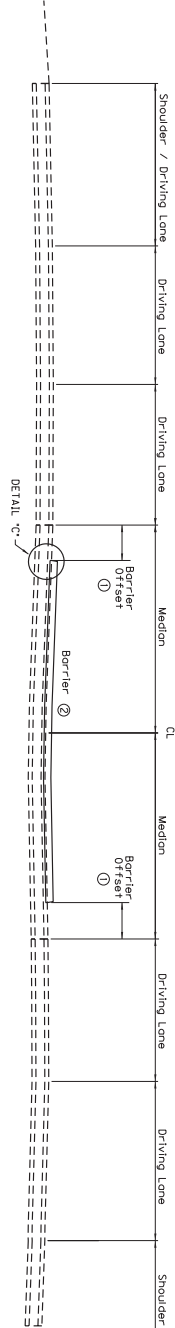


US 31W
BARRIER MEDIAN ON
EXISTING PAVEMENT

- ① 3' TYPICAL - SEE PLANS AND DETAILS WHERE IT MAY VARY
- ② STANDARD BARRIER MEDIAN TYPE 4
- ③ MATCH EXISTING DRIVING LANE BUT NOT LESS THAN 2.00%
- ④ SEE SECTIONS FOR SIDE SLOPES AND DITCH ELEVATIONS.
- ⑤ SPALLS TO BE REMOVED FROM OUTSIDE EDGE OF PAVED SHOULDER TO A POINT 2' FROM THE OUTER SLOPE. 2.4 LB/SY ASPHALT SEAL COAT (TWO APPLICATIONS) AND 20 LB/SY ASPHALT SEAL APPROPRIATE (TWO APPLICATIONS).
- ⑥ SAW CUT TO BE A BID ITEM PAVEMENT REMOVAL (SEE CROSS SECTIONS) AND ROADWAY EXCAVATION

- US 31W PAVEMENT DESIGN
- ① 1.5" SURFACE
 - ② 16.5" BASE
 - ③ 1.5" DEPTH CLASS 3 ASPHALT SURFACE 0-38A PG 76-22
 - ④ 3" DEPTH CLASS 3 ASPHALT BASE 1.00D PG 76-22
 - ⑤ 3" DEPTH CLASS 3 ASPHALT BASE 1.00D PG 64-22
 - ⑥ 3.5" DEPTH CLASS 3 ASPHALT BASE 1.00D PG 64-22
 - ⑦ 4" COMPACTED DEPTH CRUSHED STONE BASE

⑧ BASED ON RECORD PLANS, THE EXISTING PAVEMENT DEPTH IS APPROXIMATELY 16.5". THE EXISTING PAVEMENT THICKNESS TO BE SIGNIFICANTLY DIFFERENT. ADJUSTMENTS MAY BE MADE BY THE ENGINEER TO BEST MATCH THAT THICKNESS.

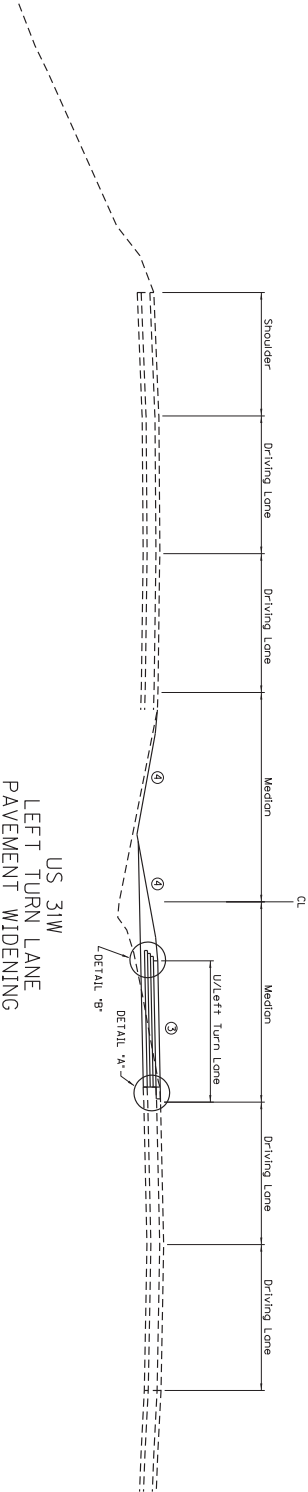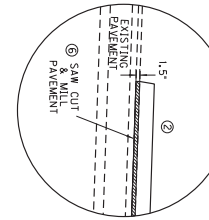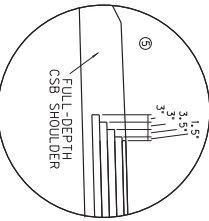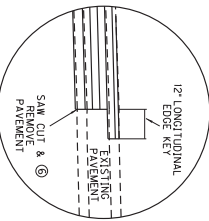



US 31W
LEFT TURN LANE
PAVEMENT WIDENING

NOT TO SCALE

HIGHWAY SAFETY IMPROVEMENT PROGRAM
US 31W AT BLACKJACK ROAD
TYPICAL SECTIONS AND DETAILS







Power InRoads v8.11.9.397 E-SHEET NAME: USER: travis.m DATE PLOTTED: December 7, 2018 FILE NAME: D:\P\WORK\DIR\DM564847\TYPICAL_BLACKJACK.DGN

TYPICAL SECTION AND DETAILS

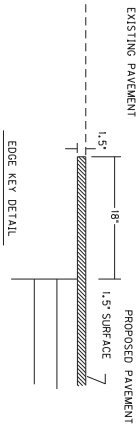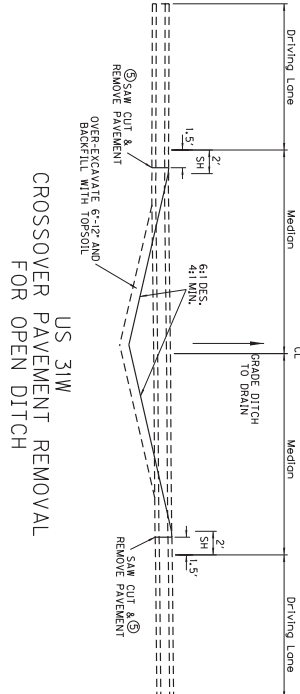

NOTE: UNDER THIS ITEM SHALL INCLUDE CUTTING OUT THE EXISTING SURFACIOUS SURFACE TO A MINIMUM DEPTH AND WIDTH AS SHOWN. SEE CROSS SECTION FOR PAVEMENT REMOVAL. EQUIPMENT TO BE USED SHALL INCLUDE ALL NECESSARY MATERIALS LABOR AND MATERIAL REMOVED.

PROPOSED DRAINAGE INLET CONSTRUCTION IN EXISTING PAVEMENT LOCATIONS


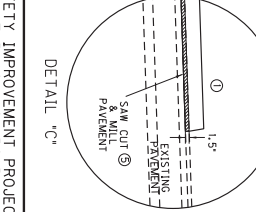
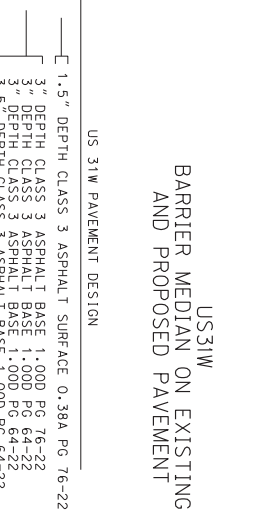
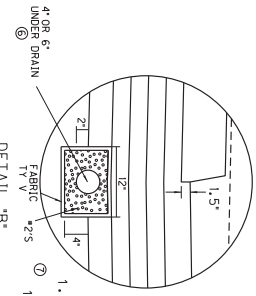
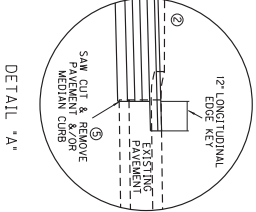
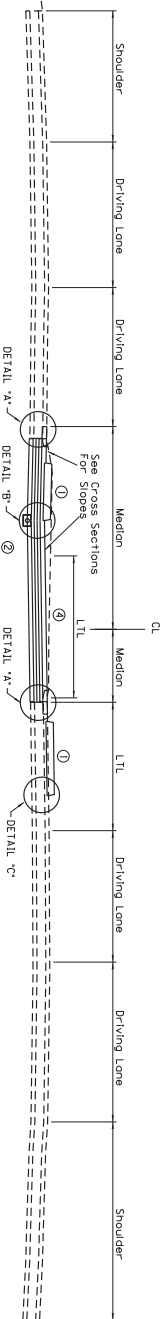
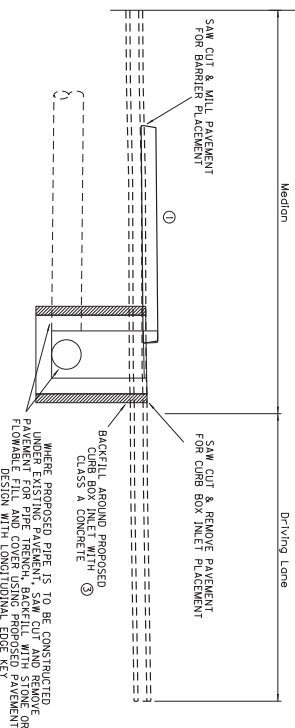


- ① STANDARD BARRIER MEDIAN TYPE 4 ON EXISTING PAVEMENT & TYPE 2 ON NEW PAVEMENT
- ② REMOVAL OF EXISTING MOUNTABLE GRASS MEDIAN TO BE INCLUDED IN ROADWAY EXCAVATION (SEE CROSS SECTIONS); REMOVAL OF MEDIAN CURB TO BE A BID ITEM
- ③ CONCRETE QUANTITIES TO BE INCIDENTAL TO BID ITEM
- ④ FOR CONCRETE QUANTITIES FOR PAVEMENT CROSS SLOPES; SEE CROSS SECTIONS
- ⑤ SAW CUT TO BE A BID ITEM PAVEMENT REMOVAL TO BE INCIDENTAL TO ROADWAY EXCAVATION (SEE CROSS SECTIONS)
- ⑥ CONNECT PIPE TO BE FIELD IN MEDIAN CROSSOVERS TO THE MEDIAN DITCH
- ⑦ BASED ON RECORD PLANS, THE EXISTING PAVEMENT DEPTH IS APPROXIMATELY 15.75" THICK. THE PROPOSED PAVEMENT DESIGN AS SHOWN IS 16" IF FIELD CONDITIONS REVEAL THE EXISTING PAVEMENT TO BE THINNER THAN SHOWN AND DESIGN SHALL BE MADE BY THE ENGINEER TO BEST MATCH THAT THICKNESS.

HIGHWAY SAFETY IMPROVEMENT PROJECT
US 31W AT BLACKJACK ROAD
TYPICAL SECTIONS AND DETAILS

COUNTY OF	ITEM NO.	SHEET NO.
HARDIN	4-9008.40	

TYPICAL SECTION AND DETAILS

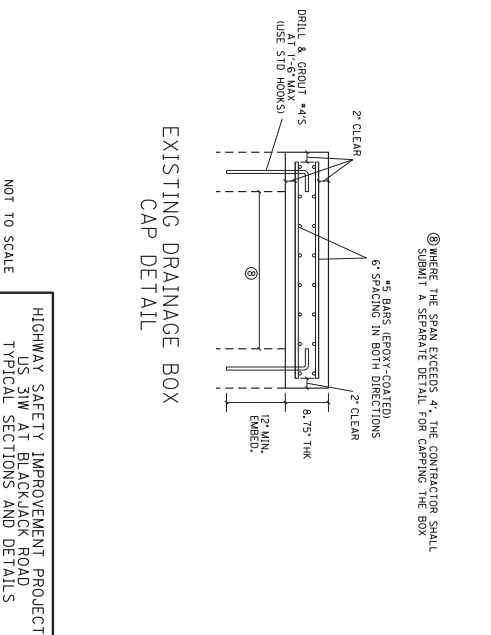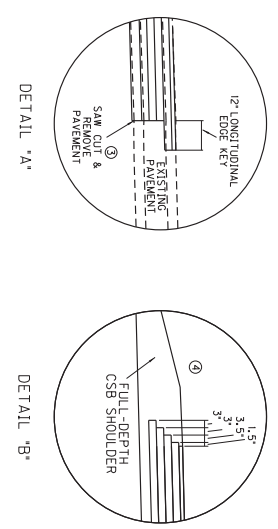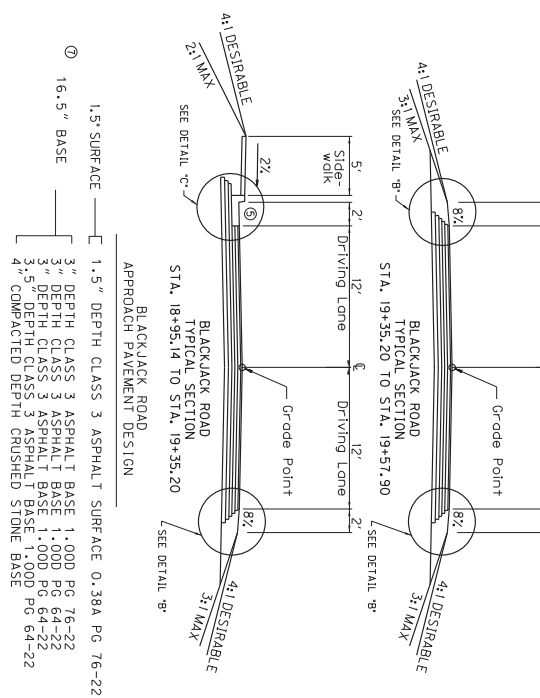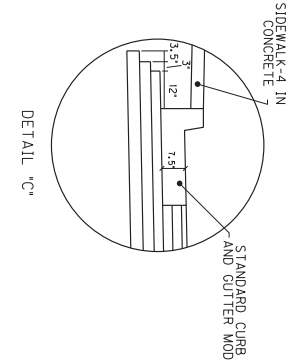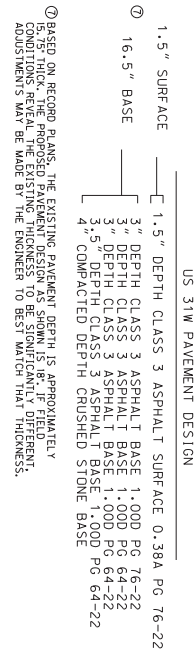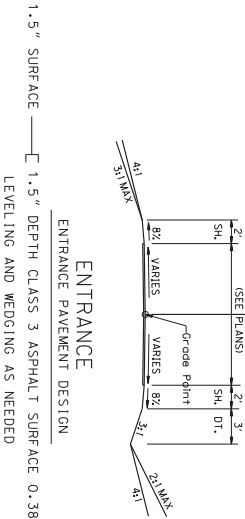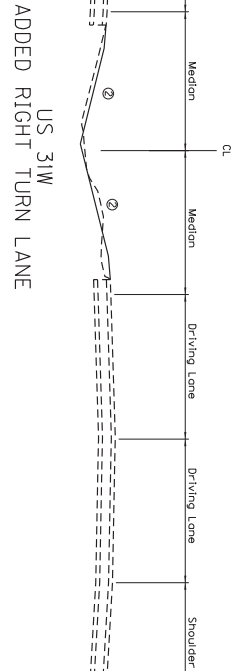

- ① MATCH EXISTING DRIVING LANE BUT NOT LESS THAN 2.00%
- ② SEE CROSS SECTIONS FOR SIDE SLOPES
- ③ SAW CUT TO BE A BID ITEM, PAVEMENT REMOVAL TO BE INCIDENTAL TO ROADWAY EXCAVATION (SEE CROSS SECTIONS)
- ④ ASPHALT SEAL COAT REQUIRED FROM OUTSIDE EDGE OF PAVED SHOULDER TO A POINT 2' DOWN THE DITCH OR FILL SLOPE. 20 LB/5Y ASPHALT SEAL ADEQUATE (TWO APPLICATIONS).
- ⑤ STANDARD CURB AND GUTTER (GUTTER CROSS SLOPE MATCHES PAVEMENT CROSS SLOPE)
- ⑥ RECONSTRUCTION PAVEMENT

HIGHWAY SAFETY IMPROVEMENT PROJECT
US 31W AT BLACKJACK ROAD
TYPICAL SECTIONS AND DETAILS

COUNTY OF	ITEM NO.	SHEET NO.
HARDIN	4-9008.40	

Power InRoads v8.11.9.397 E-SHEET NAME: USER: travis-m DATE PLOTTED: June 17, 2019 FILE NAME: D:\PW\WORKDIR\DM564846\BLACKJACK DRAINAGE SUMMARY.DGN

PIPE DRAINAGE SUMMARY

STRUCTURE NO.	ITEM CODE	SKEW	COVER HEIGHT (FT)	DESIGN PH LEVEL	ENTRANCE PIPE - 15 INCH	CULVERT PIPE - 15 INCH	STORM SEWER PIPE - 15 INCH	STORM SEWER PIPE - 18 INCH	REMOVE PIPE	SLOPED BOX OUTLET TYPE 1-15 IN	SLOPED BOX OUTLET TYPE 1-18 IN	CURB BOX INLET TYPE A	CURB BOX INLET TYPE F	DROP BOX INLET TYPE 5D	REMOVE DROP BOX INLET	REMOVE HEADWALL	REMARKS
	UNIT TO BID HARDIN COUNTY BLACKJACK ROAD				440	461	521	522	1310	1432	1433	1456	1487	1511	1585	2625	
1	1364+43 TO 1365+04 RT. 1366+99.5	0°	1.9 M			62		12	14	2							RCP 18" STORM SEWER PIPE
2	LT. 1370+42	0°	1.7 M														
3	RT. 1370+42	0°	1.7 M					26									
4	LT. 1371+85	0°	2 M				142										
5	LT. 1372+79	0°	2.7 M				94										
6	LT. 1372+93.5 RT. 1373+30	0°	2.8 M				53										
8	RT. 1374+50	0°	2.7 M				118										
7	1380+32 TO 1380+94 LT. 19+32.69 LT. 1373+89 TO 1374+60		1.7 M 2.6 M 1.3 M		71		118		4	2							4" RCP 15" STORM SEWER PIPE
	PROJECT TOTAL				71	125	537	38	546	6	1	4	3	1	2	1	

NOTES: IF A PIPE COLLAR OR BEND CONNECTION IS NEEDED FOR CONSTRUCTION OF A PIPE EXTENSION, IT SHALL BE CONSIDERED INCIDENTAL TO THE COST OF THE PIPE BEING CONSTRUCTED.

⊕ INCLUDES ADDITIONAL QUANTITIES FROM PLANS, SEE PLAN CHARTS

HIGHWAY SAFETY IMPROVEMENT PROJECT
US 31W AT BLACKJACK ROAD
PIPE DRAINAGE SUMMARY

COUNTY OF	ITEM NO.	SHEET NO.
HARDIN	4-9008.40	-

Power InRoads v8.11.9.397 E-SHEET NAME: USER: travis-m DATE PLOTTED: March 29, 2019 FILE NAME: D:\PW\WORKDIR\DM564840\PLAN SHEET R3-BLACKJACK.DGN

LT	RT	MED	STA. TO STA.	TYPE	QUANTITY	DEPTH	THICKNESS	DITCH
X			1362+00 TO 1362+58	RNM TYP 1	52 SY	1.00		V
X			1364+25 TO 1364+35	EFO BLANKET	9 SY	1.00		V
X			1365+12 TO 1366+31	RNM TYP 1	159 SY	1.00		V
X			1367+06 TO 1369+75	RNM TYP 1	259 SY	1.50		V
X			1369+15 TO 1370+01	EFO BLANKET	28 SY	2.00		V
X			1371+66 TO 1371+65	EFO BLANKET	29 SY	1.50		V
X			1373+14 TO 1373+89	EFO BLANKET	88 SY	1.50		V

LT	RT	MED	STA. TO STA.	REASON FOR REMOVAL	REQUIRE PIPE	REQUIRE CURB	REQUIRE PAVEMENT
X			1362+00 TO 1362+58	REASON FOR REMOVAL	1.58	1.58	1.58
X			1364+46 TO 1365+04	REASON FOR REMOVAL	1.58	1.58	1.58
X			1365+33 TO 1366+00	REASON FOR REMOVAL	1.58	1.58	1.58
X			1371+89 TO 1374+00	REASON FOR REMOVAL	236		


1365+00

STATION TO STATION	INLET ELEV.	INLET TYPE	INLET TYPE	OUTLET ELEV.	OUTLET TYPE	PIPE
1364+43 - 1365+04	766.17	SL. BOX	OUTLET TYP 1	764.81	SL. BOX	OUTLET TYP 1 62 LF - 15"

STATION	INLET	PIPE	OUTLET	INVERT
1	RT. 1366+99.5	CB1 50	18"	763.17
2	LT. 1370+42	CB1 15"	12"	776.07
3	LT. 1370+42	CB1 15"	12"	773.53
4	LT. 1370+45	CB1 15"	12"	776.24
5	LT. 1372+79	CB1 15"	12"	774.48
6	RT. 1373+50	CB1 15"	12"	772.99
7	LT. 1373+50	CB1 15"	12"	778.51
8	LT. 1373+50	CB1 15"	12"	775.07
9	LT. 1373+50	CB1 15"	12"	778.56
10	LT. 1373+50	CB1 15"	12"	775.12

1370+00

STA. 1372+57.71 US31W
STA. 20+00.00 BLACKJACK RD.

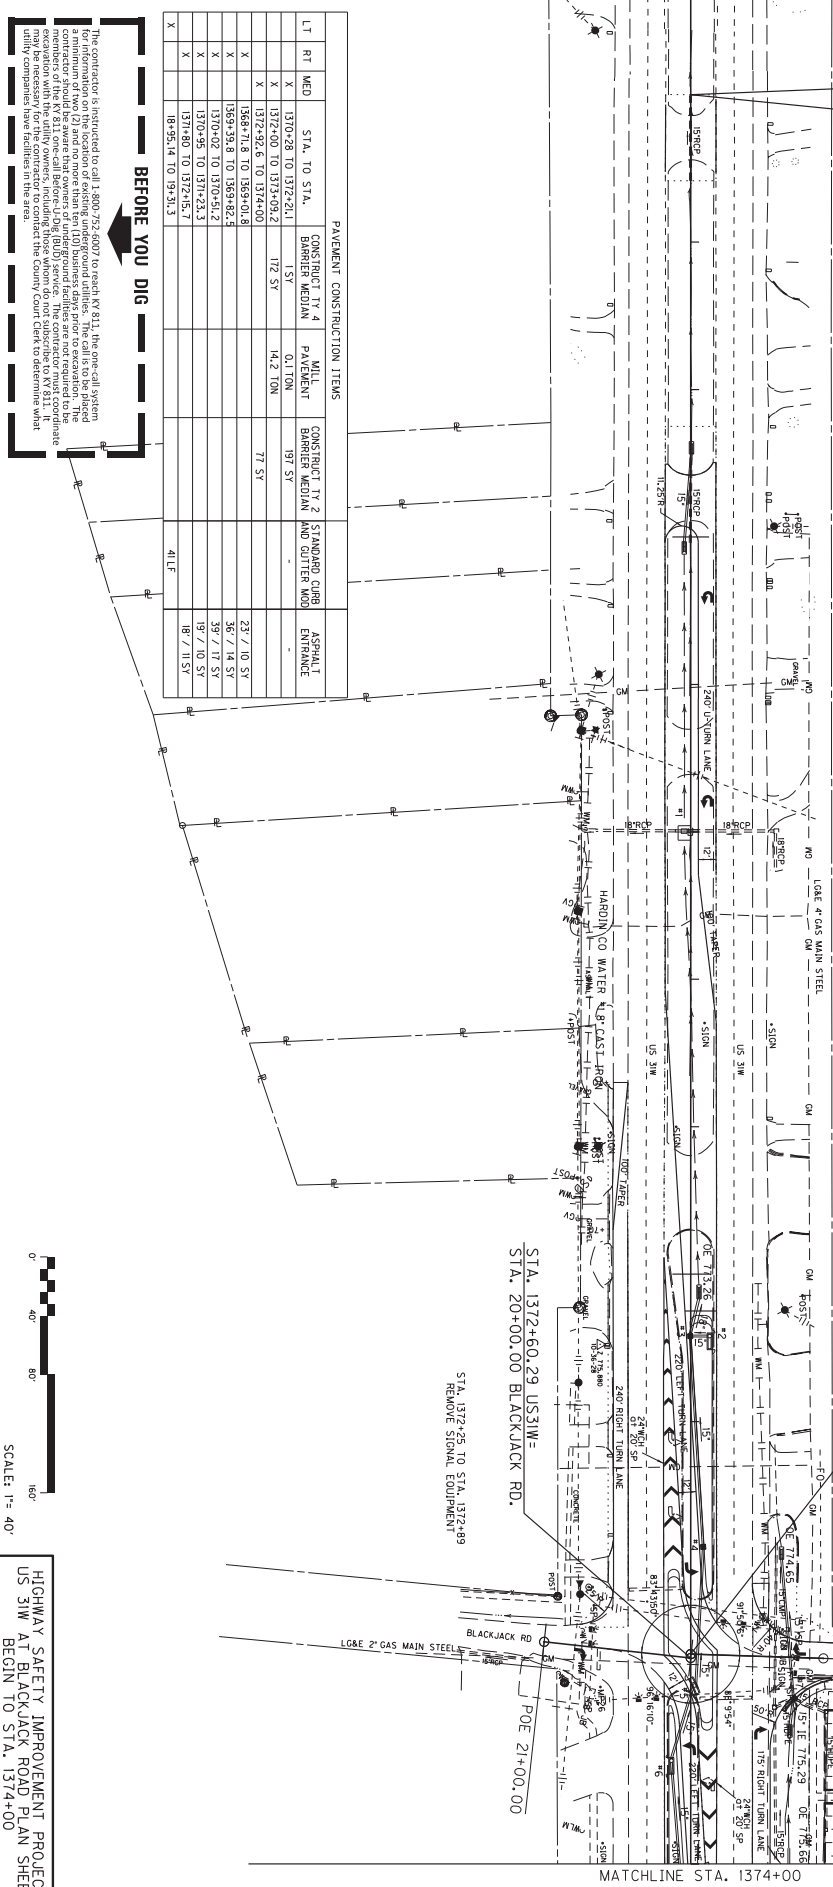

BEFORE YOU DIG

The contractor is instructed to call 1-800-752-6007 to reach KY 811, the one-call system for information on the location of existing underground utilities. The call is to be placed at least 48 hours before any excavation work is to be performed. The contractor must coordinate with the members of the KY 811 one-call before any Dig (BUD) service. The contractor must coordinate with the members of the KY 811 one-call before any Dig (BUD) service. The contractor must coordinate with the members of the KY 811 one-call before any Dig (BUD) service. The contractor must coordinate with utility companies that have facilities in the area.



HIGHWAY SAFETY IMPROVEMENT PROJECT
US 31W AT BLACKJACK ROAD PLAN SHEET
BEGIN TO STA. 1374+00

COUNTY OF	ITEM NO.	SHEET NO.
HARDIN	4-9008.40	

MATCHLINE STA. 1374+00

Power InRoads v8.11.9.397 E-SHEET NAME: USER: travis-m DATE PLOTTED: June 17, 2019 FILE NAME: D:\PW_WORKDIR\DM564840\PLAN SHEET R4-BLACKJACK.DGN

MATCHLINE STA. 1374+00

REMOVE OR MODIFY DRAINAGE STRUCTURES	REMOVE DBI (ELEV.)	REMOVE HOWLI (ELEV.)	REMOVE PIPE (L.S.)
X	1374+00 TO 1374+66		56
X	1380+38 TO 1380+94		58
X	1381+59 TO 1382+17		58

STATION TO STATION	INLET ELEV.	INLET TYPE	OUTLET ELEV.	OUTLET TYPE	PIPE TYPE	PIPE SIZE	TOP/GRADE	INVERT
1373+89 - 1374+60	776.03		775.66		7" LF - 15"	18"	778.67	775.74
1380+32 - 1380+94	776.36	ST. BOX	775.98	ST. BOX	7" LF - 15"	18"		

STRUCTURE	STATION	DBI	TYPE	PIPE TYPE	PIPE SIZE	TOP/GRADE	INVERT
B	RT. 1374+50	CB1	A	15"	18"	778.67	775.74

1380+00

DITCH CONSTRUCTION CHART	STA. TO STA.	TYPE	QUANTITY	DEPTH	THICKNESS	DITCH
X	1376+25 TO 1378+28	EFO BLANKET	254 SY	1.50		V
X	1378+25 TO 1380+24	EFO BLANKET	133 SY	1.50		V
X	1381+60 TO 1382+52	EFO BLANKET	197 SY	1.50		V
X	1374+60 TO 1375+12	EFO BLANKET	112 SY	1.00		V

PAVEMENT CONSTRUCTION ITEMS	STA. TO STA.	CONSTRUCTION TYPE	QUANTITY	THICKNESS	ASPHALT ENTRANCE
X	1374+00 TO 1376+47	CONSTRUCT TY 4 BARRIER MEDIUM	463 SY		
X	1373+80 TO 1374+56.9	CONSTRUCT TY 2 BARRIER MEDIUM	387.9 SY		

END CONSTRUCTION STA. 1382+20

1385+00

BEFORE YOU DIG

The contractor is instructed to call 1.800.752.0007 to reach KY 811, the one-call system for information on the location of existing underground utilities. The call is to be placed at least 48 hours before any excavation or construction activity. The contractor must coordinate with the members of the KY 811 one-call Before-Useful (BU) service. The contractor must coordinate with the utility companies to determine what utility companies have facilities in the area.




HIGHWAY SAFETY IMPROVEMENT PROJECT
US 31W AT BLACKJACK ROAD PLAN SHEET
STA. 1374+00 TO END

COUNTY OF	ITEM NO.	SHEET NO.
HARDIN	4-9008.40	

Power InRoads v8.11.9.397 E-SHEET NAME: USER: frcvls-m DATE PLOTTED: December 5, 2018 FILE NAME: D:\PW\WORKDIR\DM564834\BLACKJACK BARRIER DETAIL 1.DGN

MAINLINE ALIGNMENT POINTS			
POINT	DESCRIPTION	STATE PLANE COORDINATES	
POB	1317+99.24	3816072.9128 4872375.3710	
POE	1412+00.00	3823117.8728 4869856.0002	
BLACKJACK RD. LT. ALIGNMENT POINTS			
POB	19+10.00	3821263.7627 4870763.3880	
POE	20+00.00	3821287.7826 4870750.1256	
BLACKJACK RD. RT. ALIGNMENT POINTS			
POB	20+00.00	3821290.2125 4870749.5524	
POE	21+00.00	3821309.4851 4870737.5865	

CONTROL POINTS						
POINT	DESCRIPTION	STATE PLANE COORD.			STATION	OFFSET
		NORTH (N)	EAST (E)	ELEV. (E)		
11+24-2.5	ALIGNMENT DISK	381825.4200	4871533.2200	755.59	1127+49.43	62.54 RT
11+24-2.5	ALIGNMENT DISK	381825.4200	4871533.2200	755.59	1127+49.43	62.54 RT
11+24-2.5	ALIGNMENT DISK	3821263.7627	4870763.3880	775.88	1370+47.63	62.48 RT
11+24-2.5	ALIGNMENT DISK	3821263.7627	4870763.3880	775.88	1370+47.63	62.48 RT
11+24-2.5	ALIGNMENT DISK	3823231.8400	4870751.2400	775.69	1385+17.96	78.28 RT
11+24-2.5	ALIGNMENT DISK	3823231.8400	4870751.2400	775.69	1385+17.96	78.28 RT
11+24-2.5	ALIGNMENT DISK	3823231.8400	4870751.2400	775.69	1385+17.96	78.28 RT

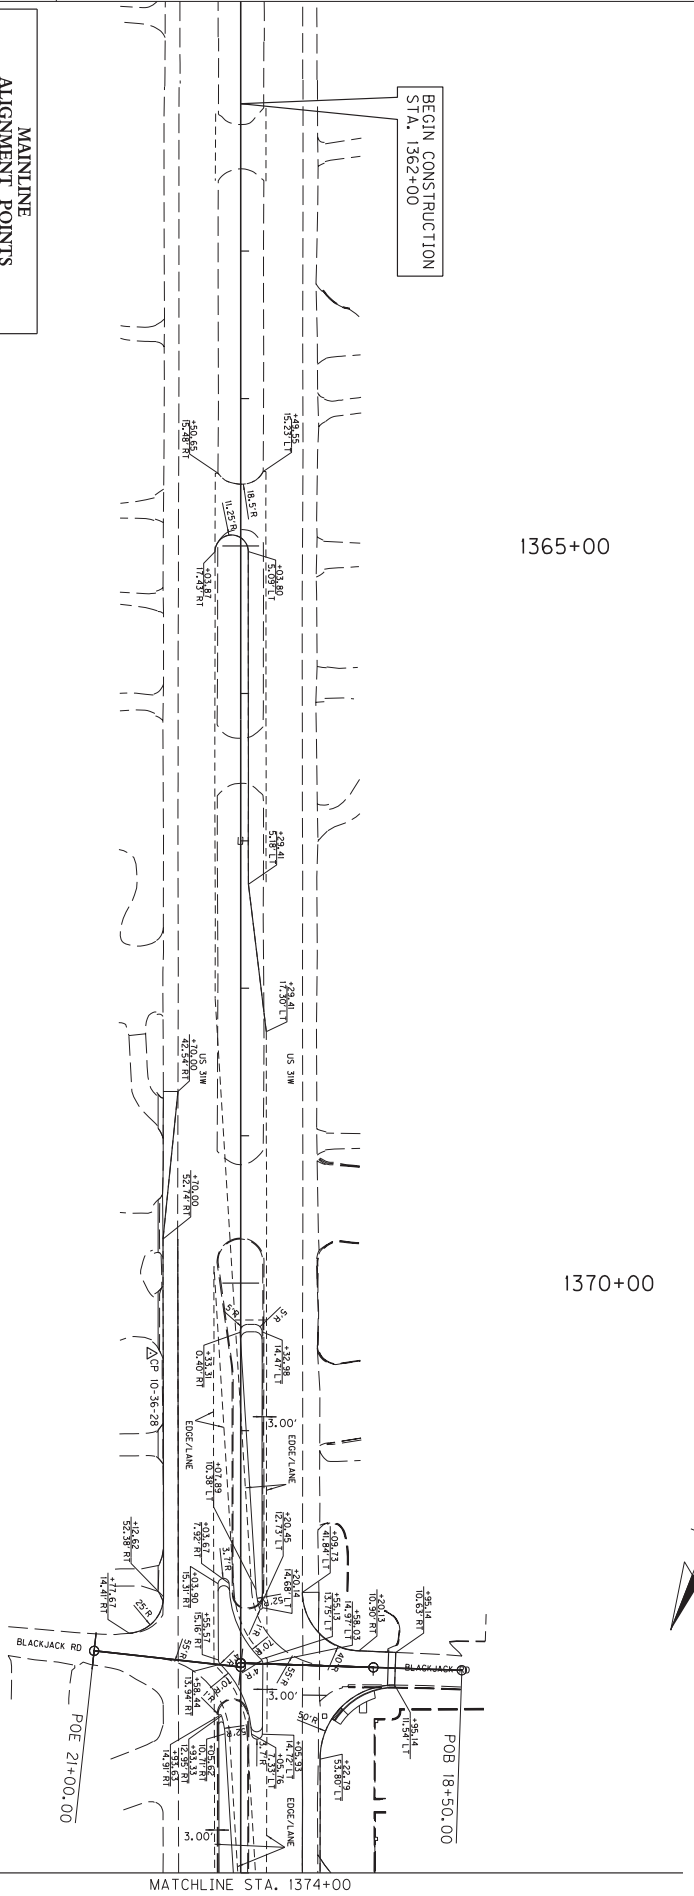

1365+00

1370+00



SCALE: 1" = 40'

HSIP US 31W AT BLACKJACK ROAD
BARRIER DETAIL & CONTROL PLAN SHEET
BEGIN TO STA. 1374+00


COUNTY OF	ITEM NO.	SHEET NO.
HARDIN	4-9008.40	

Power InRoads v8.11.9.397 E-SHEET NAME: USER: travis-m DATE PLOTTED: September 26, 2018 FILE NAME: D:\PW_WORKDIR\DM564834\BLACKJACK BARRIER DETAIL 2.DGN

MATCHLINE STA. 1374+00

MAINLINE ALIGNMENT POINTS			
POINT	DESCRIPTION	STATE PLANE COORDINATES	
		NORTH (Y)	EAST (X)
POB	1317+972.36	3816074.9148	4872475.3710
POE	1412+697.63	3823317.8728	4880926.0012

CONTROL POINTS							
POINT	DESCRIPTION	STATE PLANE COORD.			STATION	ORISPT	
		NORTH (Y)	EAST (X)	ELEV. (Z)			
CP-10-21-22	ADJUNCTION DSK	3818871.4888	4871533.3200	732.59	1377+48.43	62.58	RT
CP-10-21-23	ADJUNCTION DSK	3819941.5888	4871538.6400	732.47	1378+38.43	58.11	RT
CP-10-21-24	ADJUNCTION DSK	3821211.8400	4870612.8400	732.69	1385+12.96	72.26	RT
CP-10-21-25	ADJUNCTION DSK	3823413.5888	4870701.7700	734.45	1393+74.23	63.83	RT

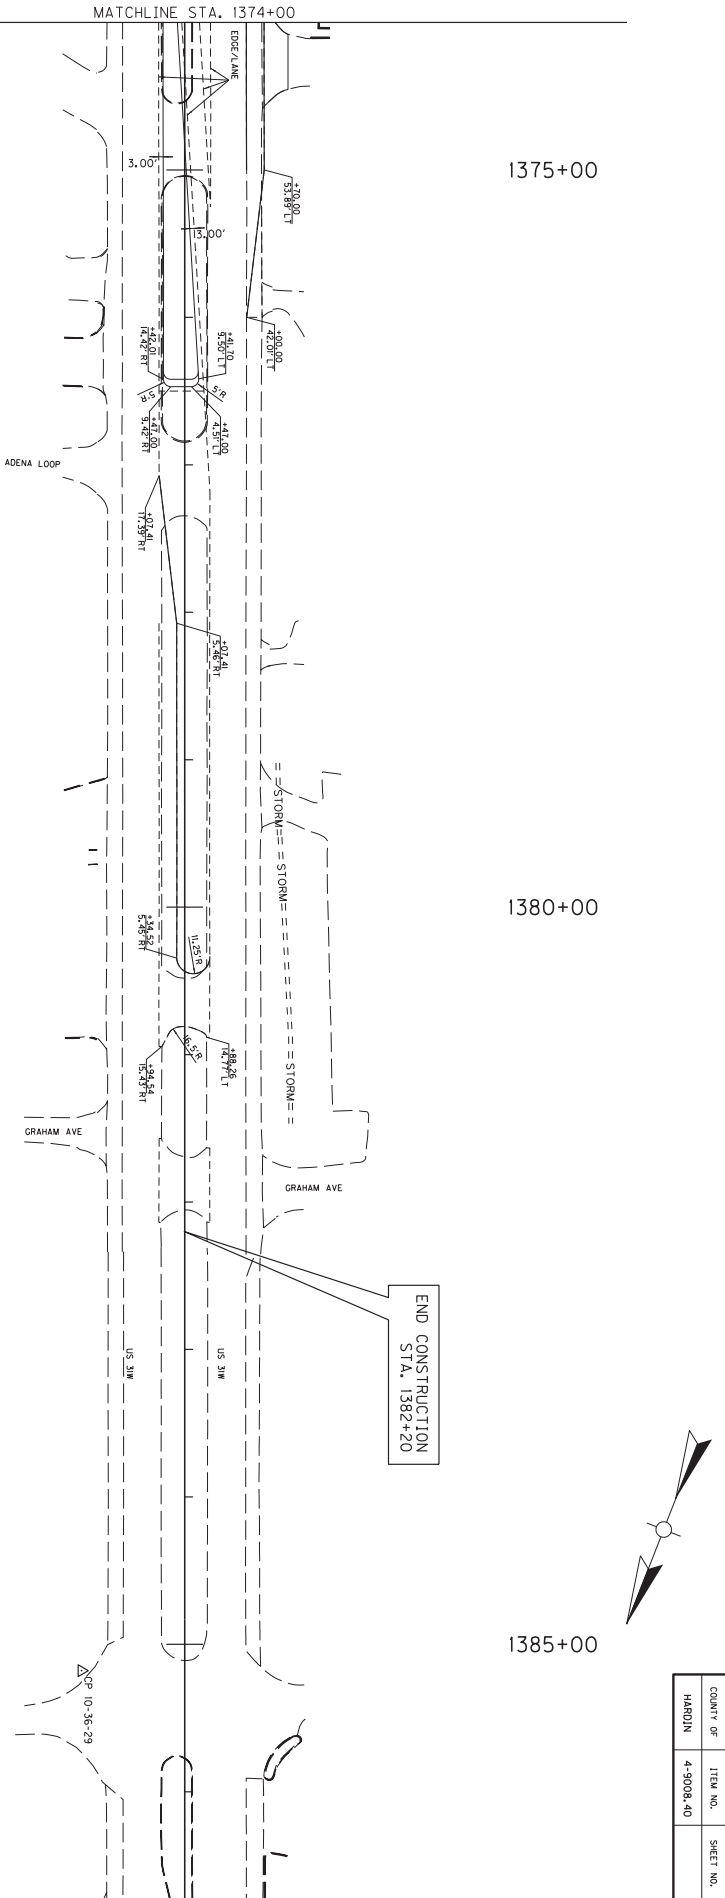

SCALE: 1" = 40'


HSIP US 31W AT BLACKJACK ROAD
BARRIER DETAIL & CONTROL PLAN SHEET
STA. 1374+00 TO END

COUNTY OF	ITEM NO.	SHEET NO.
HARDIN	4-9008.40	

Power InRoads v8.11.9.397 E-SHEET NAME: USER: travis-m DATE PLOTTED: November 14, 2018 FILE NAME: D:\PW\WORKDIR\DM564834\BLACKJACK STRIPING DETAIL 1.DGN

STRIPING QUANTITIES

ITEM	DESCRIPTION	UNIT	US 31W	BLACKJACK NO. 165	BLACKJACK NO. 37
24996C	PAVE STRIPING-SPRAY THERMO-6 IN W	LF	1951	-	-
24996C	PAVE STRIPING-SPRAY THERMO-6 IN Y	LF	1956	-	-
6530	PAVEMENT STRIPING REMOVAL - 4 INCH	50 FT	1231	-	-
6598	PAVEMENT MARKING REMOVAL	50 FT	183	20	28
6574	PAVE MARKING - THERMO CURV ARROW	EACH	11	1	1
24679E	PAVE MARK THERMO CHEVRON	50 FT	295	-	-

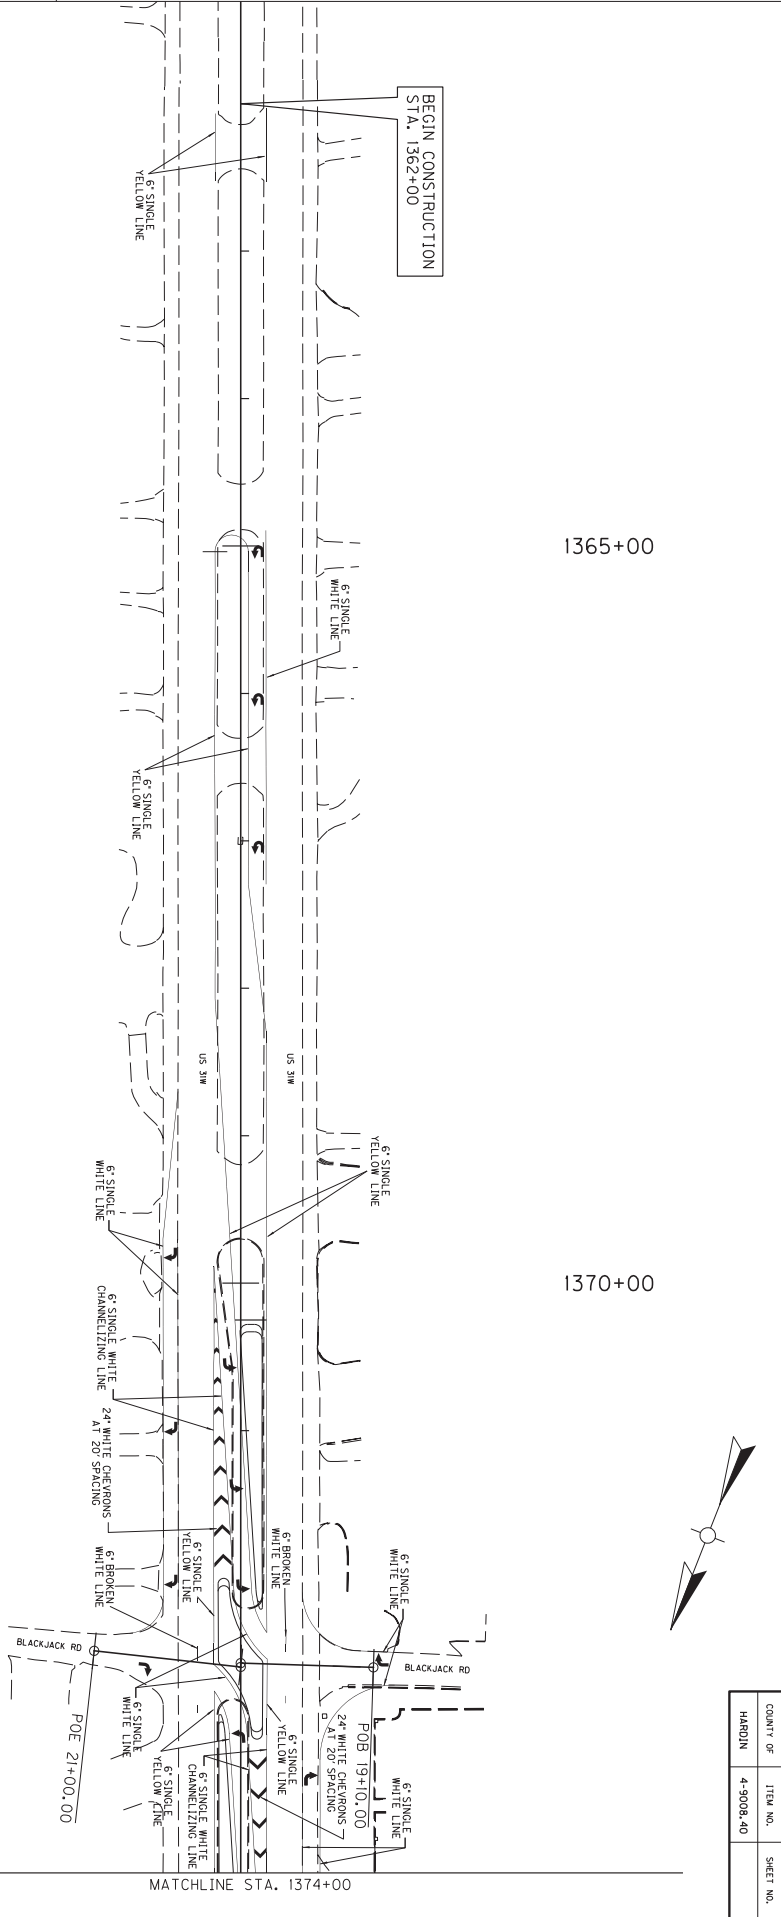

COUNTY OF	ITEM NO.	SHEET NO.
HARDIN	4-9008.40	




HSIP US 31W AT BLACKJACK ROAD
STRIPING DETAIL PLAN SHEET
BEGIN TO STA. 1374+00

MATCHLINE STA. 1374+00

Power InRoads v8.11.9.397 E-SHEET NAME: USER: travis-m DATE PLOTTED: November 14, 2018 FILE NAME: D:\PW_WORKDIR\DM564834\BLACKJACK STRIPING DETAIL 2.DGN

MATCHLINE STA. 1374+00

STRIPING QUANTITIES			
ITEM	DESCRIPTION	UNIT	US 31W
2499SEC	PAVE STRIPING-SPRAY THERMO-6 IN W	LF	791
2499SEC	PAVE STRIPING-SPRAY THERMO-6 IN Y	LF	1412
6530	PAVEMENT STRIPING REMOVAL - 4 INCH	LF	806
6598	PAVEMENT STRIPING REMOVAL	SO FT	16
6574	PAVE MARKING - THERMO CURVY ARROW	EACH	8
24679E0	PAVE MARK THERMO CHEVRON	SO FT	66

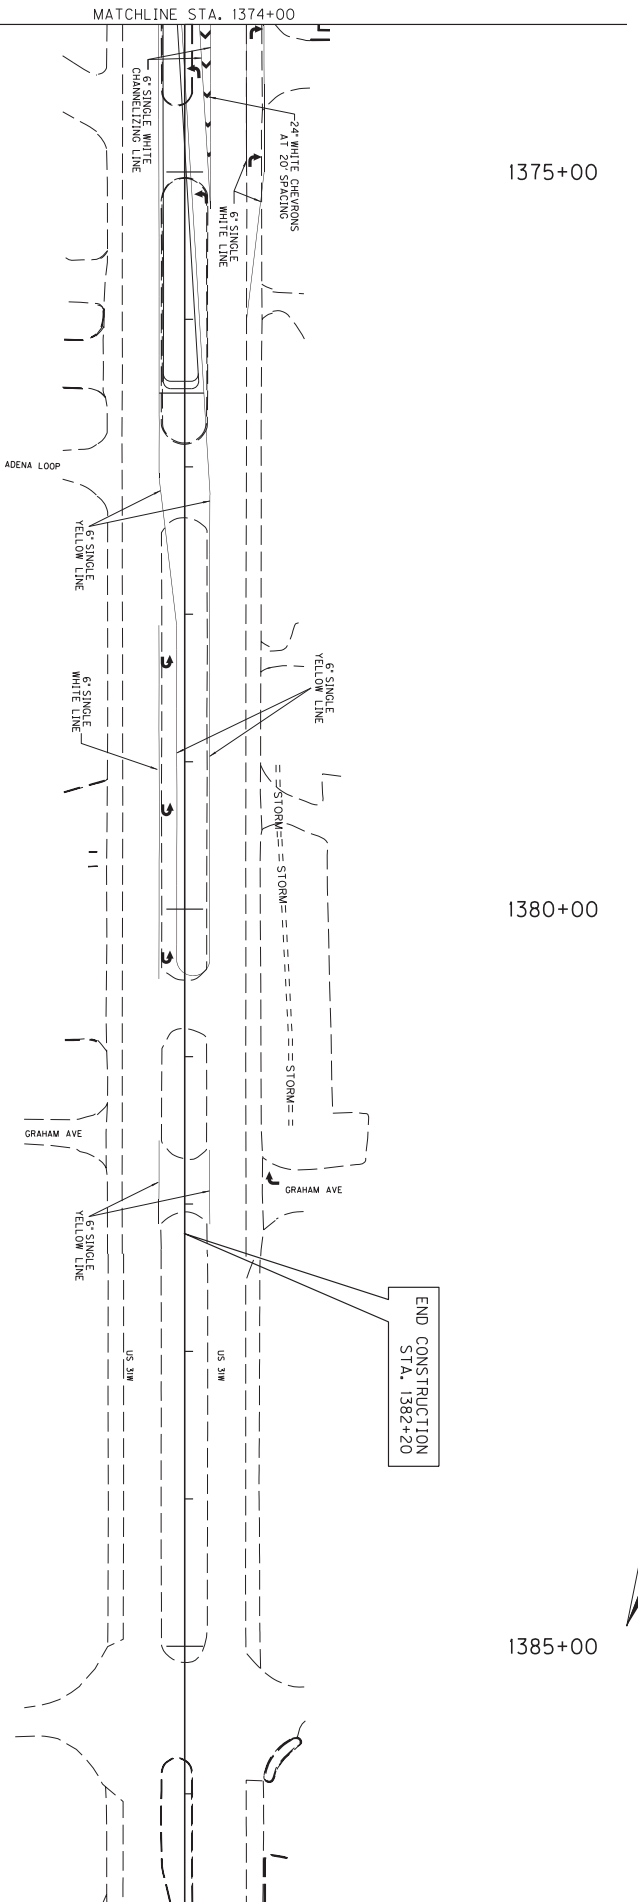



SCALE: 1" = 40'




HSIP US 31W AT BLACKJACK ROAD
STRIPING DETAIL PLAN SHEET
STA. 1374+00 TO END

COUNTY OF	ITEM NO.	SHEET NO.
HARDIN	4-9008.40	

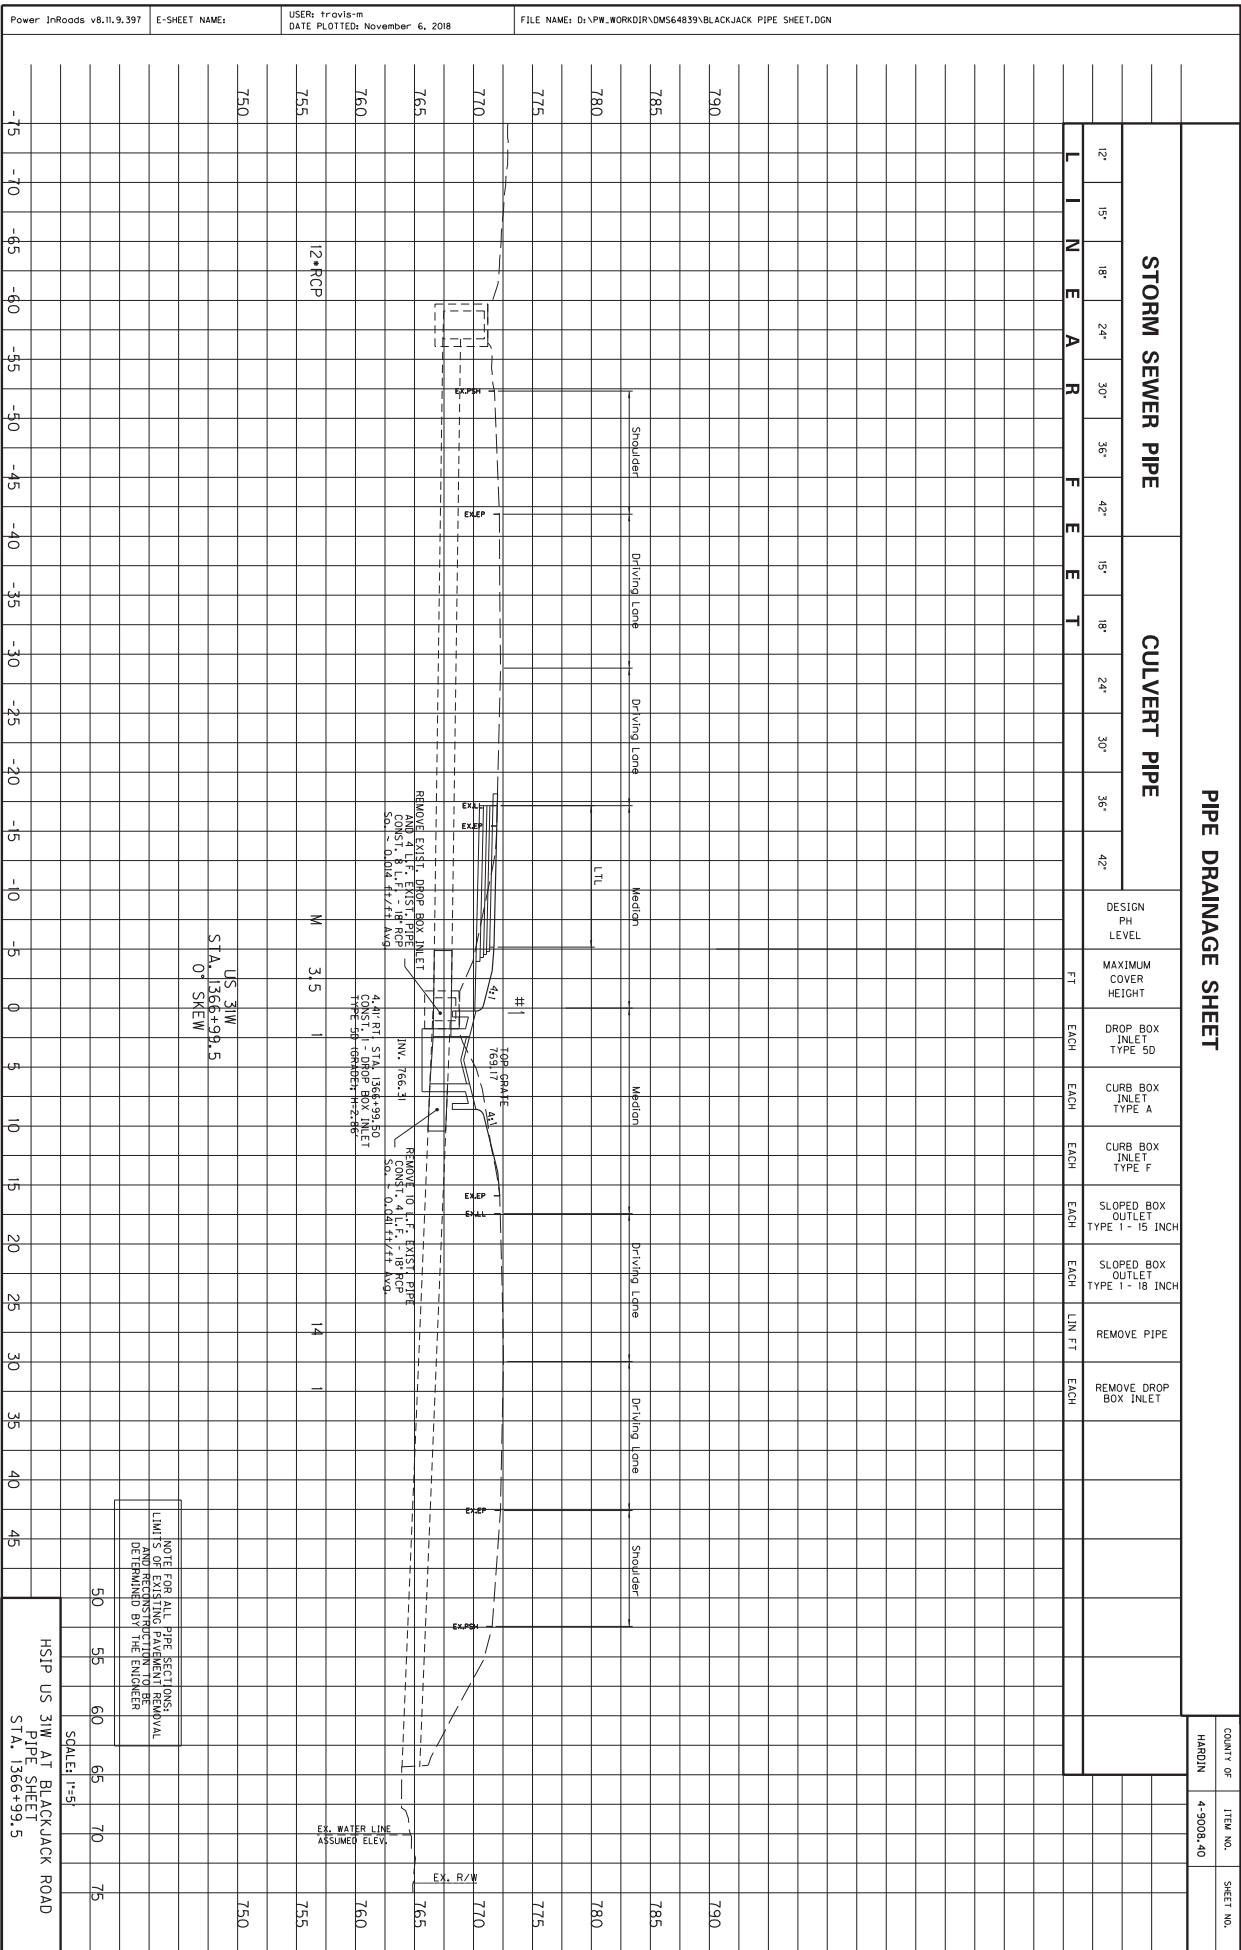

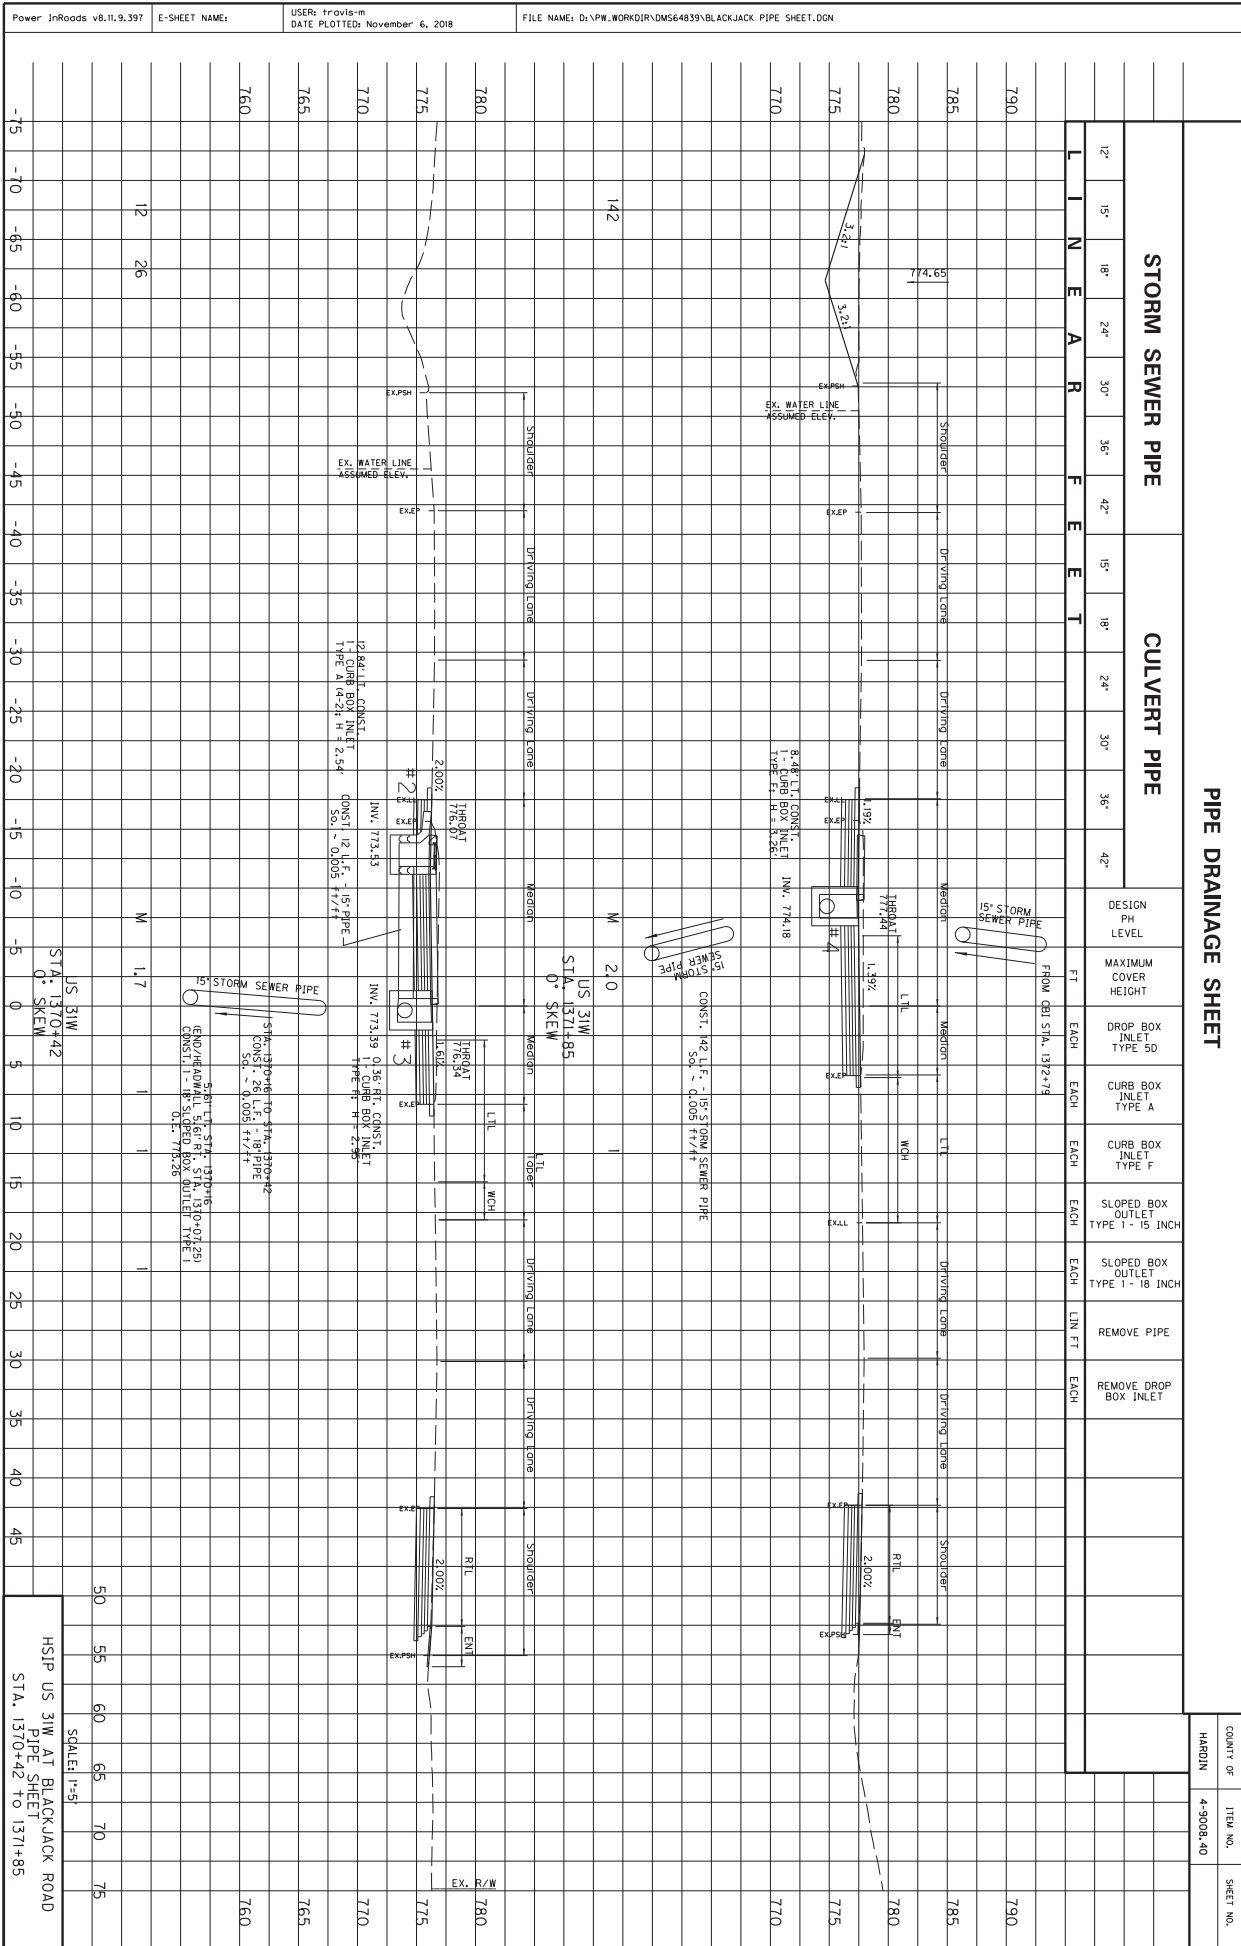

COUNT OF	ITEM NO.	SHEET NO.
HARDIN	4-9008-40	

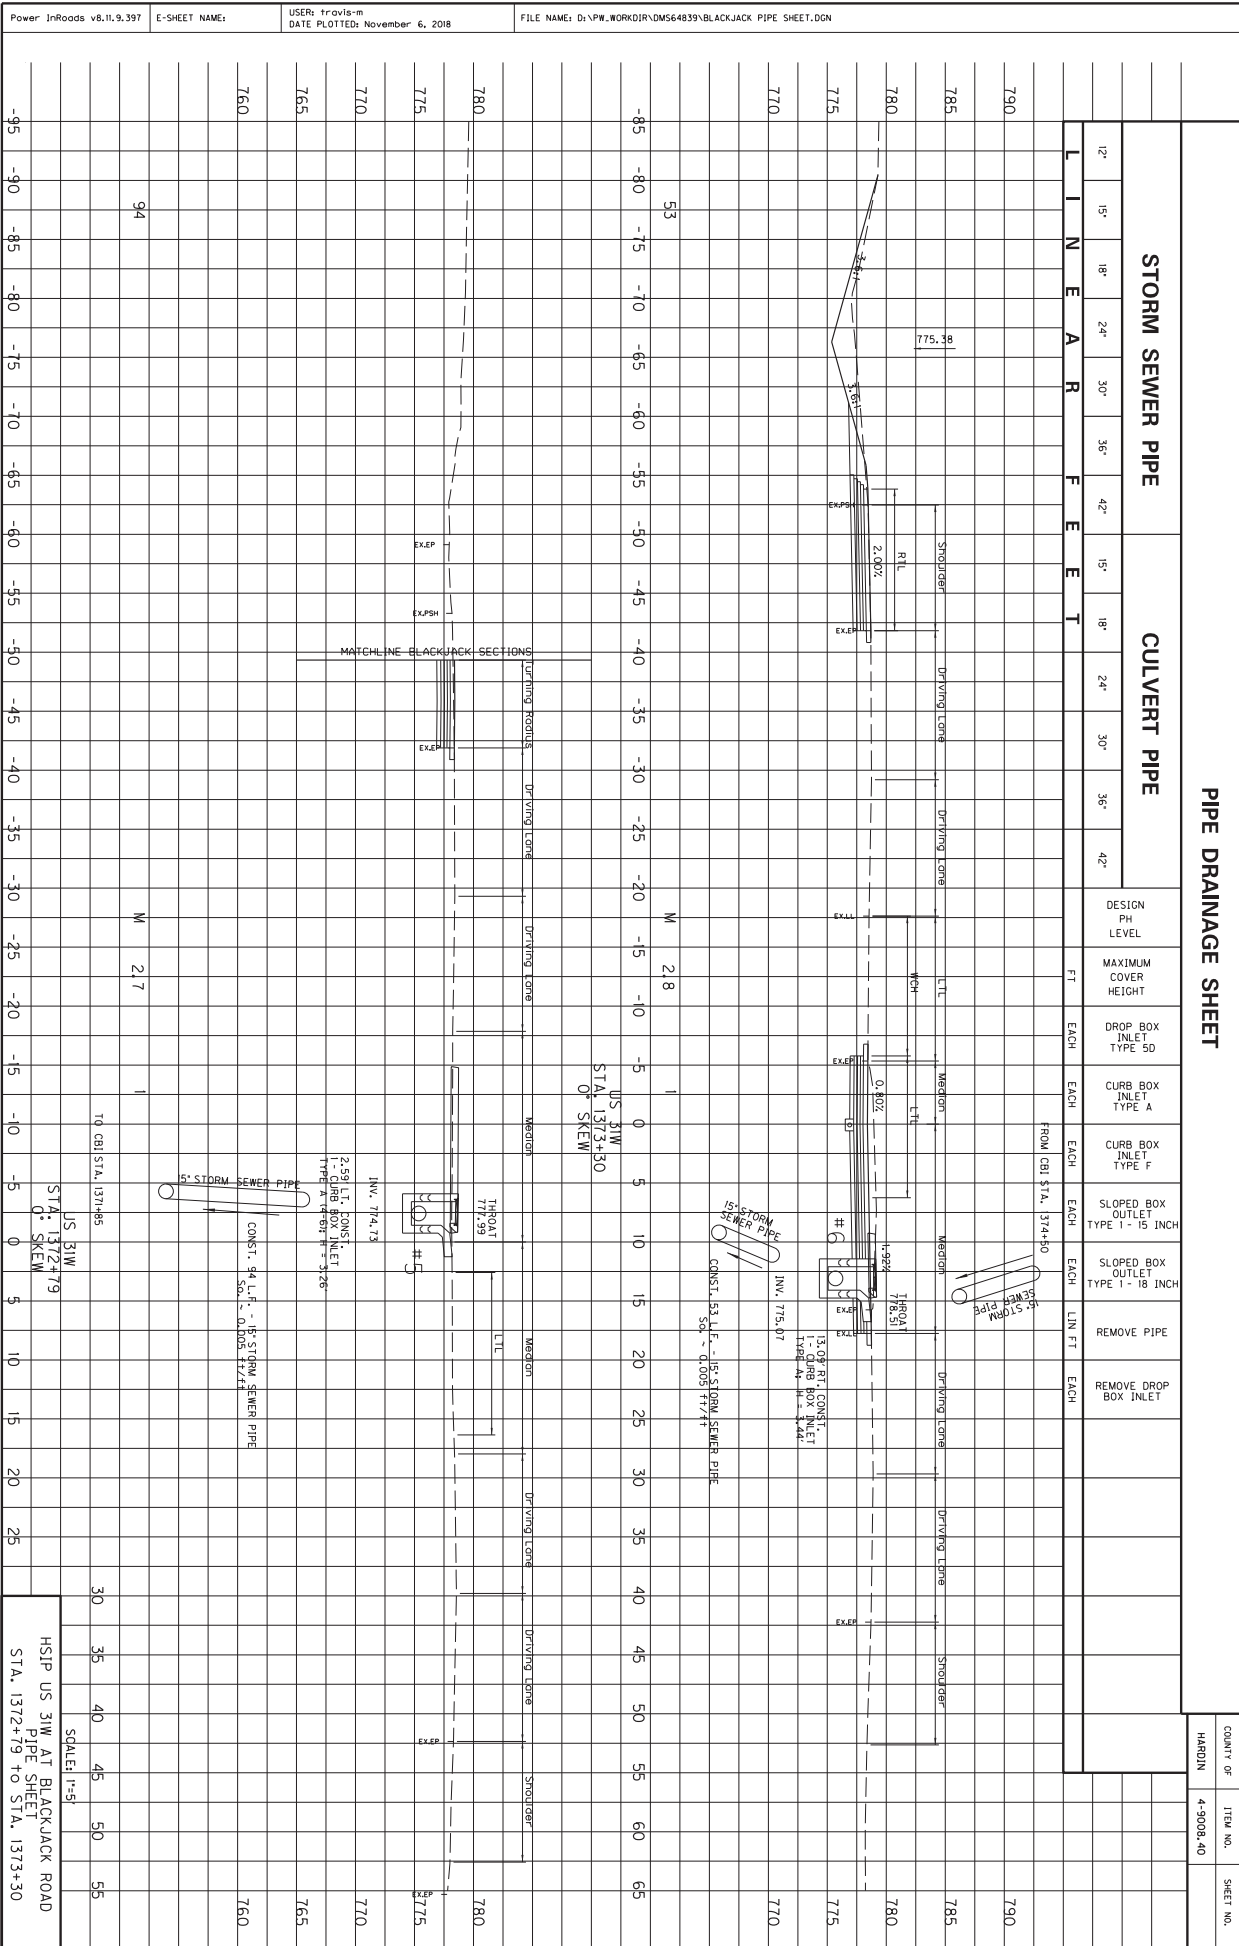

Power InRoads v8.11.9.397 E-SHEET NAME:

USER: travis-m DATE PLOTTED: November 6, 2018


FILE NAME: D:\PW_WORKDIR\DM564839\BLACKJACK PIPE SHEET.DGN

PIPE DRAINAGE SHEET
STORM SEWER PIPE
CULVERT PIPE


LINE	FEET	DESIGN PH LEVEL	MAXIMUM COVER HEIGHT	DROP BOX INLET TYPE 50	CURB BOX INLET TYPE A	CURB BOX INLET TYPE F	SLOPED BOX OUTLET TYPE 1 - 15 INCH	SLOPED BOX OUTLET TYPE 1 - 18 INCH	REMOVE PIPE	REMOVE DROP BOX INLET
12'	15'	18'	24'	30'	36'	42'				

COUNT OF	ITEM NO.	SHEET NO.
HARDIN	4-9008-40	

HSIP US 31W AT BLACKJACK ROAD
PIPE SHEET
STA. 1372+79 TO STA. 1373+30
SCALE: 1"=5'

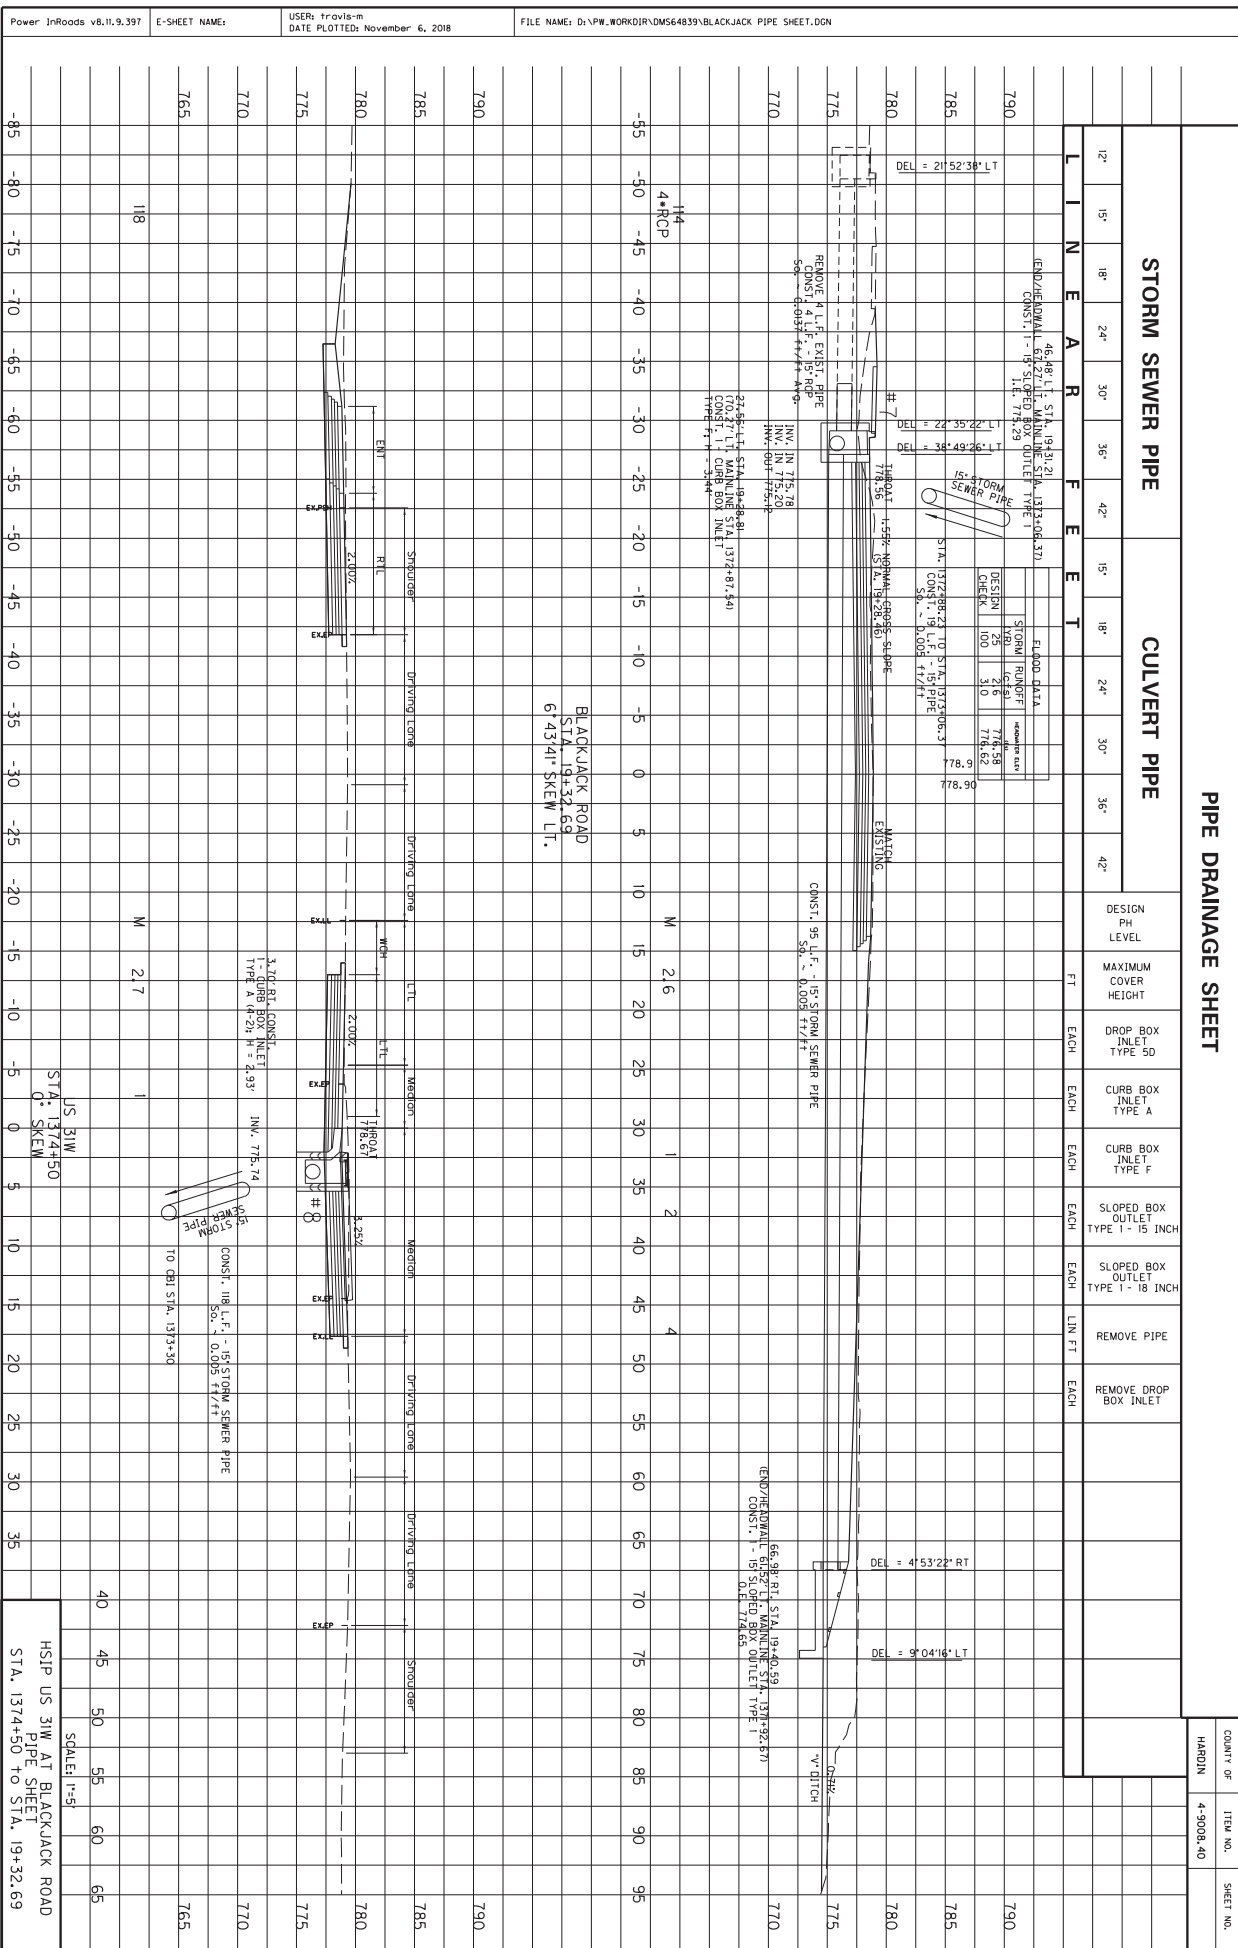

Power InRoads v8.11.9.397 E-SHEET NAME: USER: travis-m DATE PLOTTED: November 6, 2018 FILE NAME: D:\PW_WORKDIR\DM564832\BLACKJACK CROSS SECTIONS.DGN

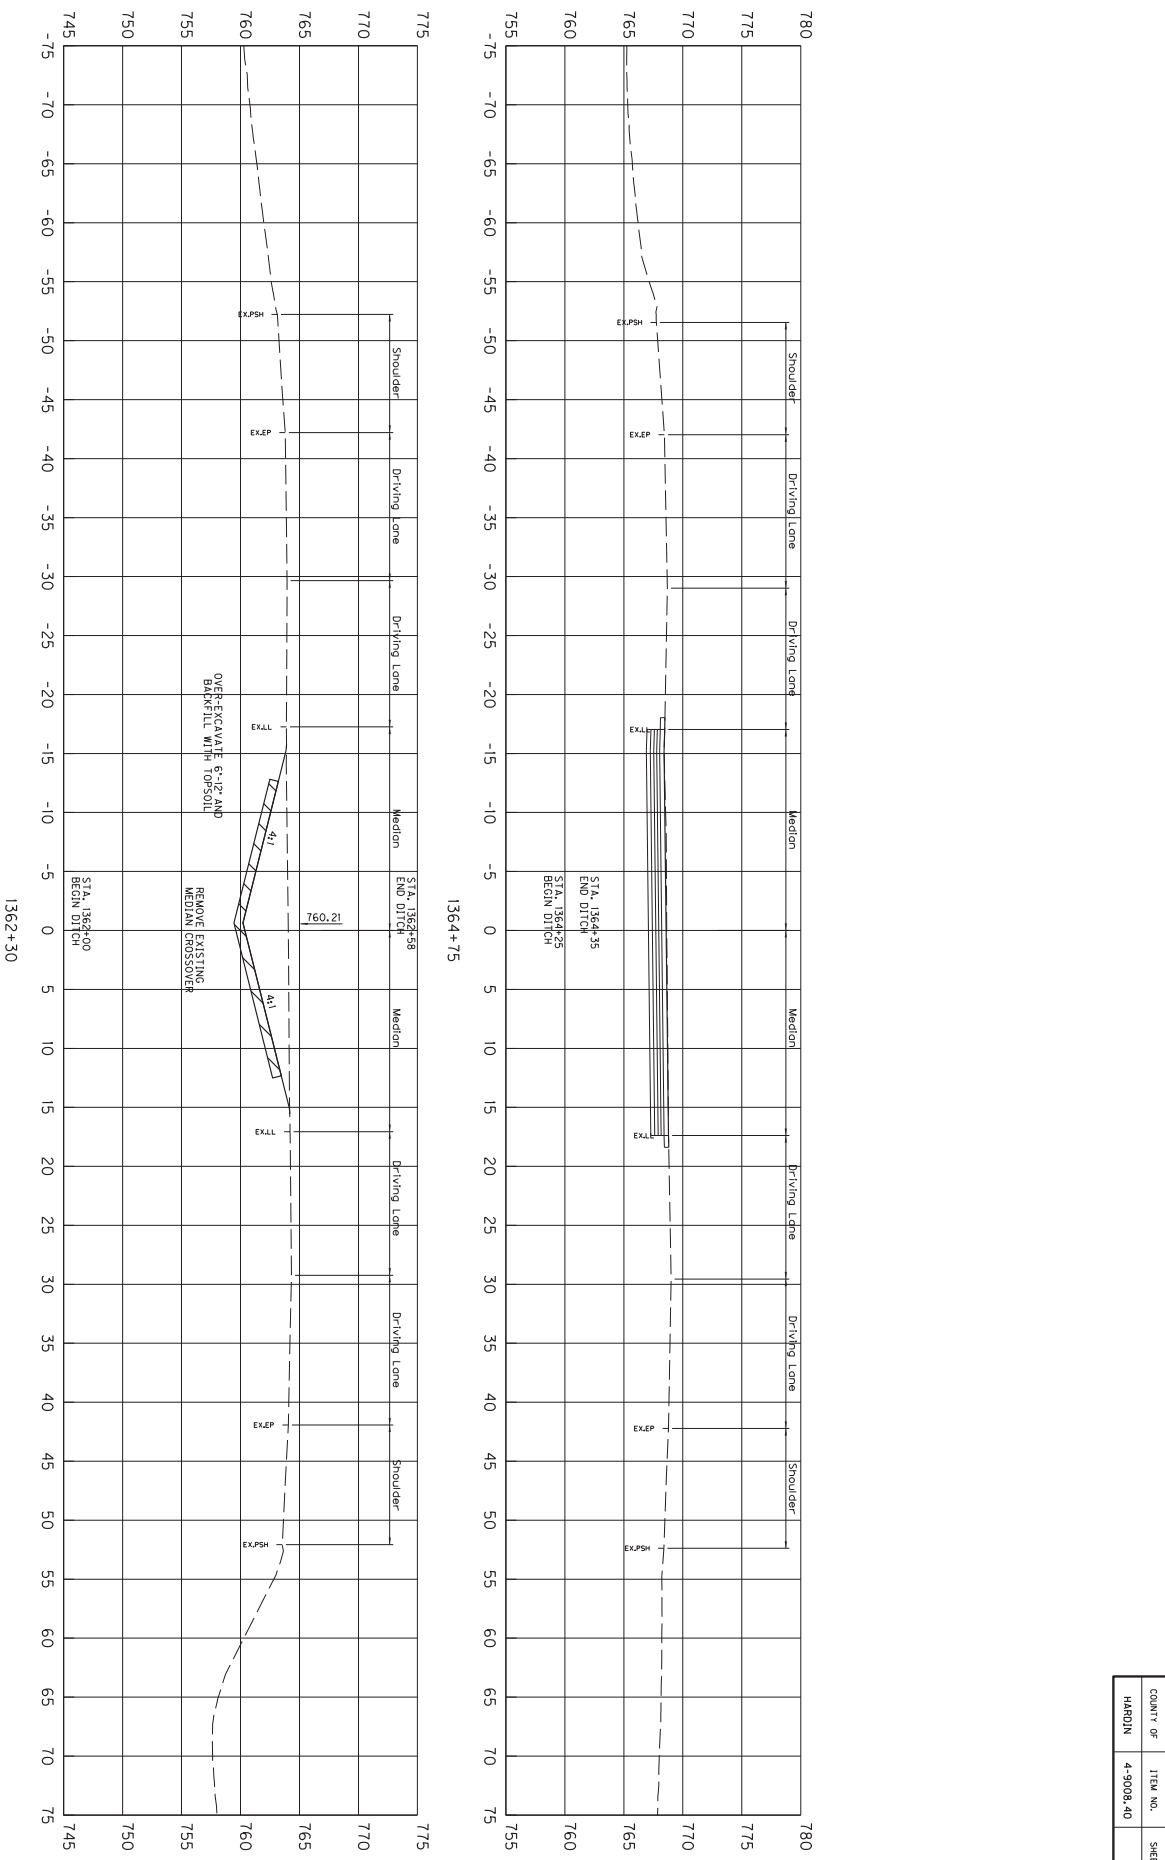


SCALE: H = 5' HORIZONTAL
V = 5' VERTICAL

HSIP US 31W AT BLACKJACK ROAD
CROSS SECTIONS
STA. 1362+30 TO STA. 1364+75

COUNTY OF	ITEM NO.	SHEET NO.
HARDIN	4-9008.40	


Power InRoads v8.11.9.397 E-SHEET NAME: USER: travis-m DATE PLOTTED: November 6, 2018 FILE NAME: D:\PW_WORKDIR\DM564832\BLACKJACK CROSS SECTIONS.DGN

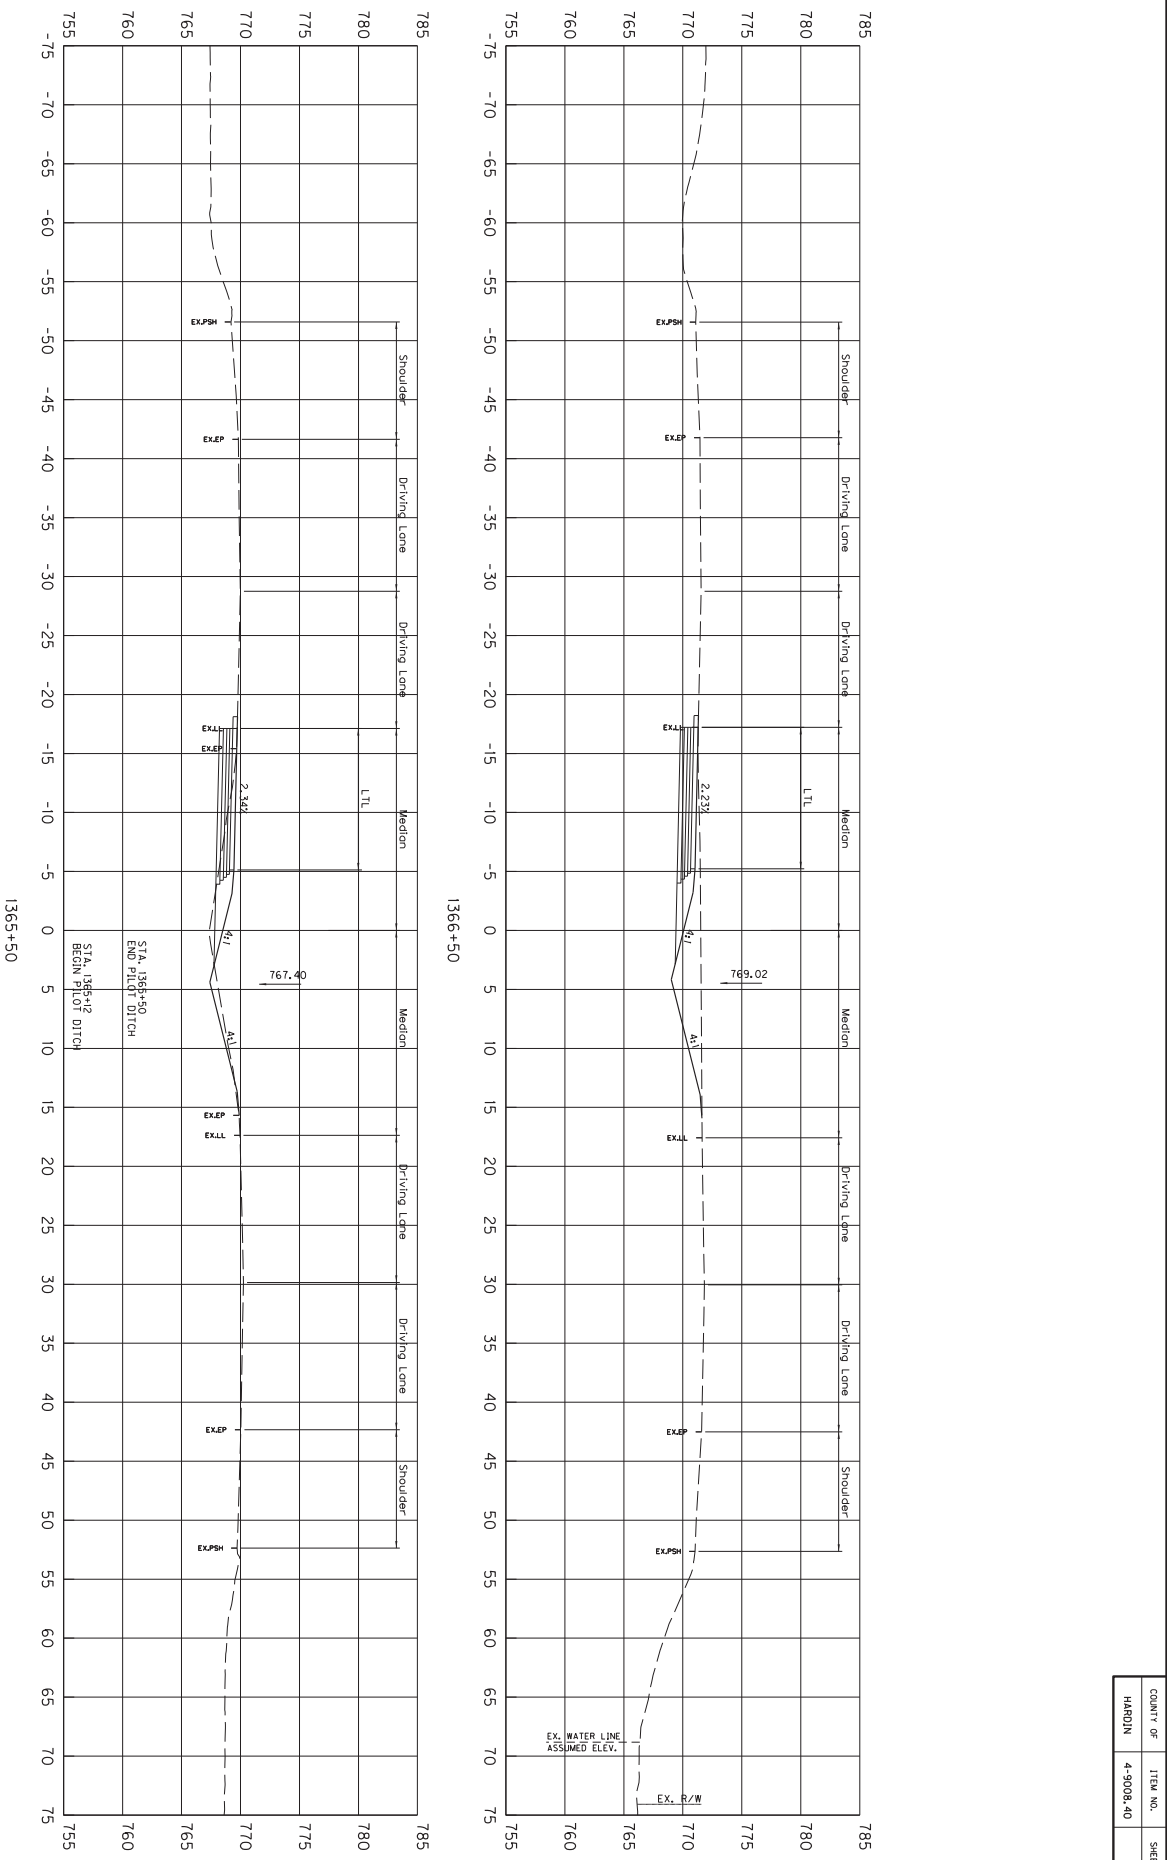

SCALE: H = 5' HORIZONTAL
V = 5' VERTICAL

HSIP US 31W AT BLACKJACK ROAD
CROSS SECTIONS
STA. 1365+50 TO STA. 1366+50


COUNTY OF	ITEM NO.	SHEET NO.
HARDIN	4-9008.40	

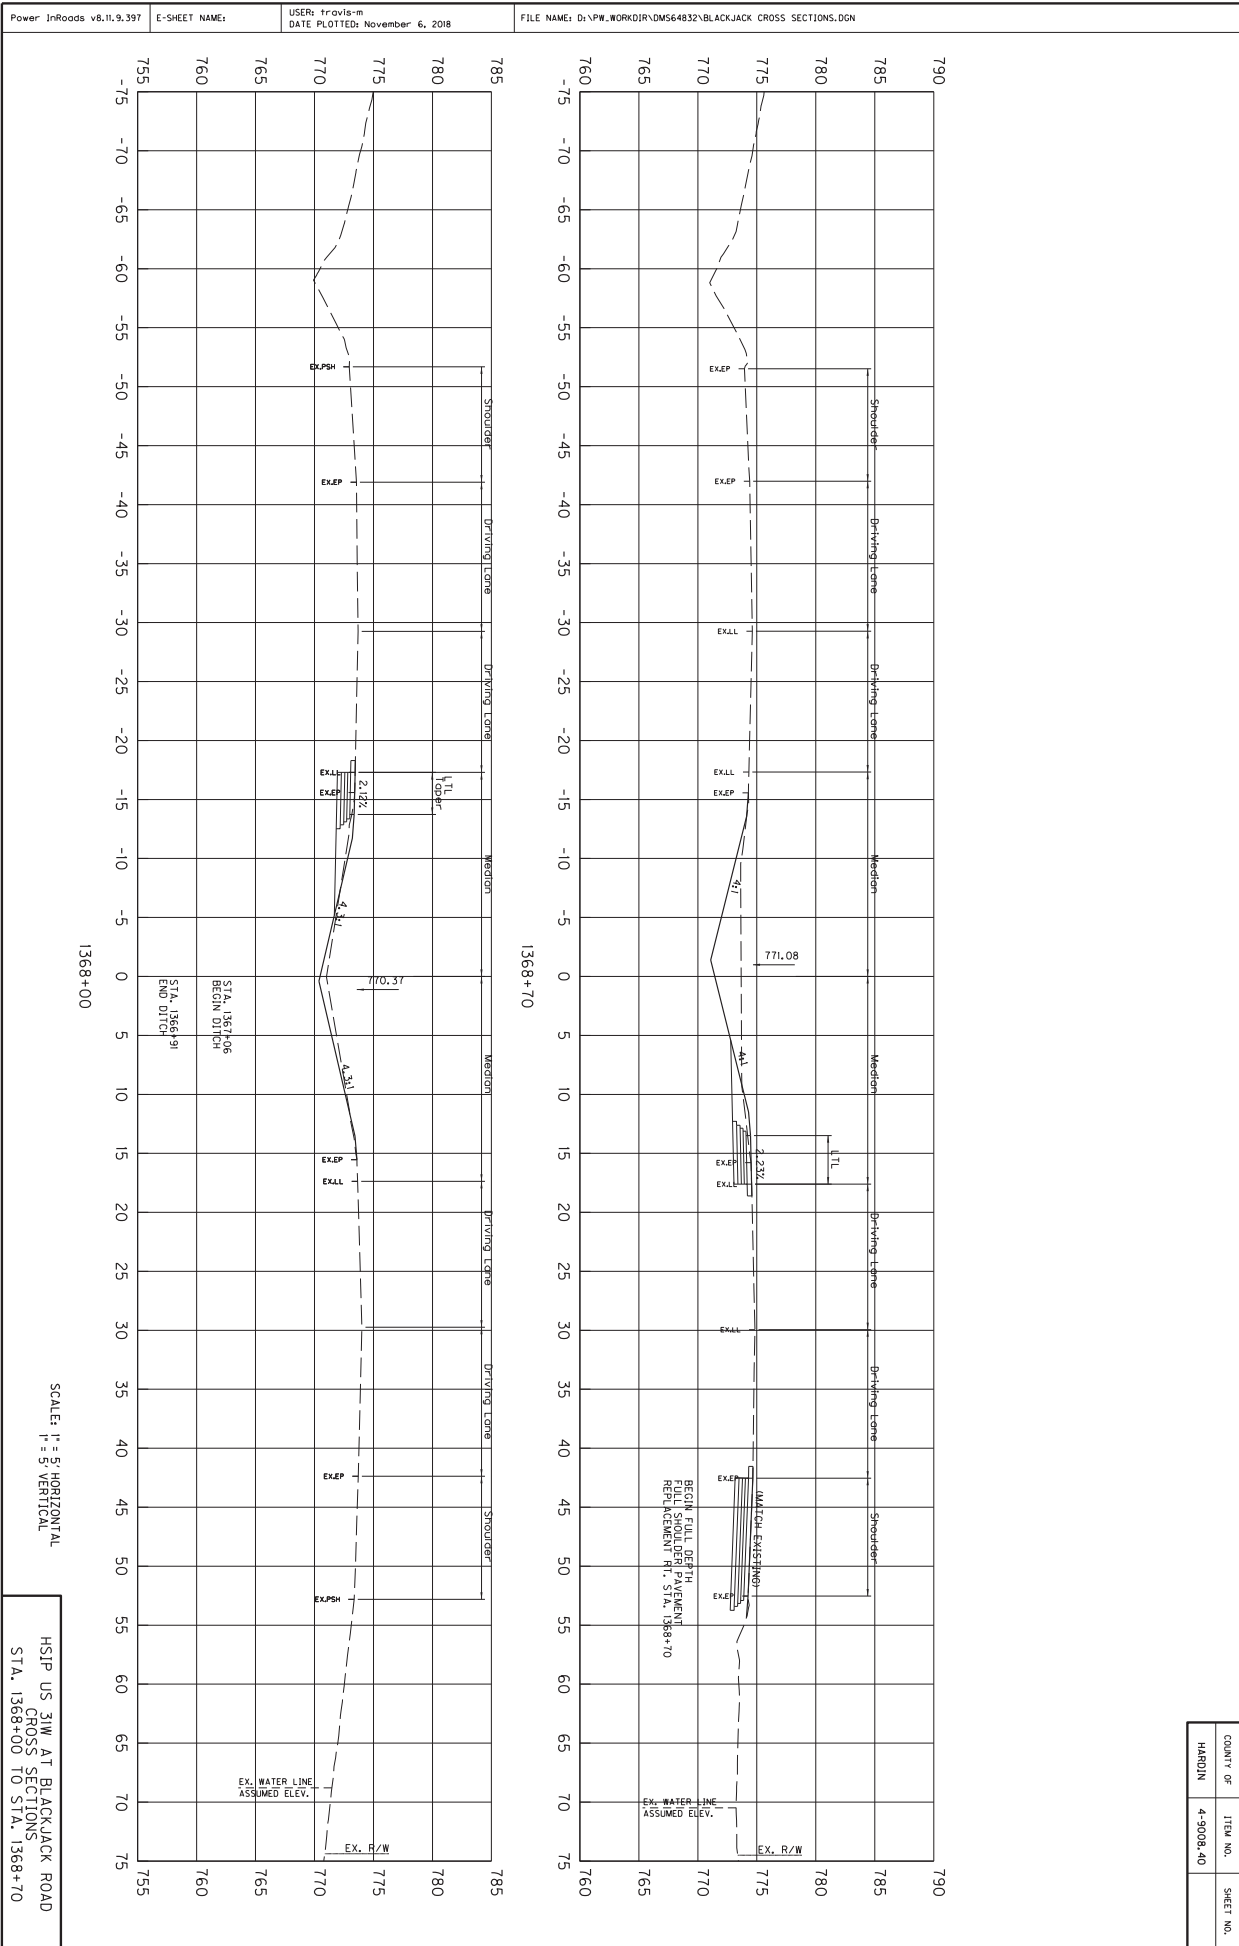

SCALE: H = 5' HORIZONTAL
V = 5' VERTICAL

HSIP US 31W AT BLACKJACK ROAD
CROSS SECTIONS
STA. 1368+00 TO STA. 1368+70


COUNTY OF	ITEM NO.	SHEET NO.
HARDIN	4-9008.40	

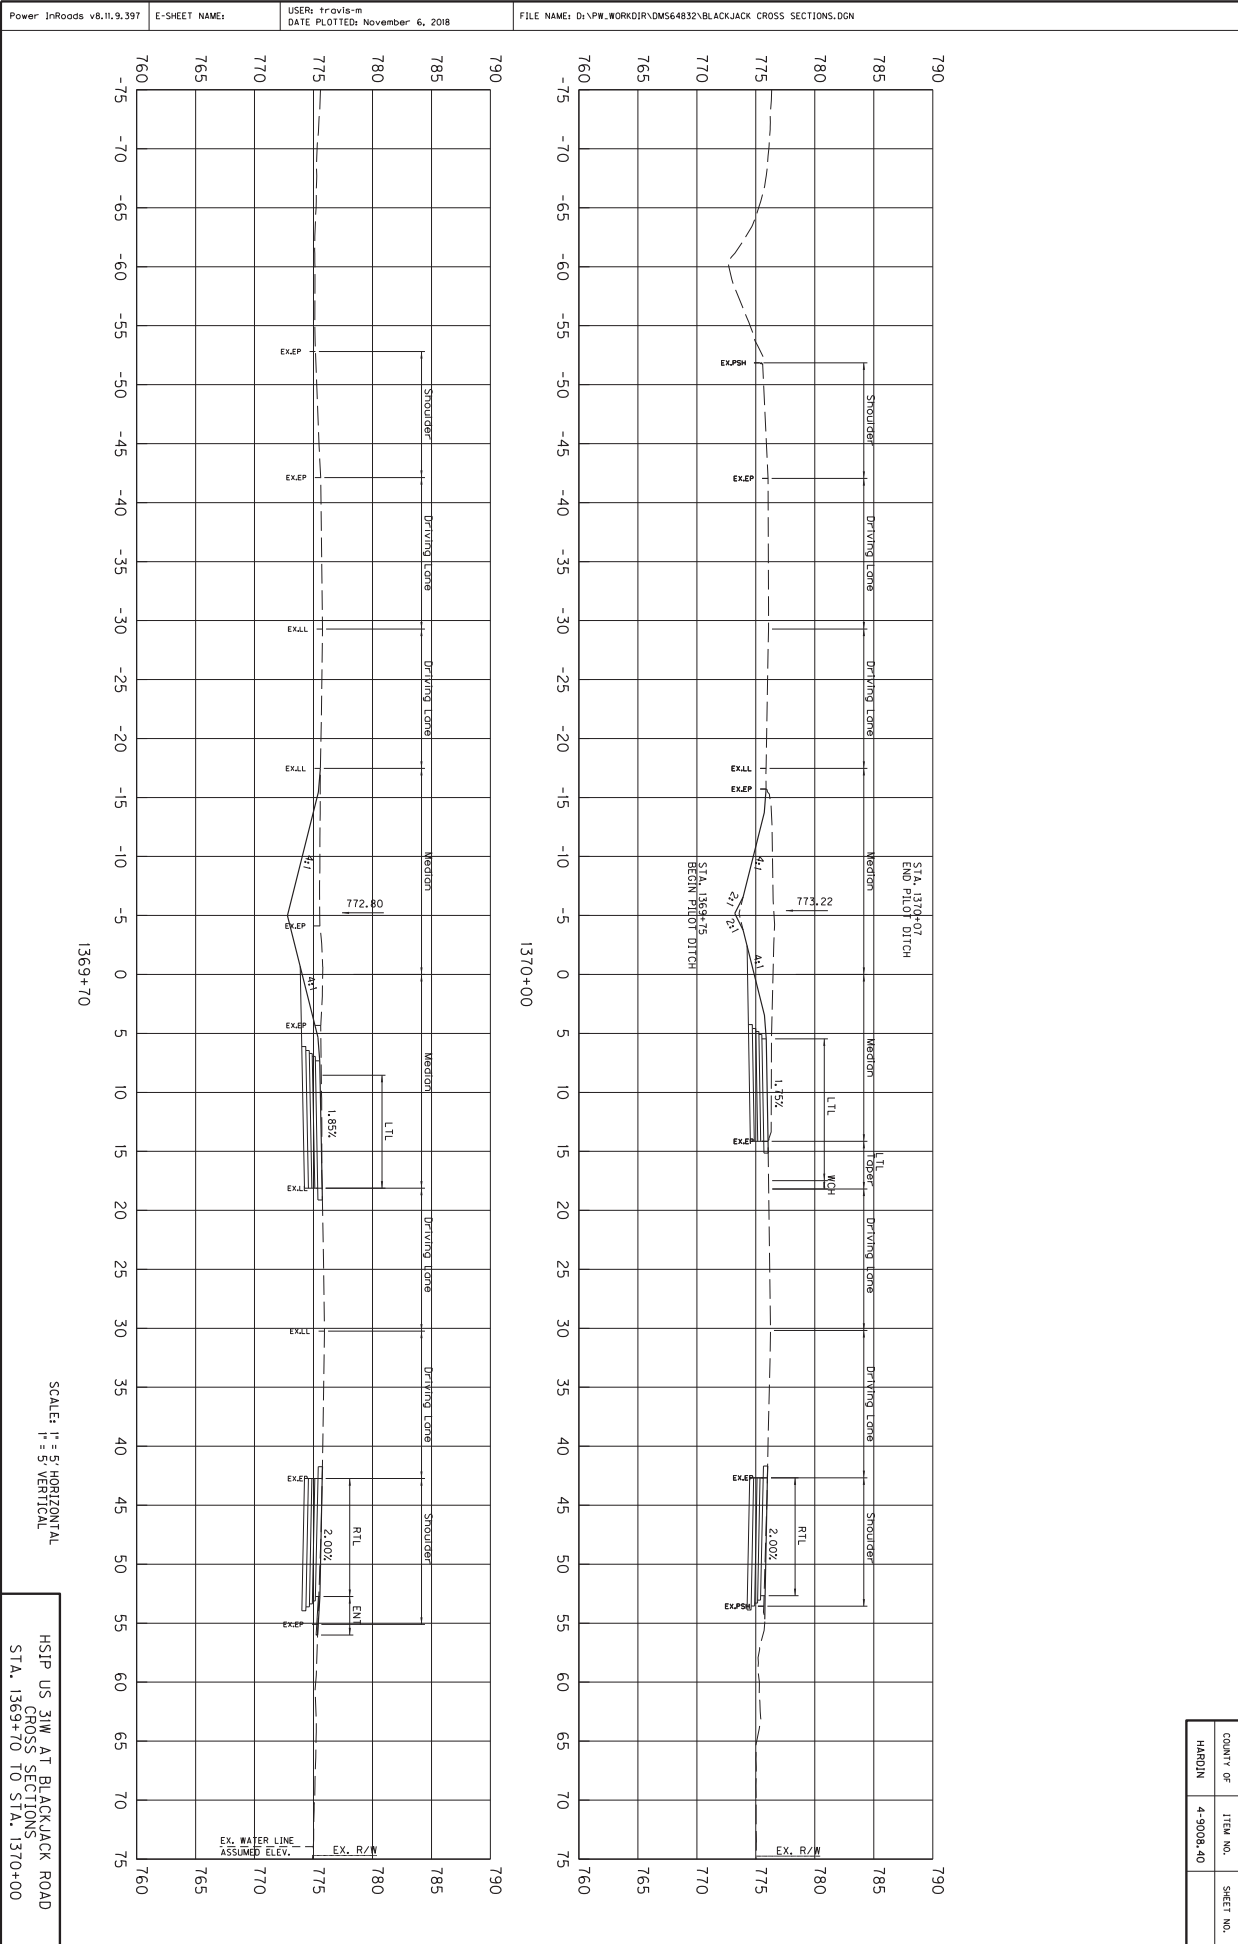

SCALE: H = 5' HORIZONTAL
V = 5' VERTICAL

HSIP US 31W AT BLACKJACK ROAD
CROSS SECTIONS
STA. 1369+70 TO STA. 1370+00

COUNTY OF	ITEM NO.	SHEET NO.
HARDIN	4-9008.40	

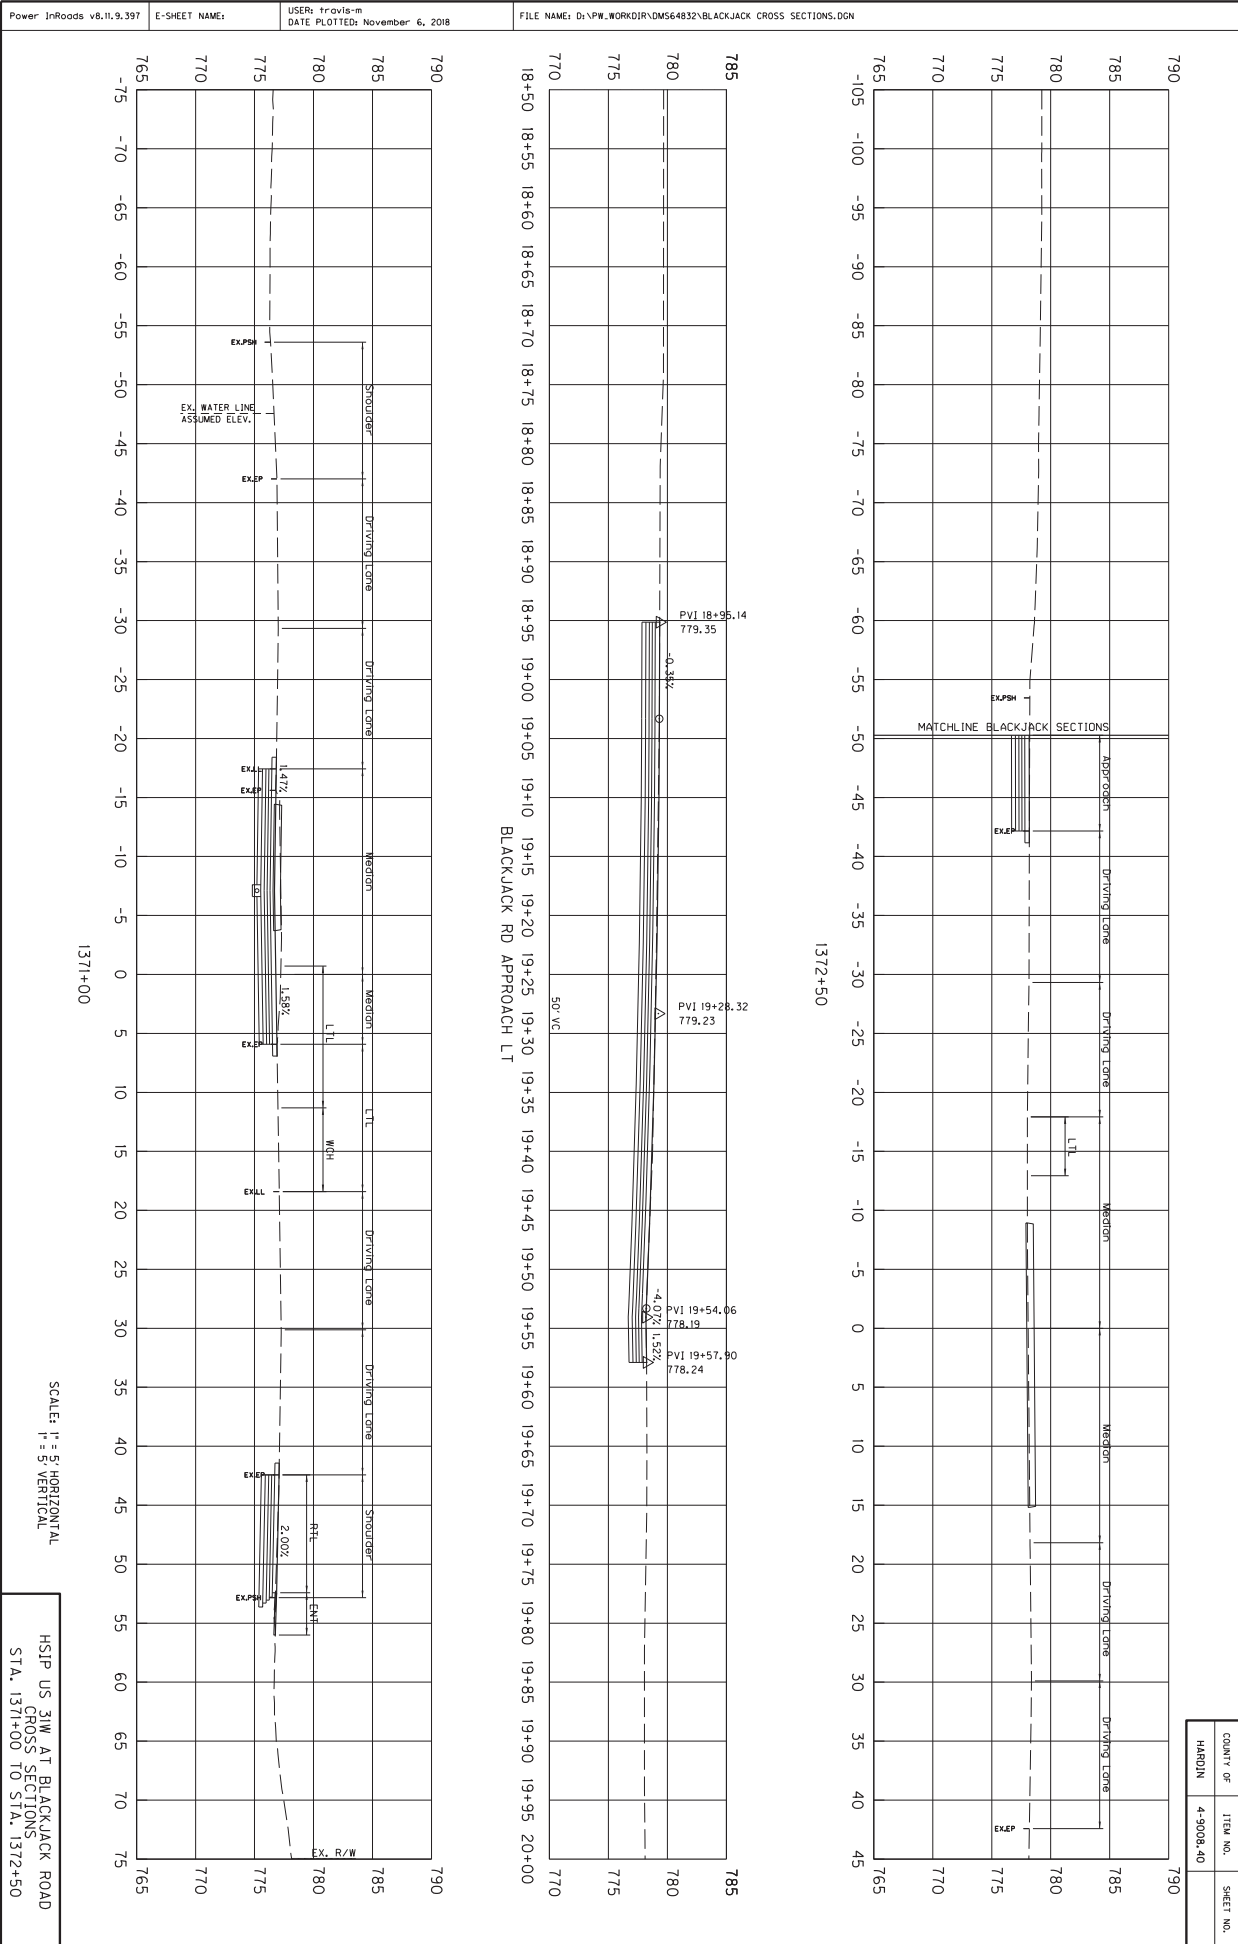

1371+00



1372+50

SCALE: H = 5' HORIZONTAL
V = 5' VERTICAL

HSIP US 31W AT BLACKJACK ROAD
CROSS SECTIONS
STA. 1371+00 TO STA. 1372+50

COUNTY OF	ITEM NO.	SHEET NO.
HARDIN	4-9008.40	

Power InRoads v8.11.9.397 E-SHEET NAME: USER: travis-m DATE PLOTTED: November 6, 2018 FILE NAME: D:\PW\WORKDIR\DM564832\BLACKJACK CROSS SECTIONS.DGN

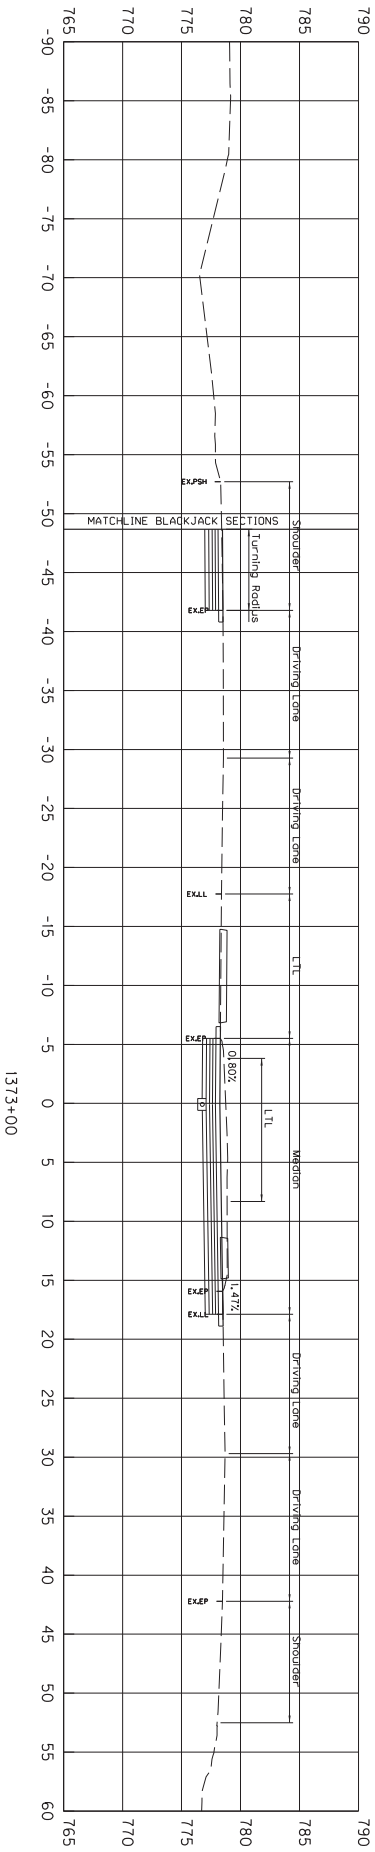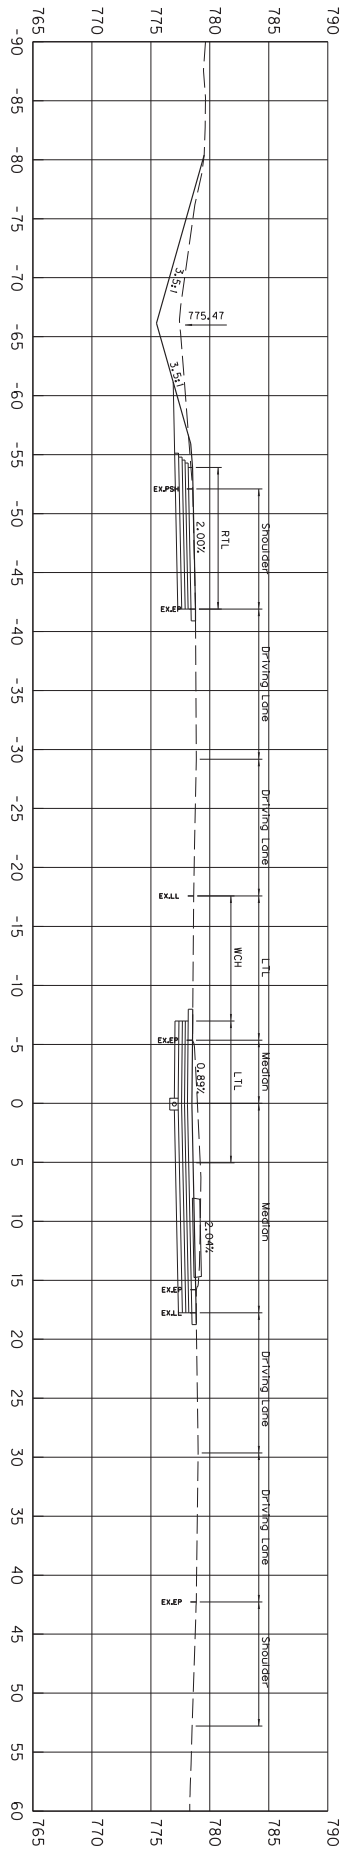


1373+00

1373+50

SCALE: H = 5 HORIZONTAL
V = 5 VERTICAL

HSIP US 31W AT BLACKJACK ROAD
CROSS SECTIONS
STA. 1373+00 TO STA. 1373+50

COUNTY OF	ITEM NO.	SHEET NO.
HARDIN	4-9008.40	

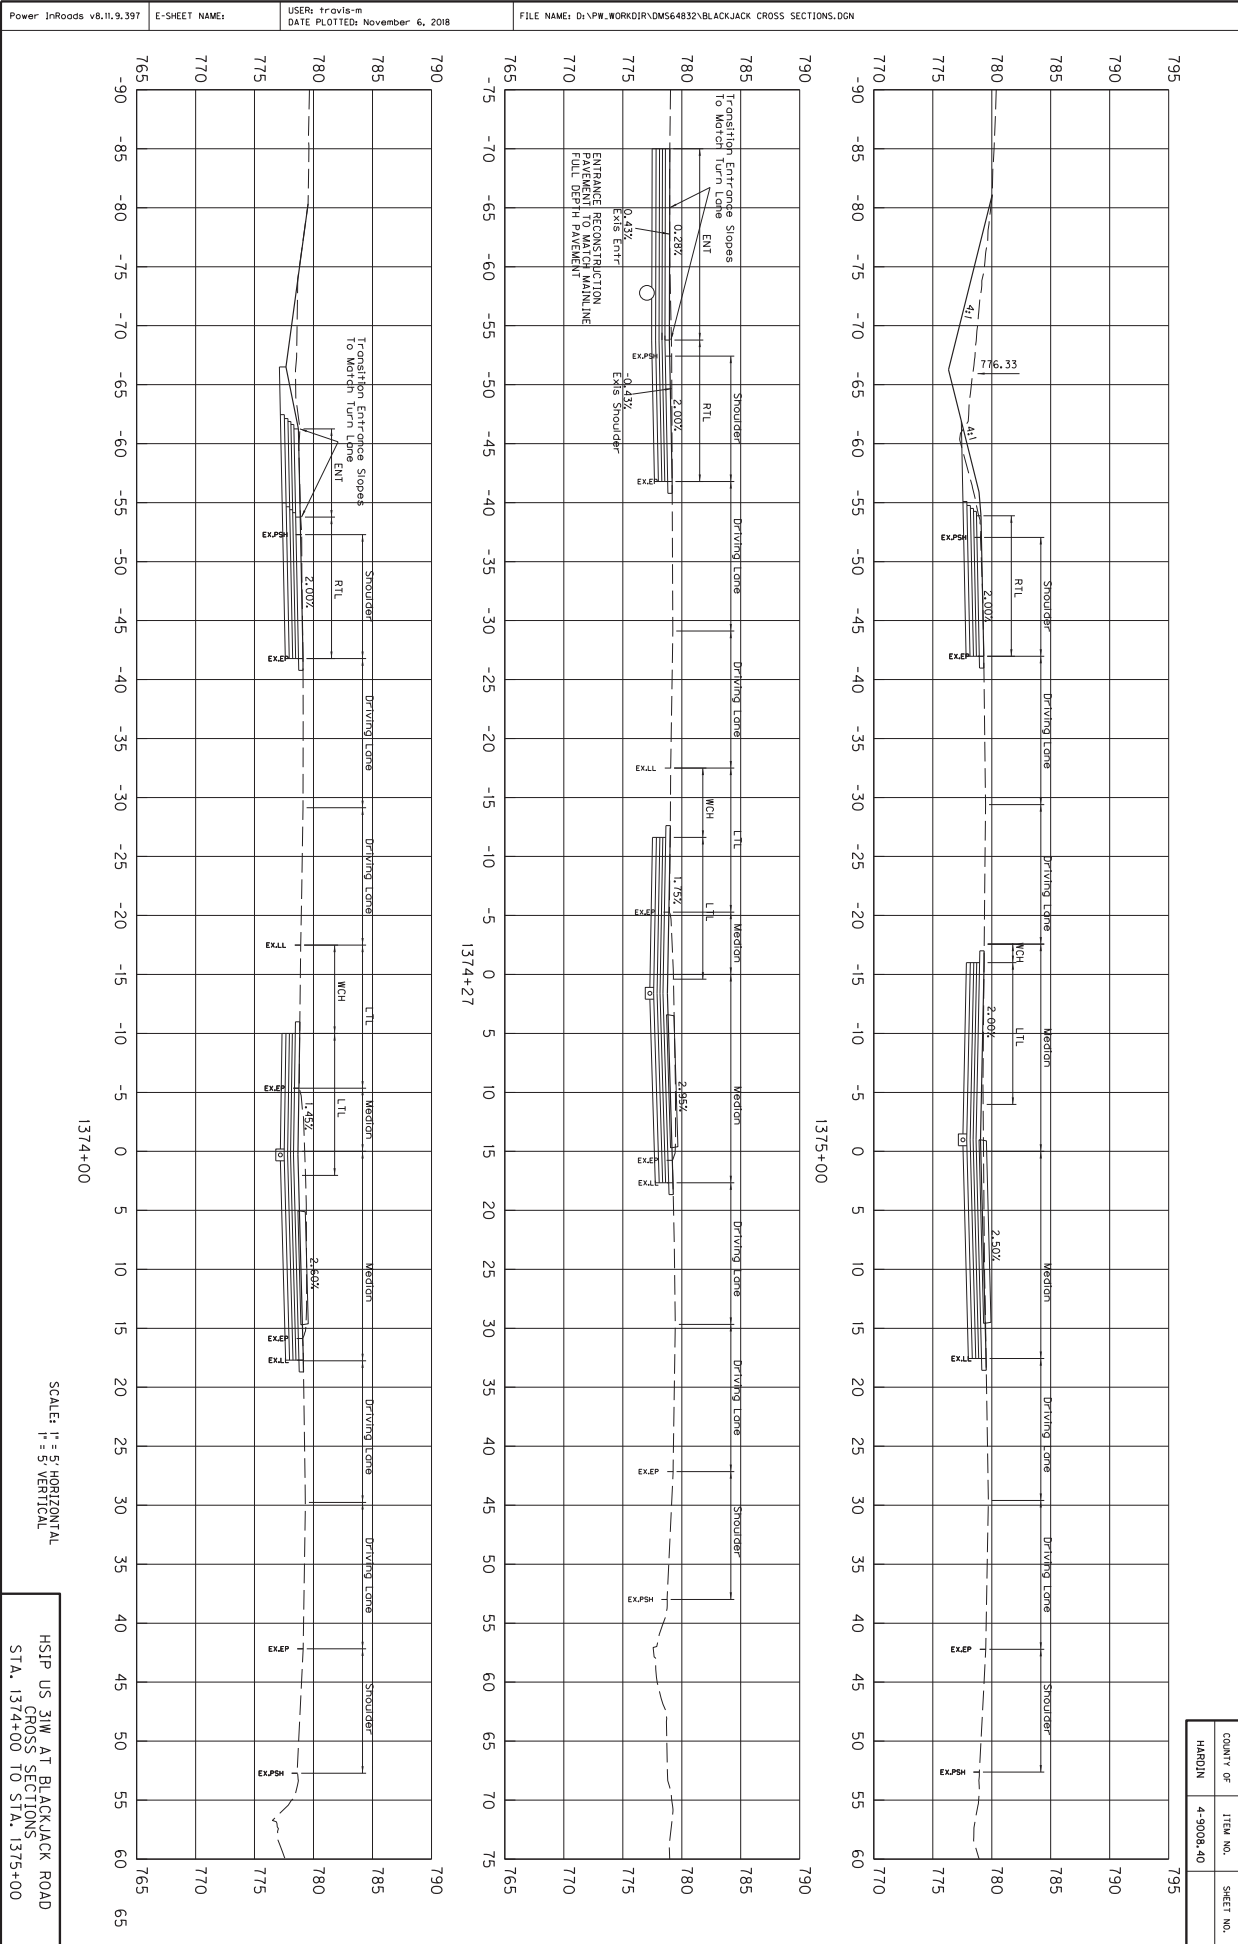

1374+00

1374+27


1375+00

SCALE: H = 5 HORIZONTAL
V = 5 VERTICAL

HSIP US 31W AT BLACKJACK ROAD
CROSS SECTIONS
STA. 1374+00 TO STA. 1375+00

COUNTY OF	ITEM NO.	SHEET NO.
HARDIN	4-9008.40	

Power InRoads v8.11.9.397 E-SHEET NAME: USER: travis-m DATE PLOTTED: November 6, 2018 FILE NAME: D:\PW_WORKDIR\DM564832\BLACKJACK CROSS SECTIONS.DGN


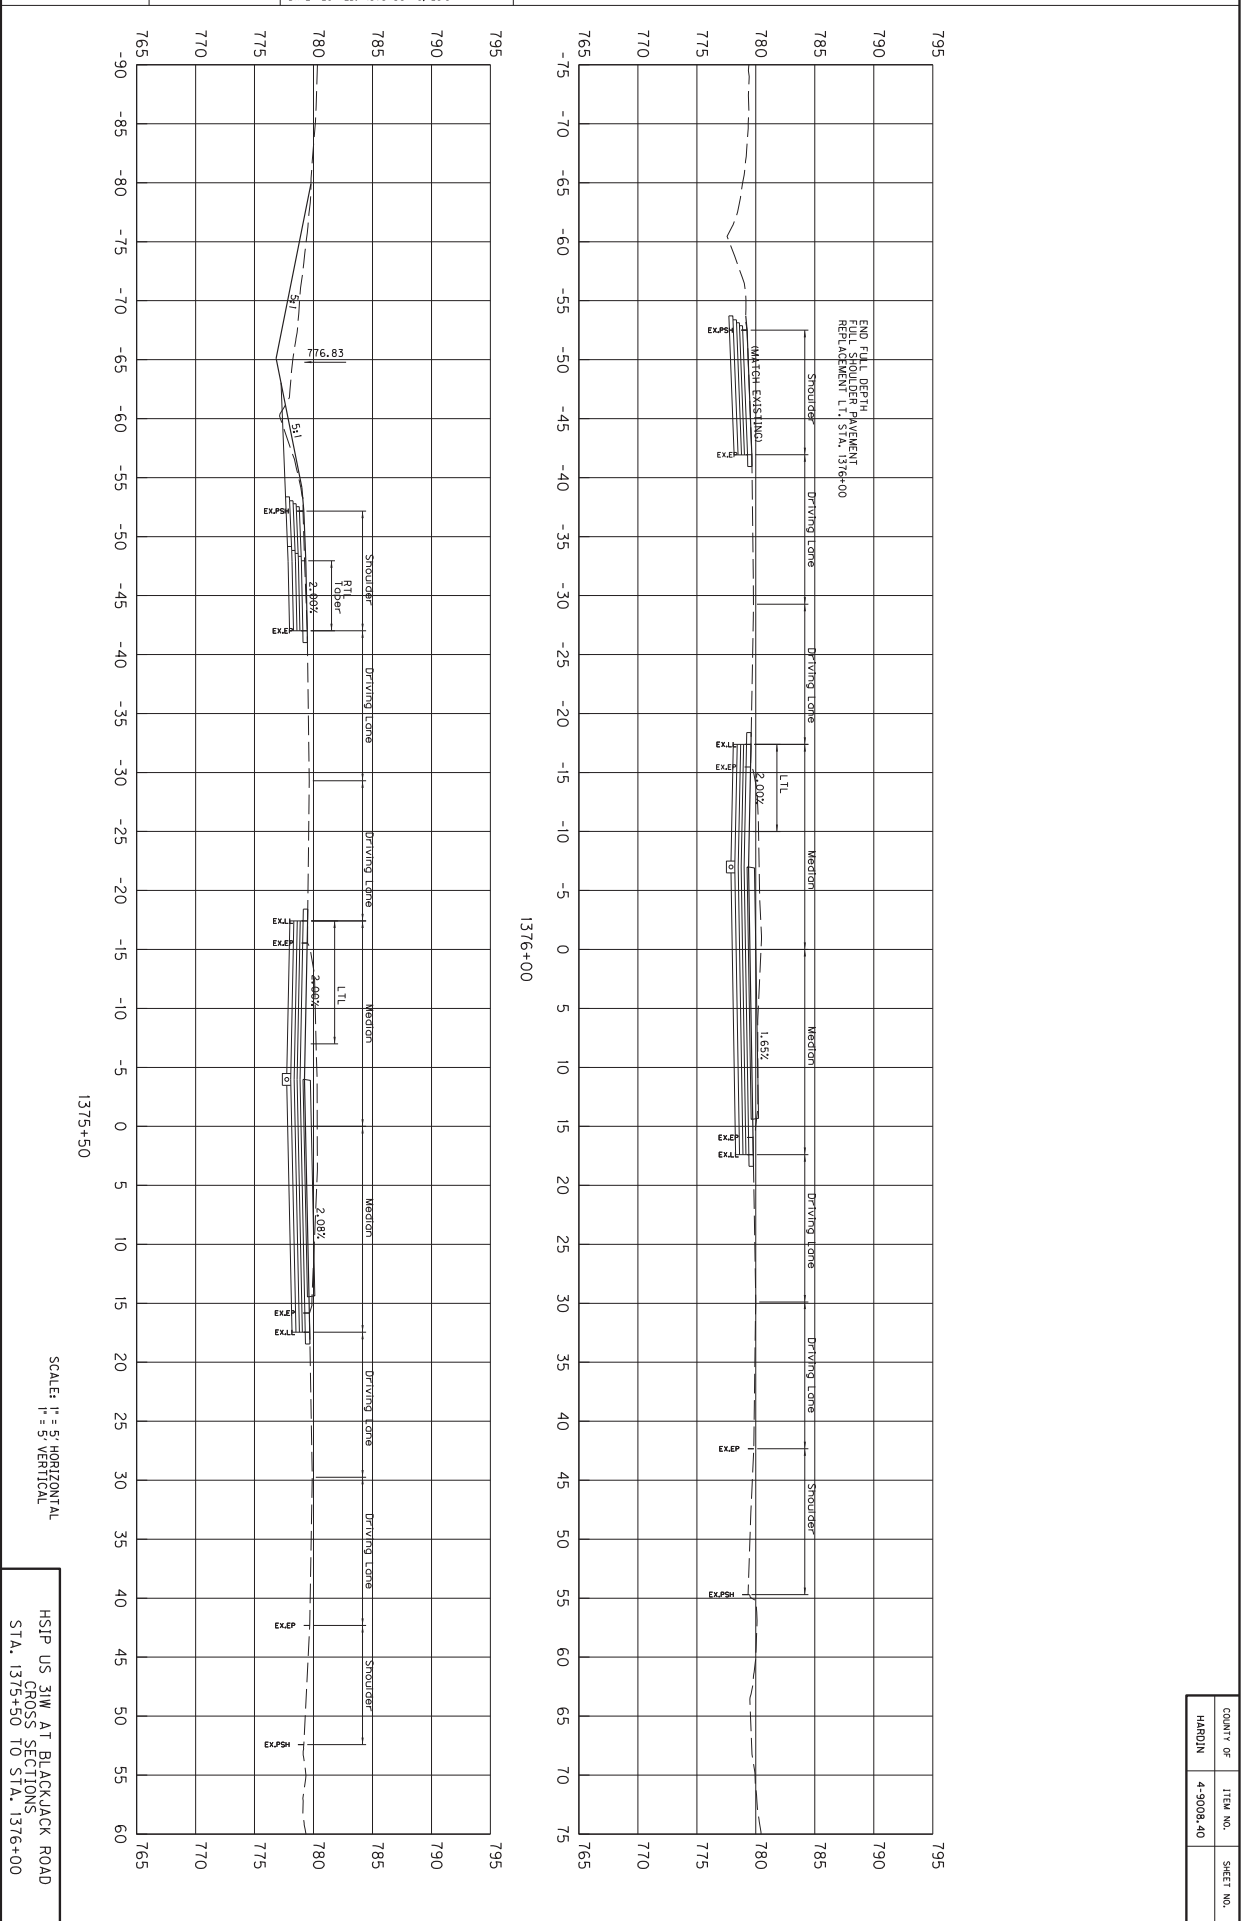


SCALE: H = 5' HORIZONTAL
V = 5' VERTICAL

HSIP US 31W AT BLACKJACK ROAD
CROSS SECTIONS
STA. 1375+50 TO STA. 1376+00

COUNTY OF	ITEM NO.	SHEET NO.
HARDIN	4-9008.40	

Power InRoads v8.11.9.397 E-SHEET NAME: USER: travis-m DATE PLOTTED: November 6, 2018 FILE NAME: D:\PW\WORKDIR\DM564832\BLACKJACK CROSS SECTIONS.DGN

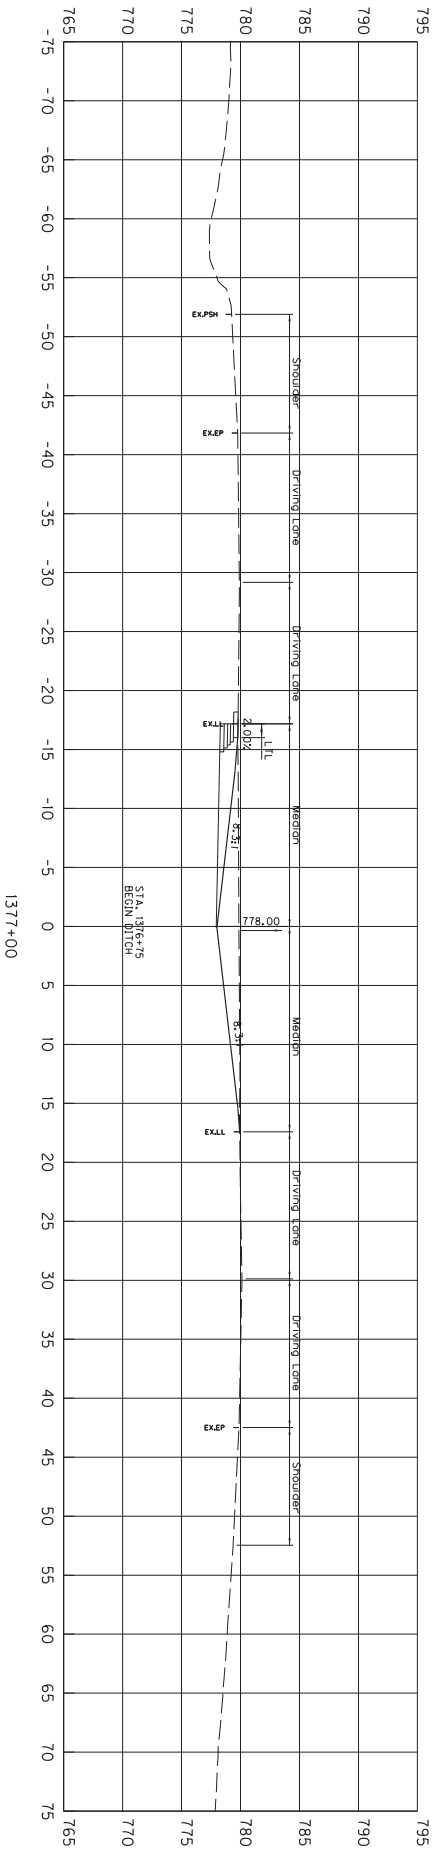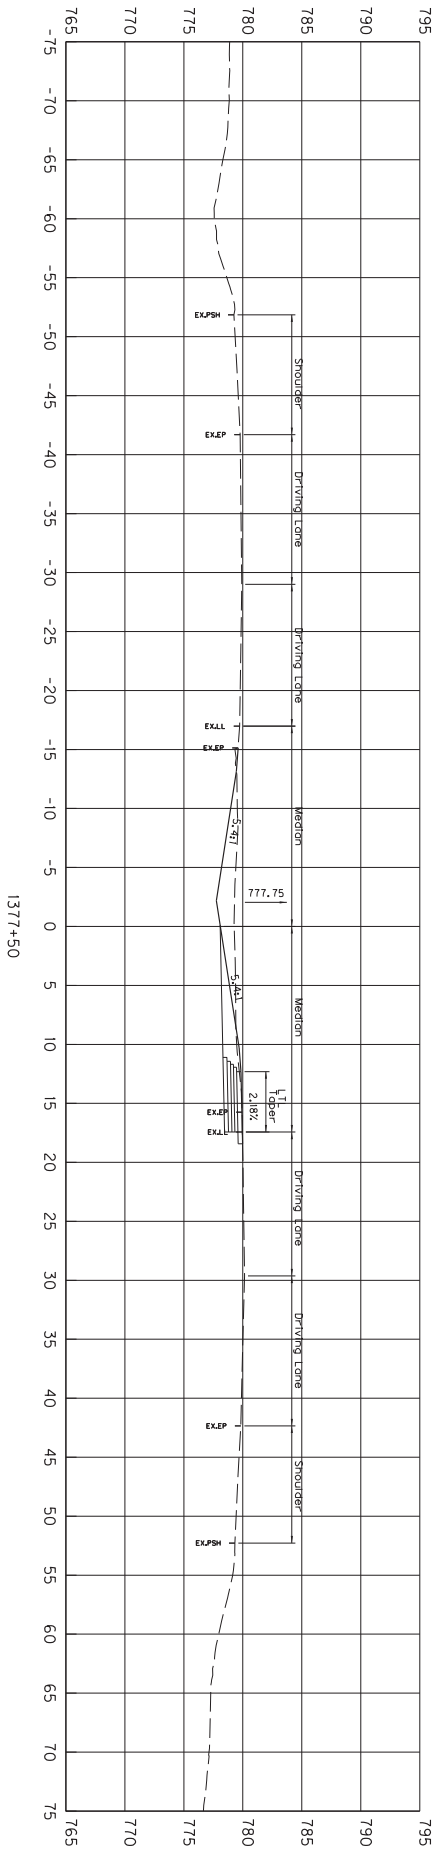


SCALE: H = 5' HORIZONTAL
V = 5' VERTICAL

HSIP US 31W AT BLACKJACK ROAD
CROSS SECTIONS
STA. 1377+00 TO STA. 1377+50

COUNTY OF	ITEM NO.	SHEET NO.
HARDIN	4-9008.40	


Power InRoads v8.11.9.397 E-SHEET NAME: USER: travis-m DATE PLOTTED: November 6, 2018 FILE NAME: D:\PW\WORKDIR\DM564832\BLACKJACK CROSS SECTIONS.DGN

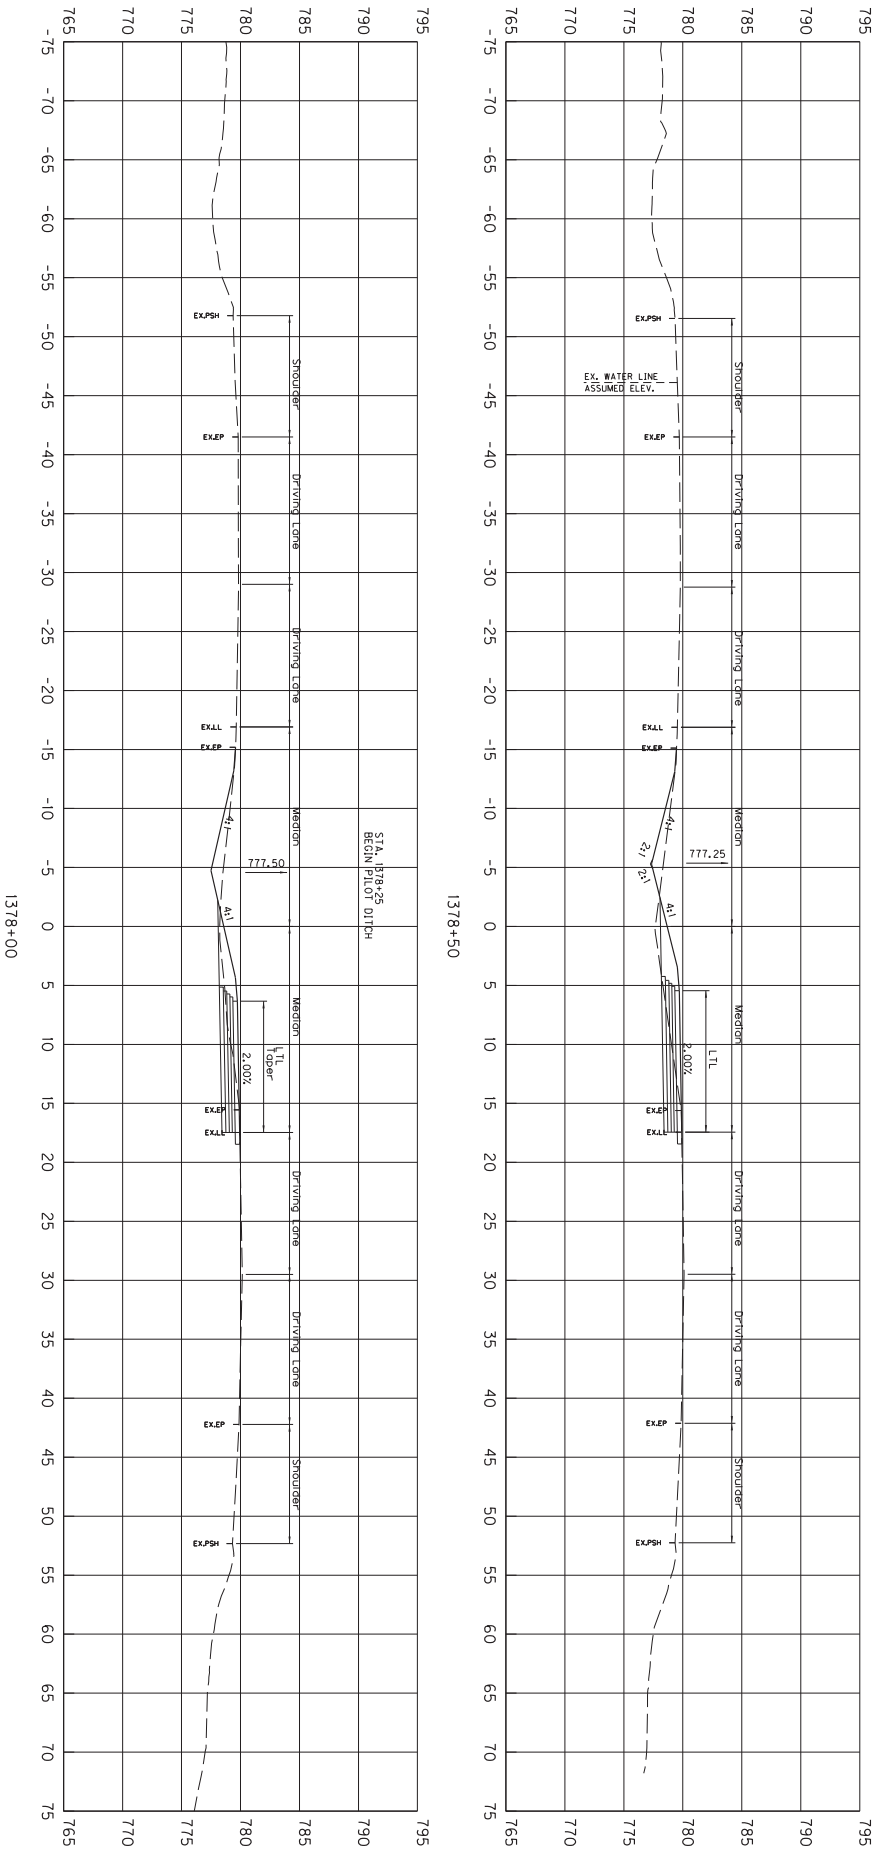

SCALE: H = 5' HORIZONTAL
V = 5' VERTICAL

HSIP US 31W AT BLACKJACK ROAD
CROSS SECTIONS
STA. 1378+00 TO STA. 1378+50


COUNTY OF	ITEM NO.	SHEET NO.
HARDIN	4-9008.40	

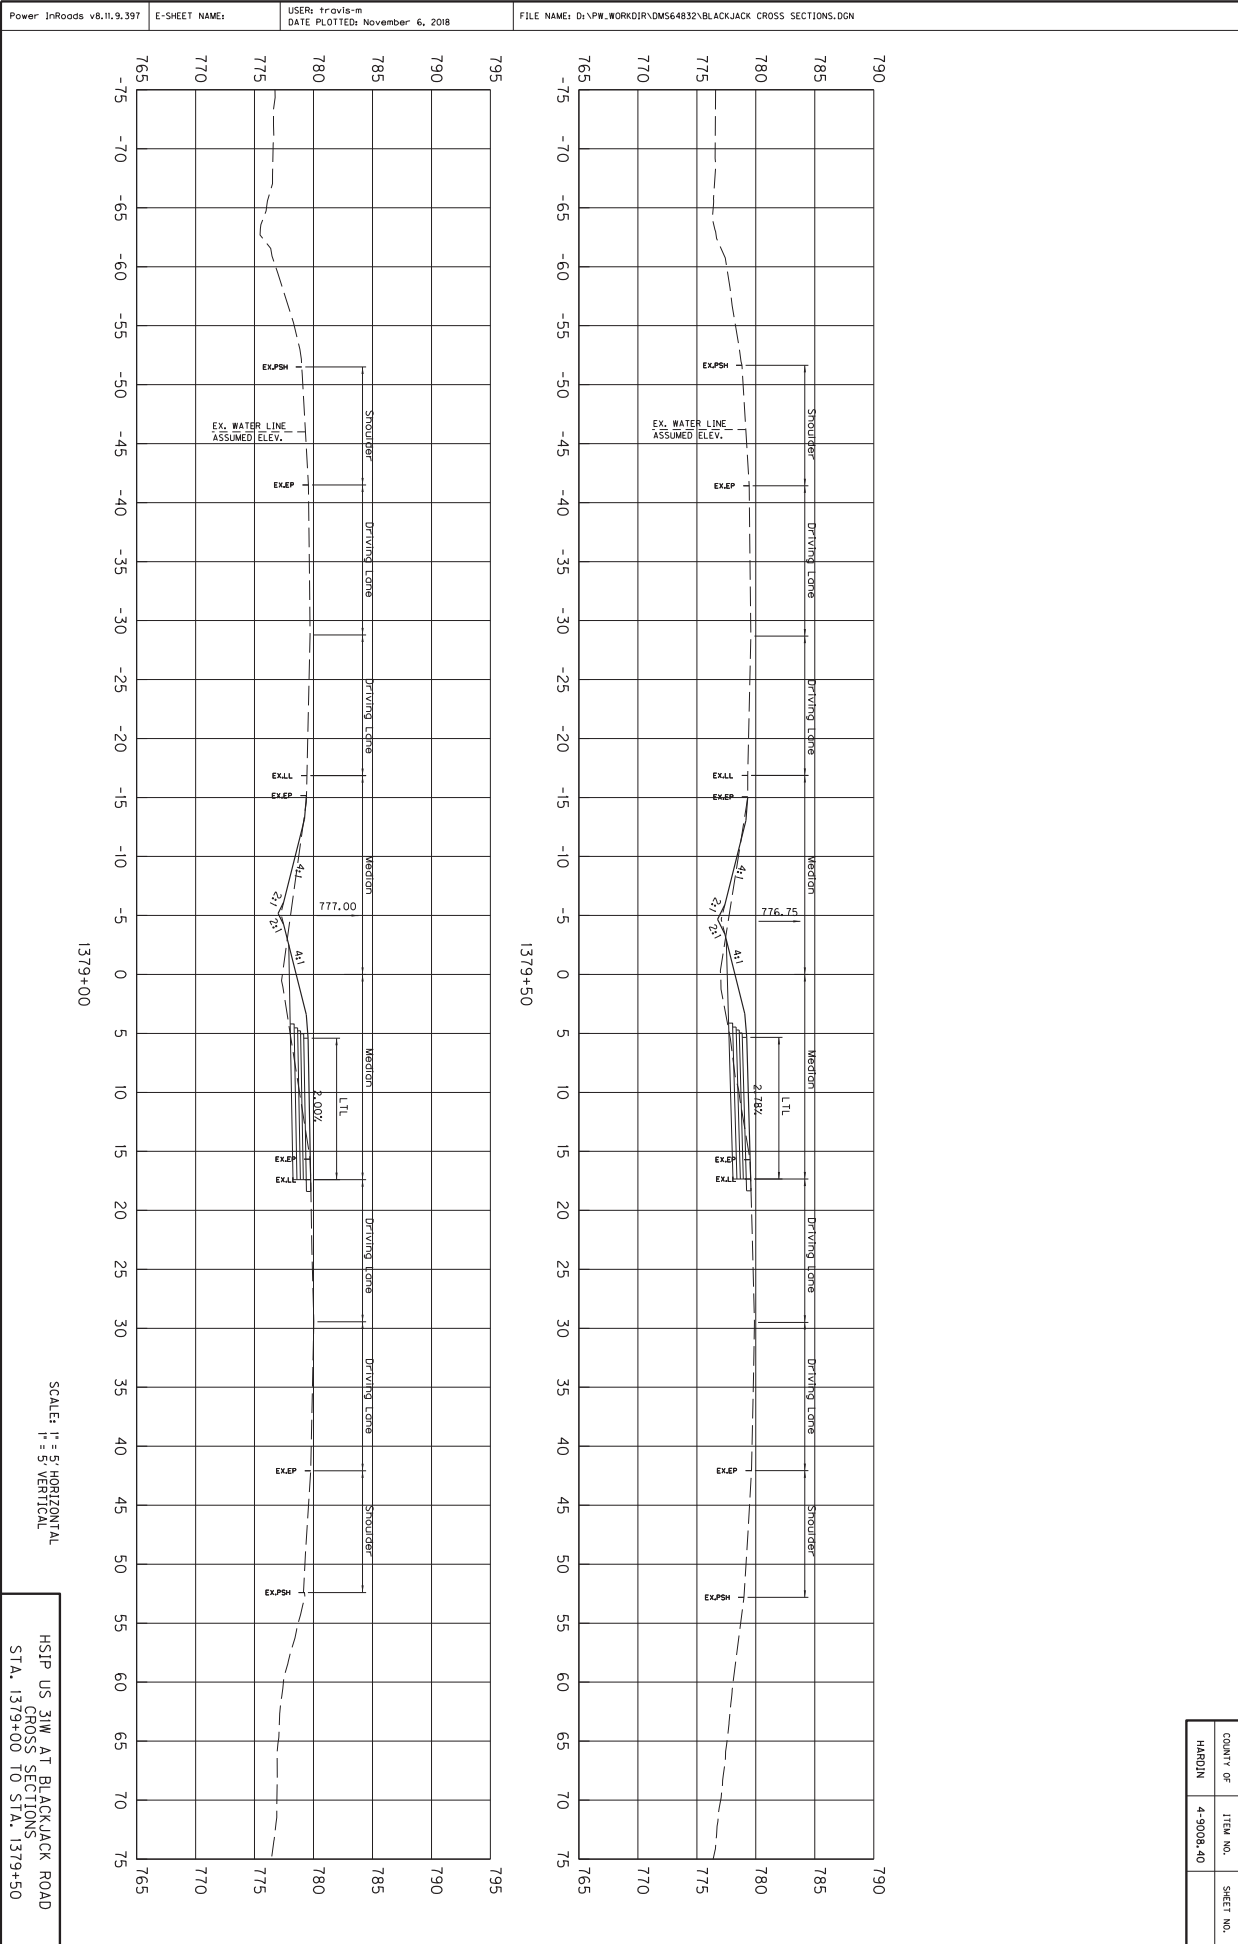

SCALE: H = 5' HORIZONTAL
V = 5' VERTICAL

HSIP US 31W AT BLACKJACK ROAD
CROSS SECTIONS
STA. 1379+00 TO STA. 1379+50

COUNTY OF	ITEM NO.	SHEET NO.
HARDIN	4-9008.40	

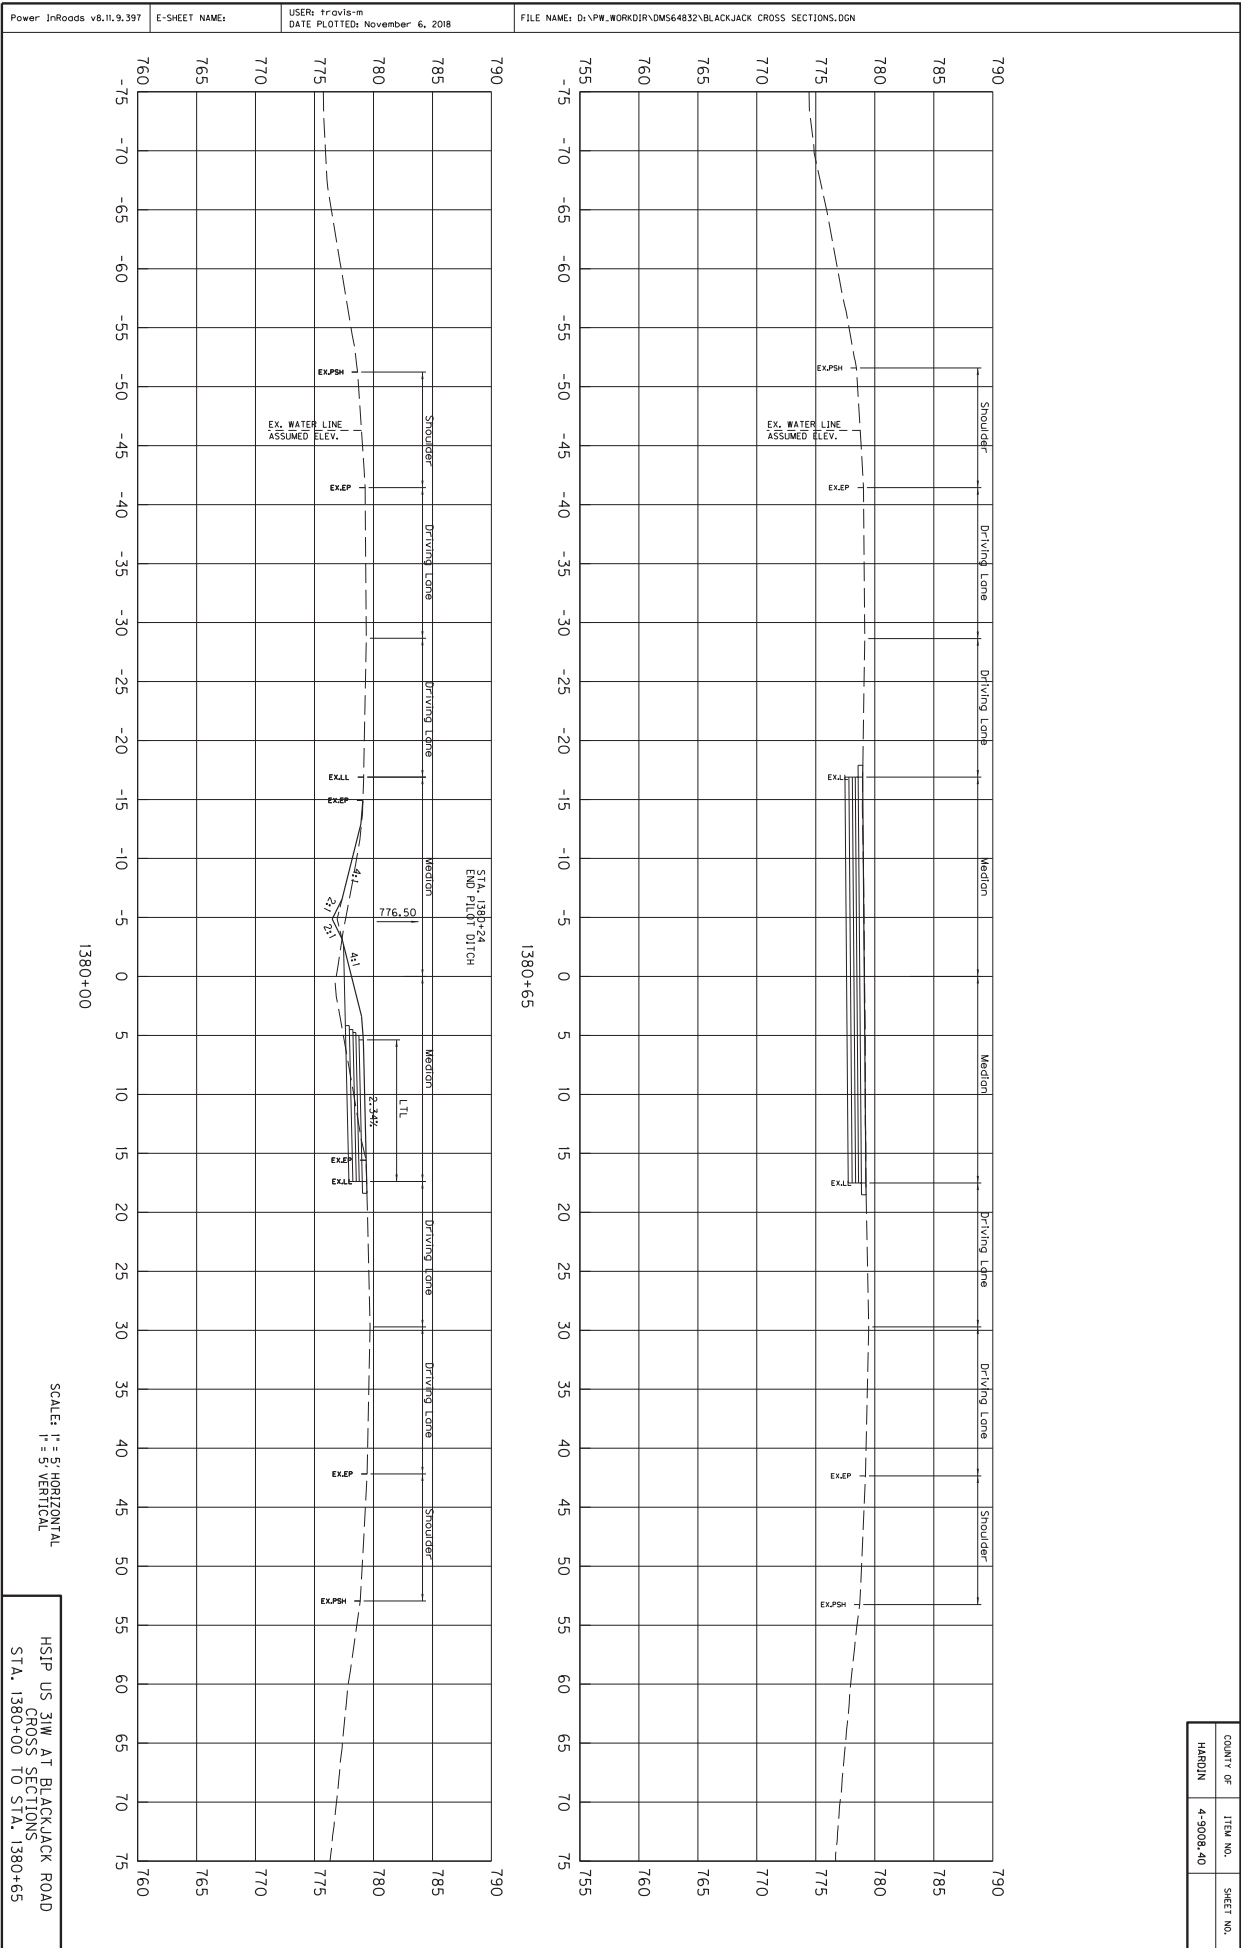


SCALE: H = 5' HORIZONTAL
V = 5' VERTICAL


HSIP US 31W AT BLACKJACK ROAD
CROSS SECTIONS
STA. 1380+00 TO STA. 1380+65

COUNTY OF	ITEM NO.	SHEET NO.
HARDIN	4-9008.40	

Power InRoads v8.11.9.397 E-SHEET NAME: USER: travis-m DATE PLOTTED: November 6, 2018 FILE NAME: D:\PW_WORKDIR\DM564832\BLACKJACK CROSS SECTIONS.DGN

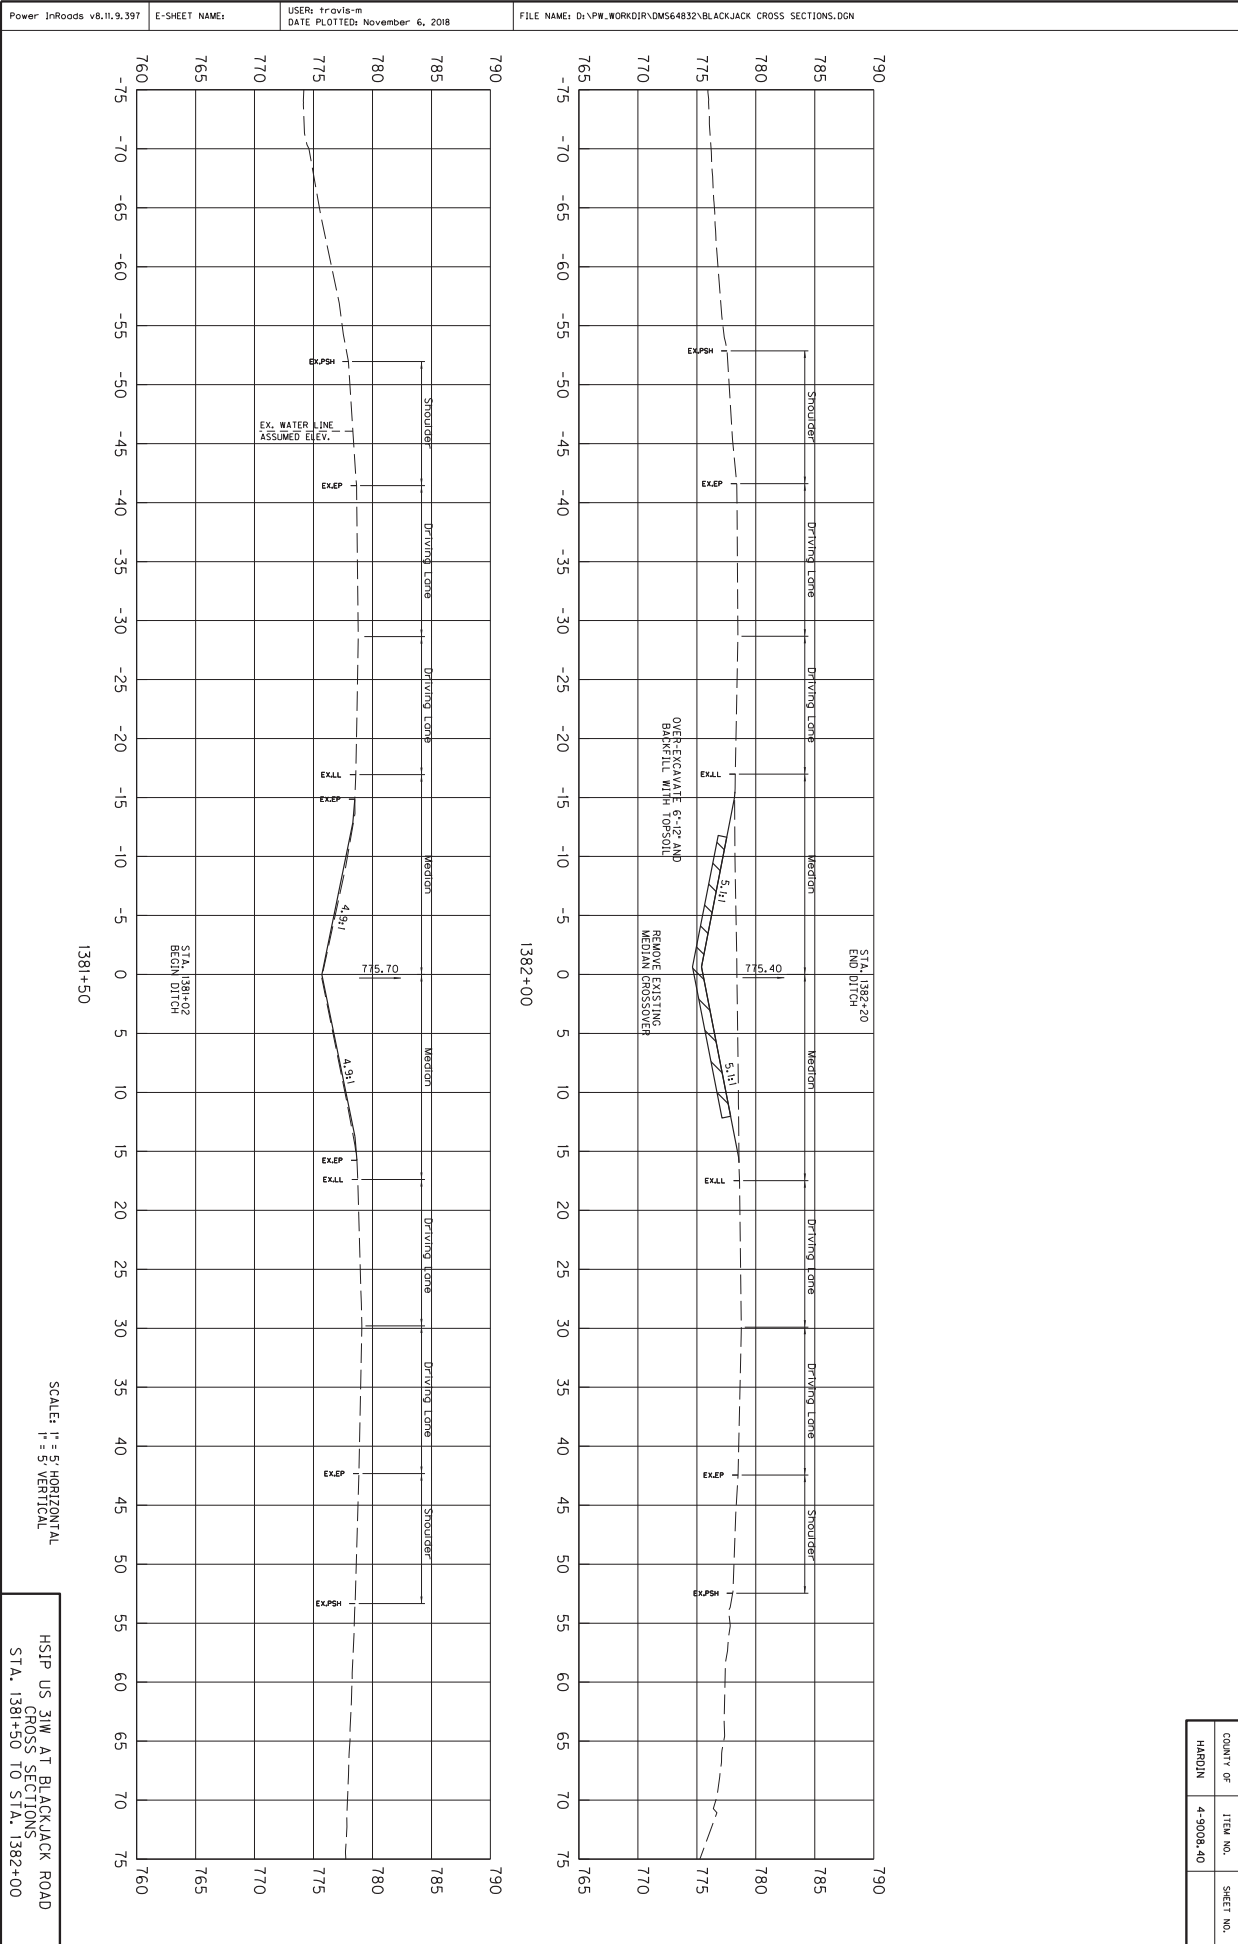


Power InRoads v8.11.9.397 E-SHEET NAME: USER: travis-m DATE PLOTTED: November 6, 2018 FILE NAME: D:\PW\WORKDIR\DM564832\BLACKJACK CROSS SECTIONS.DGN

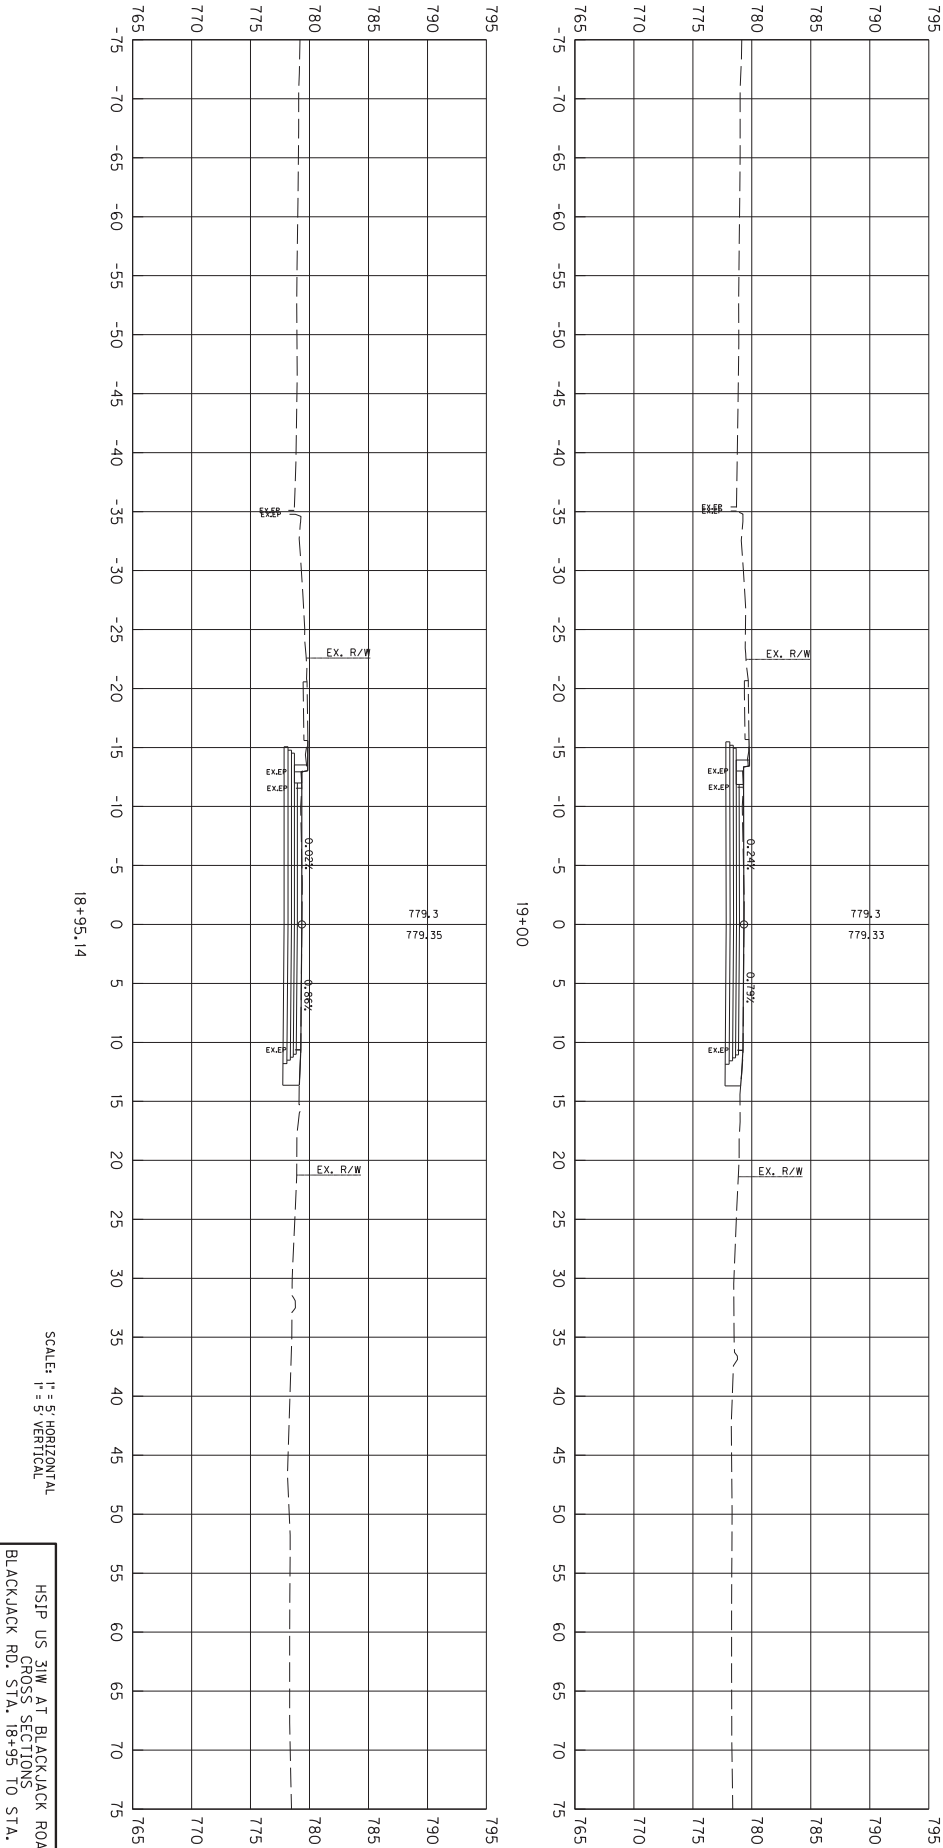

SCALE: H = 5' HORIZONTAL
V = 5' VERTICAL

HSIP US 31W AT BLACKJACK ROAD
BLACKJACK RD. STA. 18+95 TO STA. 19+00

COUNTY OF	ITEM NO.	SHEET NO.
HARDIN	4-9008.40	

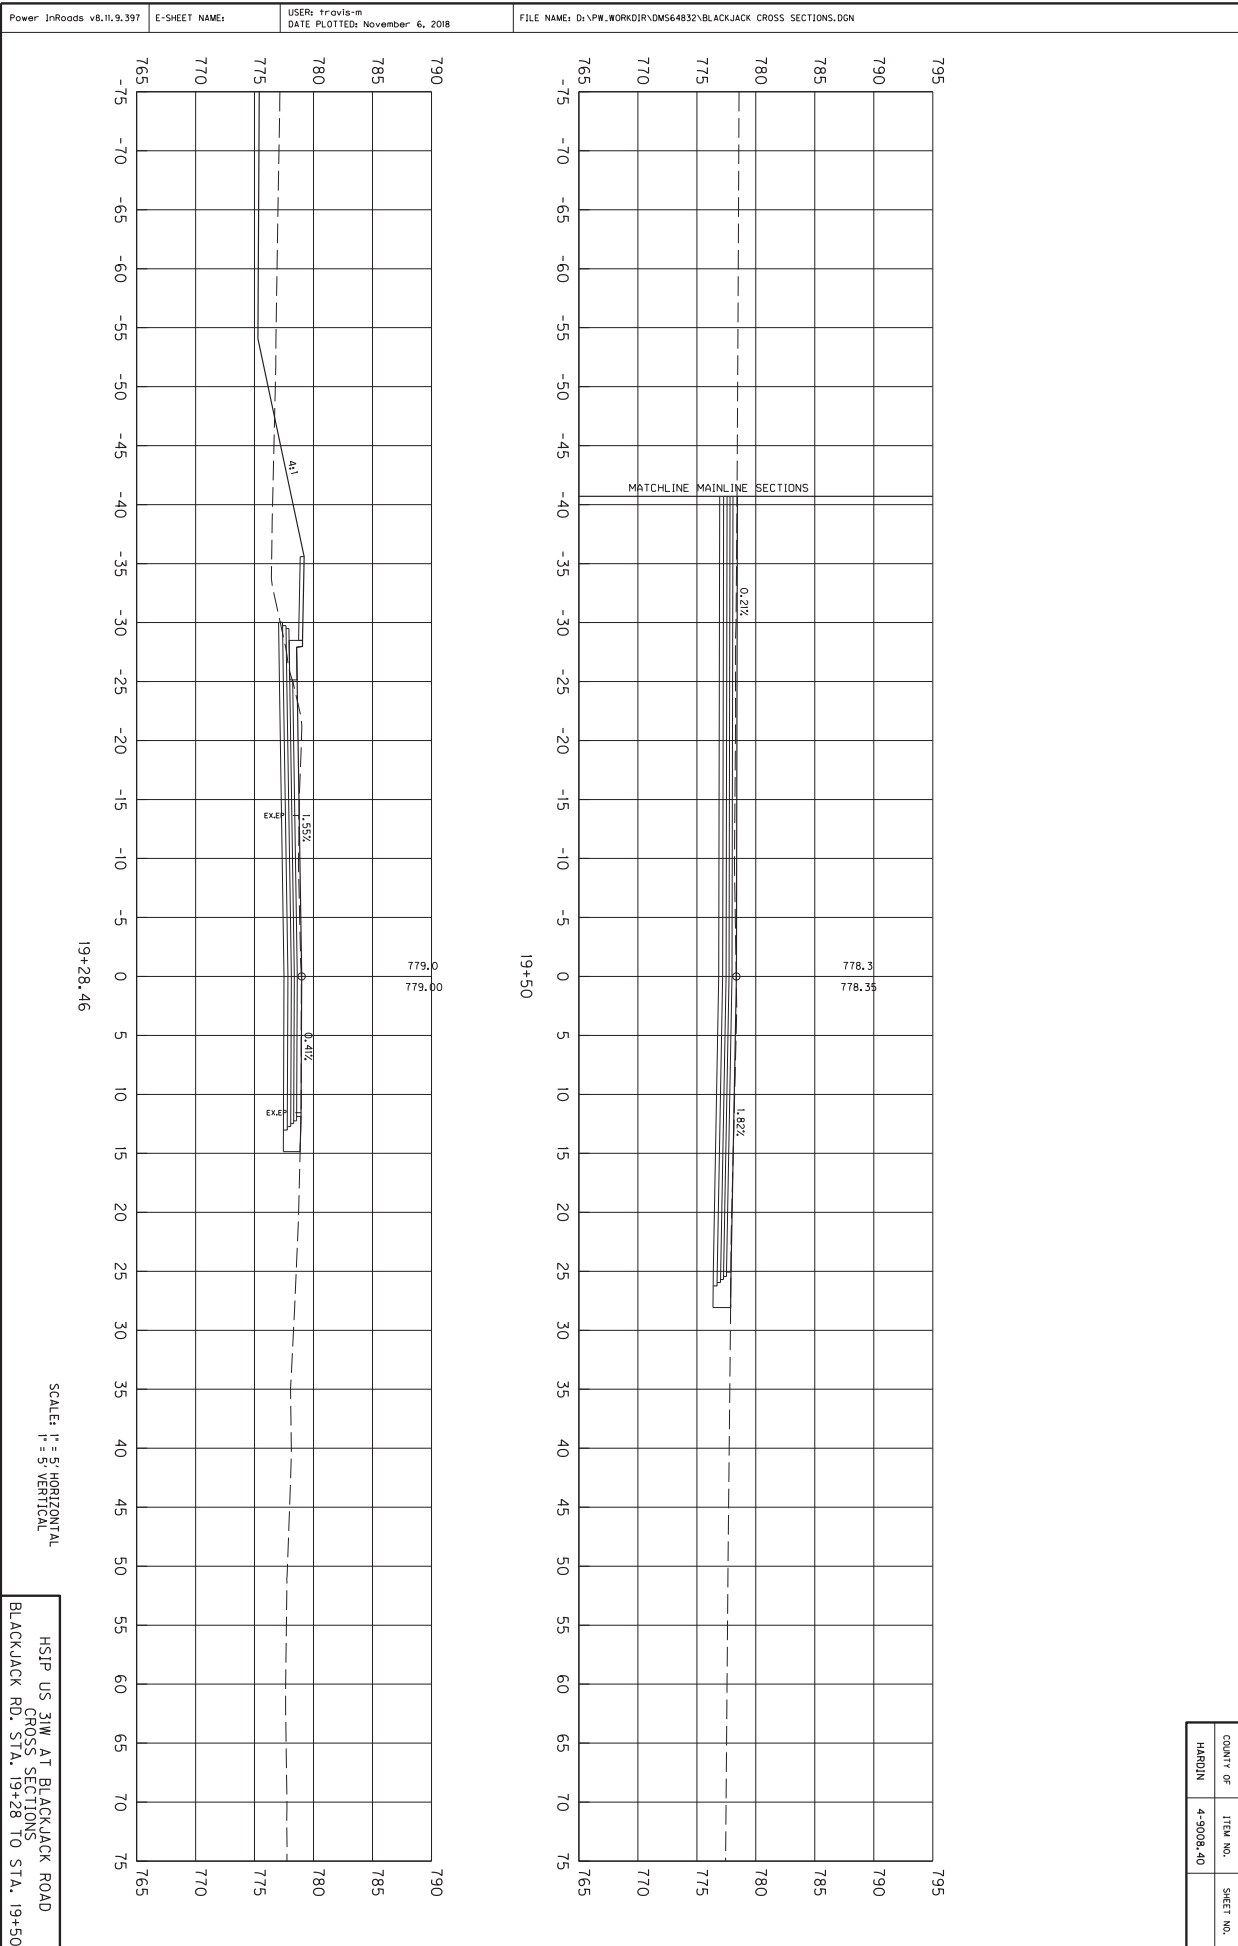

SCALE: H = 5' HORIZONTAL
V = 5' VERTICAL

HSIP US 31W AT BLACKJACK ROAD
BLACKJACK RD. STA. 19+28 TO STA. 19+50

COUNTY OF	ITEM NO.	SHEET NO.
HARDIN	4-9008.40	

GUARDRAIL DELIVERY VERIFICATION SHEET

Contract Id: _____

Contractor: _____

Section Engineer: _____

District & County: _____

<u>DESCRIPTION</u>	<u>UNIT</u>	<u>QTY LEAVING PROJECT</u>	<u>QTY RECEIVED@BB YARD</u>
GUARDRAIL (Includes End treatments & crash cushions)	LF	_____	_____
STEEL POSTS	EACH	_____	_____
STEEL BLOCKS	EACH	_____	_____
WOOD OFFSET BLOCKS	EACH	_____	_____
BACK UP PLATES	EACH	_____	_____
CRASH CUSHION	EACH	_____	_____
NUTS, BOLTS, WASHERS	BAG/BCKT	_____	_____
DAMAGED RAIL TO MAINT. FACILITY	LF	_____	_____
DAMAGED POSTS TO MAINT. FACILITY	EACH	_____	_____

***Required Signatures before Leaving Project Site**

Printed Section Engineer's Representative _____ & Date _____

Signature Section Engineer's Representative _____ & Date _____

Printed Contractor's Representative _____ & Date _____

Signature Contractor's Representative _____ & Date _____

***Required Signatures after Arrival at Bailey Bridge Yard (All material on truck must be counted & the quantity received column completed before signatures)**

Printed Bailey Bridge Yard Representative _____ & Date _____

Signature Bailey Bridge Yard Representative _____ & Date _____

Printed Contractor's Representative _____ & Date _____

Signature Contractor's Representative _____ & Date _____

**Payment for the bid item remove guardrail will be based upon the quantities shown in the Bailey Bridge Yard received column. Payment will not be made for guardrail removal until the guardrail verification sheets are electronically submitted to the Section Engineer by the Bailey Bridge Yard Representative.

Completed Form Submitted to Section Engineer Date: _____ By: _____

PART II
SPECIFICATIONS AND STANDARD DRAWINGS

SPECIFICATIONS REFERENCE

Any reference in the plans or proposal to previous editions of the *Standard Specifications for Road and Bridge Construction* and *Standard Drawings* are superseded by *Standard Specifications for Road and Bridge Construction, Edition of 2019* and *Standard Drawings, Edition of 2016*.

SUPPLEMENTAL SPECIFICATIONS

The contractor shall use the Supplemental Specifications that are effective at the time of letting.
The Supplemental Specifications can be found at the following link:

<http://transportation.ky.gov/Construction/Pages/Kentucky-Standard-Specifications.aspx>

10L

**SPECIAL NOTE FOR CHANNEL CHANGE
EROSION CONTROL BLANKET**

This Special Note will apply when indicated on the plans or in the proposal. Section references herein are to the Department’s 2019 Standard Specifications for Road and Bridge Construction.

1.0 DESCRIPTION. This specification covers erosion control blankets used for channel changes.

2.0 MATERIALS.

2.1 Erosion Control Blanket. Use a woven blanket made of 100 percent machine spun bristle coir fiber. Ensure the nominal thickness is at least 0.30 inches. Ensure the blanket’s nominal weight is at least 11.8 ounces per square yard. Ensure the nominal open area of the blanket does not exceed 65 percent.

2.2 Staples. Use steel wire U-shaped staples with a minimum diameter of 0.148 inches (9 gauge), a minimum width of one inch, and a minimum length of 6 inches. Use a heavier gauge when working in rocky or clay soils and longer lengths in sandy soils.

3.0 CONSTRUCTION. Prepare the bed by loosening the soil to a depth of 2 to 3 inches. Apply fertilizer, limestone, and seed at the permanent seeding rate. Cover with the erosion control blanket. Roll out the blanket in the direction of the anticipated channel flow. Anchor the blanket at the top, toe, and edges of channels on a one-foot spacing as the “Anchoring Edges and Ends” figure shows. Secure the blanket by stapling as the “Stapling Pattern” figure shows. At seams, overlap the blanket as the “Seam Overlaps” figure shows. Ensure staples are fully driven and snug against the blanket. If staples are bending, use a heavier gauge staple. Rework areas that become unstable or do not establish vegetation.


4.0 MEASUREMENT. The Department will measure the quantity of Erosion Control Blanket by the square yard of surface covered. The Department will not measure preparation of the bed or seeding for payment and will consider them incidental to the Erosion Control Blanket. The Department will not measure any reworking of slopes or channels for payment as it is considered corrective work and incidental to the Erosion Control Blanket.

5.0 PAYMENT. The Department will make payment for the completed and accepted quantities under the following:

<u>Code</u>	<u>Pay Item</u>	<u>Pay Unit</u>
----	Channel Change Erosion Control Blanket	Square Yard

The Department will consider payment as full compensation for all work required under this note.

10L

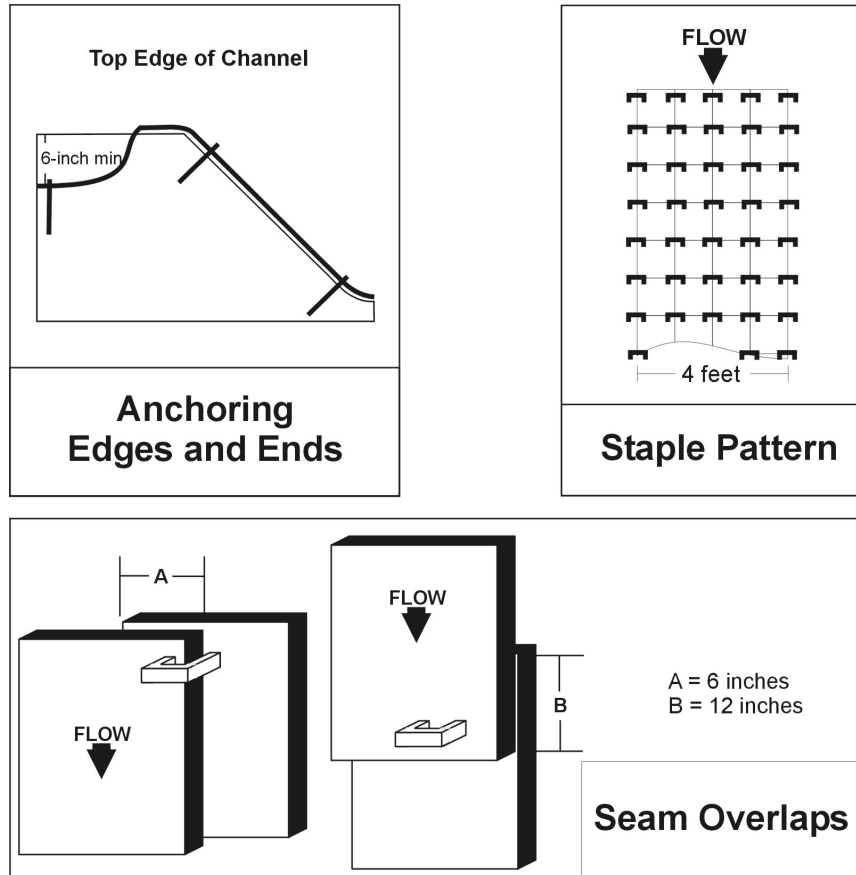

June 15, 2012

SPECIAL NOTE FOR TURF REINFORCING MAT

1.0 DESCRIPTION. Install turf reinforcement mat at locations specified in the Contract or as the Engineer directs. Section references herein are to the Department's 2019 Standard Specifications for Road and Bridge Construction.

2.0 MATERIALS.

2.1 Turf Reinforcement Mat (TRM). Use a Turf Reinforcement Mat defined as permanent rolled erosion control product composed of non-degradable synthetic fibers, filaments, nets, wire mesh and/or other elements, processed into a three-dimensional matrix of sufficient thickness and from the Department's List of Approved Materials. Mats must be 100% UV stabilized materials. For TRMs containing degradable components, all physical property values must be obtained on the non-degradable portion of the matting exclusively. Ensure product labels clearly show the manufacturer or supplier name, style name, and roll number. Ensure labeling, shipment and storage follows ASTM D-4873. The Department will require manufacturer to provide TRMs that are machine constructed web of mechanically or melt bonded nondegradable fibers entangled to form a three dimensional matrix. The Department will require all long term performance property values in table below to be based on non degradable portion of the matting alone. Approved methods include polymer welding, thermal or polymer fusion, or placement of fibers between two high strength biaxially oriented nets mechanically bound by parallel stitching with polyolefin thread. Ensure that mats designated in the plans as Type 4 mats, are not to be manufactured from discontinuous or loosely held together by stitching or glued netting or composites. Type 4 mats shall be composed of geosynthetic matrix that exhibits a very high interlock and reinforcement capacities with both soil and root systems and with high tensile modulus. The Department will require manufacturer to use materials chemically and biologically inert to the natural soil environments conditions. Ensure the blanket is smolder resistant without the use of chemical additives. When stored, maintain the protective wrapping and elevate the mats off the ground to protect them from damage. The Department will not specify these materials for use in heavily acidic coal seam areas or other areas with soil problems that would severally limit vegetation growth.

- A) Dimensions. Ensure TRMs are furnished in strips with a minimum width of 4 feet and length of 50 feet.
- B) Weight. Ensure that all mat types have a minimum mass per unit area of 7 ounces per square yard according to ASTM D 6566.
- C) Performance Testing: The Department will require AASHTO's NTPEP index testing. The Department will also require the manufacturer to perform internal MARV testing at a Geosynthetic Accreditation Institute – Laboratory Accreditation Program (GAI-LAP) accredited laboratory for tensile strength, tensile elongation, mass per unit area, and thickness once every 24,000 yds of production or whatever rate is required to ensure 97.7% confidence under ASTM D4439& 4354. The Department will require Full scale testing for slope and channel applications shear stress shall be done under ASTM D 6459, ASTM D 6460-07 procedures.

2.2 Classifications

The basis for selection of the type of mat required will be based on the long term shear stress level of the mat of the channel in question or the degree of slope to protect and will be designated in the contract. The Type 4 mats are to be used at structural backfills protecting critical

structures, utility cuts, areas where vehicles may be expected to traverse the mat, channels with large heavy drift, and where higher factors of safety, very steep slopes and/or durability concerns are needed as determined by project team and designer and will be specified in the plans by designer.

Turf Reinforcement Matting					
Properties ¹	Type 1	Type 2	Type 3	Type 4	Test Method
Minimum tensile Strength lbs/ft	125	150	175	3000 by 1500	ASTM D6818 ²
UV stability (minimum % tensile retention)	80	80	80	90	ASTM D4355 ³ (1000-hr exposure)
Minimum thickness (inches)	0.25	0.25	0.25	0.40	ASTM D6525
Slopes applications	2H:1V or flatter	1.5H:1V or flatter	1H:1V or flatter	1 H: 1V or greater	
Shear stress lbs/ft ² Channel applications	6.0 ⁴	8.0 ⁴	10.0 ⁴	12.0 ⁴	ASTM D6459 ASTM D6460-07

¹ For TRMs containing degradable components, all physical property values must be obtained on the non-degradable portion of the matting alone.

²Minimum Average Roll Values for tensile strength of sample material machine direction.

³Tensile Strength percentage retained after stated 1000 hr duration of exposure under ASTM D4355 testing. Based on nondegradable components exclusively.

⁴Maximum permissible shear design values based on short-term (0.5 hr) vegetated data obtained by full scale flume testing ASTM D6459, D6460-07. Based on nondegradable components exclusively. Testing will be done at Independent Hydraulics Facility such as Colorado State University hydraulics laboratory, Utah State University hydraulics laboratory, Texas Transportation Institute (TTI) hydraulics and erosion control laboratory.

2.3 Quality Assurance Sampling, Testing, and Acceptance

- A) Provide TRM listed on the Department’s List of Approved Materials. Prior to inclusion on the LAM, the manufacturer of TRM must meet the physical and performance criteria as outlined in the specification and submit a Letter Certifying compliance of the product under the above ASTM testing procedures and including a copy of report from Full Scale Independent Hydraulics Facility that Fully Vegetated Shear Stress meets shear stress requirements tested under D6459 and D6460-07.
- B) Contractors will provide a Letter of Certification from Manufacturer stating the product name, manufacturer, and that the product MARV product unit testing results meets Department criteria. Provide Letters once per project and for each product.
- C) Acceptance shall be in accordance with ASTM D-4759 based on testing performed by a Geosynthetic Accreditation Institute – Laboratory Accreditation Program (GAI-LAP) accredited laboratory using Procedure A of ASTM D-4354.

Current mats meeting the above criteria are shown on the Department's List of Approved Materials.

2.4 Fasteners. When the mat manufacturer does not specify a specific fastener, use steel wire U-shaped staples with a minimum diameter of 0.09 inches (11 gauge), a minimum width of one inch and a minimum length of 12 inches. Use a heavier gauge when working in rocky or clay soils and longer lengths in sandy soils as directed by Engineer or Manufacturer's Representative. Provide staples with colored tops when requested by the Engineer.

3.0 CONSTRUCTION. When requested by the Engineer, provide a Manufacturer's Representative on-site to oversee and approve the initial installation of the mat. When requested by the Engineer, provide a letter from the Manufacturer approving the installation. When there is a conflict between the Department's criteria and the Manufacturer's criteria, construct using the more restrictive. The Engineer and Manufacturer's Representative must approve all alternate installation methods prior to execution. Construct according to the Manufacturer's recommendations and the following as minimum installation technique:

3.1 Site Preparation. Grade areas to be treated with matting and compact. Remove large rocks, soil clods, vegetation, roots, and other sharp objects that could keep the mat from intimate contact with subgrade. Prepare seedbed by loosening the top 2 to 3 inch of soil.

3.2 Installation. Install mats according to Standard Drawing Sepias "Turf Mat Channel Installation" and "Turf Mat Slope Installation." Install mats at the specified elevation and alignment. Anchor the mats with staples with a minimum length of 12 inches. Use longer anchors for installations in sandy, loose, or wet soils as directed by the Engineer or Manufacturer's Representative. The mat should be in direct contact with the soil surface.

4.0 MEASUREMENT. The Department will measure the quantity of Turf Reinforcement Mat by the square yard of surface covered. The Department will not measure preparation of the bed, providing a Manufacturer's Representative, topsoil, or seeding for payment and will consider them incidental to the Turf Reinforcement Mat. The Department will not measure any reworking of slopes or channels for payment as it is considered corrective work and incidental to the Turf Reinforcement Mat. Seeding and protection will be an incidental item.

5.0 PAYMENT. The Department will make payment for the completed and accepted quantities under the following:

<u>Code</u>	<u>Pay Item</u>	<u>Pay Unit</u>
23274EN11F	Turf Reinforcement Mat 1	Square Yard
23275EN11F	Turf Reinforcement Mat 2	Square Yard
23276EN11F	Turf Reinforcement Mat 3	Square Yard
23277EN11F	Turf Reinforcement Mat 4	Square Yard

June 15, 2012

2016 STANDARD DRAWINGS THAT APPLY

ROADWAY ~ BARRIERS ~

TYPICAL BARRIER INSTALLATIONS

TYPICAL GUARDRAIL INSTALLATIONS	SEPIA-024
TYPICAL GUARDRAIL INSTALLATIONS	RBI-002-07
TYPICAL INSTALLATION FOR GUARDRAIL END TREATMENT TYPE 2A	RBI-003-09
GUARDRAIL INSTALLATION AT BRIDGE COLUMNS	RBI-005-08
GUARDRAIL INSTALLATION AT SIGN SUPPORTS	RBI-006-07
CRASH CUSHION TYPE IX INSTALLATION AT MEDIAN PIERS (DEPRESSED MEDIAN).....	RBI-007-09

GUARDRAIL HARDWARE

STEEL BEAM GUARDRAIL (W-BEAM)	SEPIA-027
GUARDRAIL COMPONENTS	RBR-005-11
GUARDRAIL TERMINAL SECTIONS	RBR-010-06
STEEL GUARDRAIL POSTS	SEPIA-028
GUARDRAIL END TREATMENT TYPE 2A	RBR-025-05
DELINEATORS FOR GUARDRAIL	SEPIA-032
GUARDRAIL HEIGHT TRANSITION DETAIL	SEPIA-033

~ DRAINAGE ~

BOX INLETS AND OUTLETS

DROP BOXES

DROP BOX INLET TYPE 5A-5B-5C-5D-5E & 5F	RDB-005-09
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SLOPED BOXES

SLOPED BOX OUTLET TYPE 1	RDB-100-05
GRATES FOR SLOPED BOX OUTLET TYPE 1	RDB-101-05

CURB BOXES

STANDARD CURB BOX INLET TYPE A	RDB-270-09
STANDARD CURB BOX INLET TYPE A	RDB-271-05
STANDARD CURB BOX INLET TYPE A	RDB-272-07
STANDARD CURB BOX INLET TYPE A	RDB-273-06
BOX INLET RISER	RDB-400-05
BOX INLET PIPE CHAMBER	RDB-410-06
BOX INLET PIPE CHAMBER (ADDITIONAL STEEL)	RDB-420-05
STANDARD CURB BOX INLET TYPE F	RDB-320-06
FRAME AND LID TYPE 1	RDM-100-03
FRAME AND LID TYPE 2	RDM-105-03

PAVED DITCHES, FLUME INLETS AND CHANNEL LININGS

SLOPED & FLARED HEADWALLS FOR 12" TO 27" PIPE	RDH-020-03
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PIPE AND BOX CULVERT HEADWALLS

STANDARD CURB BOX INLET TYPE F	RDB-320-06
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Standard Drawings That Apply
Page 2 of 3

TYPICAL DRAINAGE INSTALLATIONS

CULVERT, ENTRANCE & STORM SEWER PIPE TYPES & COVER HEIGHTS (12" – 24" PIPE)	RDI-001-10
NON-CIRCULAR PIPE ALTERNATES	RDI-016-03
PIPE BEDDING FOR CULVERTS, ENTRANCE, AND STORM SEWER PIPE	RDI-020-09
PIPE BEDDING FOR CULVERTS, ENTRANCE, AND STORM SEWER, REINFORCED CONC. PIPE	RDI-021-01
PIPE BEDDING, TRENCH CONDITION	RDI-025-05
PIPE BEDDING, TRENCH CONDITION, REINFORCED CONC. PIPE	RDI-026-01
COATINGS, LININGS AND PAVINGS FOR NON-STRUCTURAL PLATE PIPE	RDI-035-02
EROSION CONTROL BLANKET SLOPE INSTALLATION	RDI-040-01
EROSION CONTROL BLANKET CHANNEL INSTALLATION	RDI-041-01
TYPICAL MEDIAN DRAIN INSTALLATIONS	RDI-045-02

MANHOLES

FRAME AND LID TYPE 2	RDM-105-03
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PERFORATED PIPE

PERFORATED PIPE TYPES AND COVER HEIGHTS	RDP-001-06
PERFORATED PIPE FOR SUBGRADE DRAINAGE ON TWO-LANE (CLASS 2) AND MULTI-LANE ROADS	RDP-005-05
PERFORATED PIPE UNDERDRAINS (LONGITUDINAL AND TRANSVERSE)	RDP-006-04
PERFORATED PIPE DETAILS (SOLID ROCK)	RDP-007-04

MISCELLANEOUS DRAINAGE

JUNCTION BOX	RDX-001-06
JUNCTION BOX (DIMENSIONS AND QUANTITIES)	RDX-002-04
JUNCTION BOX TYPE B	RDX-005-03
SECURITY DEVICES FOR FRAMES, GRATES AND LIDS	RDX-160-06
TEMPORARY SILT FENCE	RDX-210-03
SILT TRAP - TYPE A	RDX-220-05
SILT TRAP - TYPE B	RDX-225-01
SILT TRAP - TYPE C	RDX-230-01

~ **GENERAL** ~

MISCELLANEOUS STANDARDS

MISCELLANEOUS STANDARDS PART 1	RGX-001-06
RIGHT OF WAY MONUMENTS	RGX-005-06
TYPICAL EMBANKMENT FOUNDATION BENCHES	RGX-010-04
DETECTABLE WARNINGS	RGX-040-03
ONE POINT PROCTER FAMILY OF CURVES	RGX-200-01

~ **PAVEMENT** ~

MEDIANS, CURBS, APPROACHES, ENTRANCES, ETC.

PERMANENT U-TURN MEDIAN OPENING	RPM-001-04
STANDARD BARRIER MEDIAN	RPM-010-06
CURB AND GUTTER, CURBS AND VALLEY GUTTER	RPM-100-10
APPROACHES, ENTRANCES, AND MAIL BOX TURNOUT	RPM-110-07
CONCRETE ENTRANCE PAVEMENT AND SIDEWALK	RPM-150-08
CONCRETE ENTRANCE PAVEMENT AND SIDEWALK	RPM-152-08
SIDEWALK RAMPS	RPM-170-09

Standard Drawings That Apply
Page 3 of 3

TRAFFIC
~ PERMANENT ~

RAISED PAVEMENT MARKERS

PAVEMENT MARKER ARRANGEMENTS MULTI-LANE ROADWAYS.....	TPM-100-03
PAVEMENT MARKER ARRANGEMENTS MULTI-LANE ROADWAYS.....	TPM-105-03
PAVEMENT MARKER ARRANGEMENTS MULTI-LANE ROADWAYS.....	TPM-110-03
PAVEMENT MARKER ARRANGEMENT TWO-LANE TO FOUR-LANE TRANSITIONS	TPM-120-03
PAVEMENT MARKER ARRANGEMENT CHANNELIZED INTERSECTION.....	TPM-145-03
SHOULDER & EDGELINE RUMBLE STRIP DETAILS	SEPIA-005
EDGELINE RUMBLE STRIP DETAILS TWO LANE ROADWAYS	SEPIA-006

~ TEMPORARY ~
TRAFFIC CONTROL

LANE CLOSURE TWO-LANE HIGHWAY	TTC-100-04
LANE CLOSURE USING TRAFFIC SIGNALS	TTC-110-03
LANE CLOSURE MULTI-LANE HIGHWAY CASE I.....	TTC-115-03
LANE CLOSURE MULTI-LANE HIGHWAY CASE II.....	TTC-120-03
SHOULDER CLOSURE.....	TTC-135-02
TEMPORARY PAVEMENT MARKER ARRANGEMENTS FOR CONSTRUCTION ZONES	TTC-155-02
TEMPORARY PAVEMENT MARKER ARRANGEMENTS FOR LANE CLOSURES.....	TTC-160-02


DEVICES

DOUBLE FINES ZONE SIGNS.....	TTD-120-02
PAVEMENT CONDITION WARNING SIGNS.....	TTD-125-02

STRIPING OPERATIONS

MOBILE OPERATION FOR PAINT STRIPING CASE II	TTS-105-02
MOBILE OPERATION FOR PAINT STRIPING CASE IV.....	TTS-115-02
MOBILE OPERATION FOR DURABLE STRIPING CASE I.....	TTS-120-02

COUNTY OF	TERRITORY	SHEET NO.

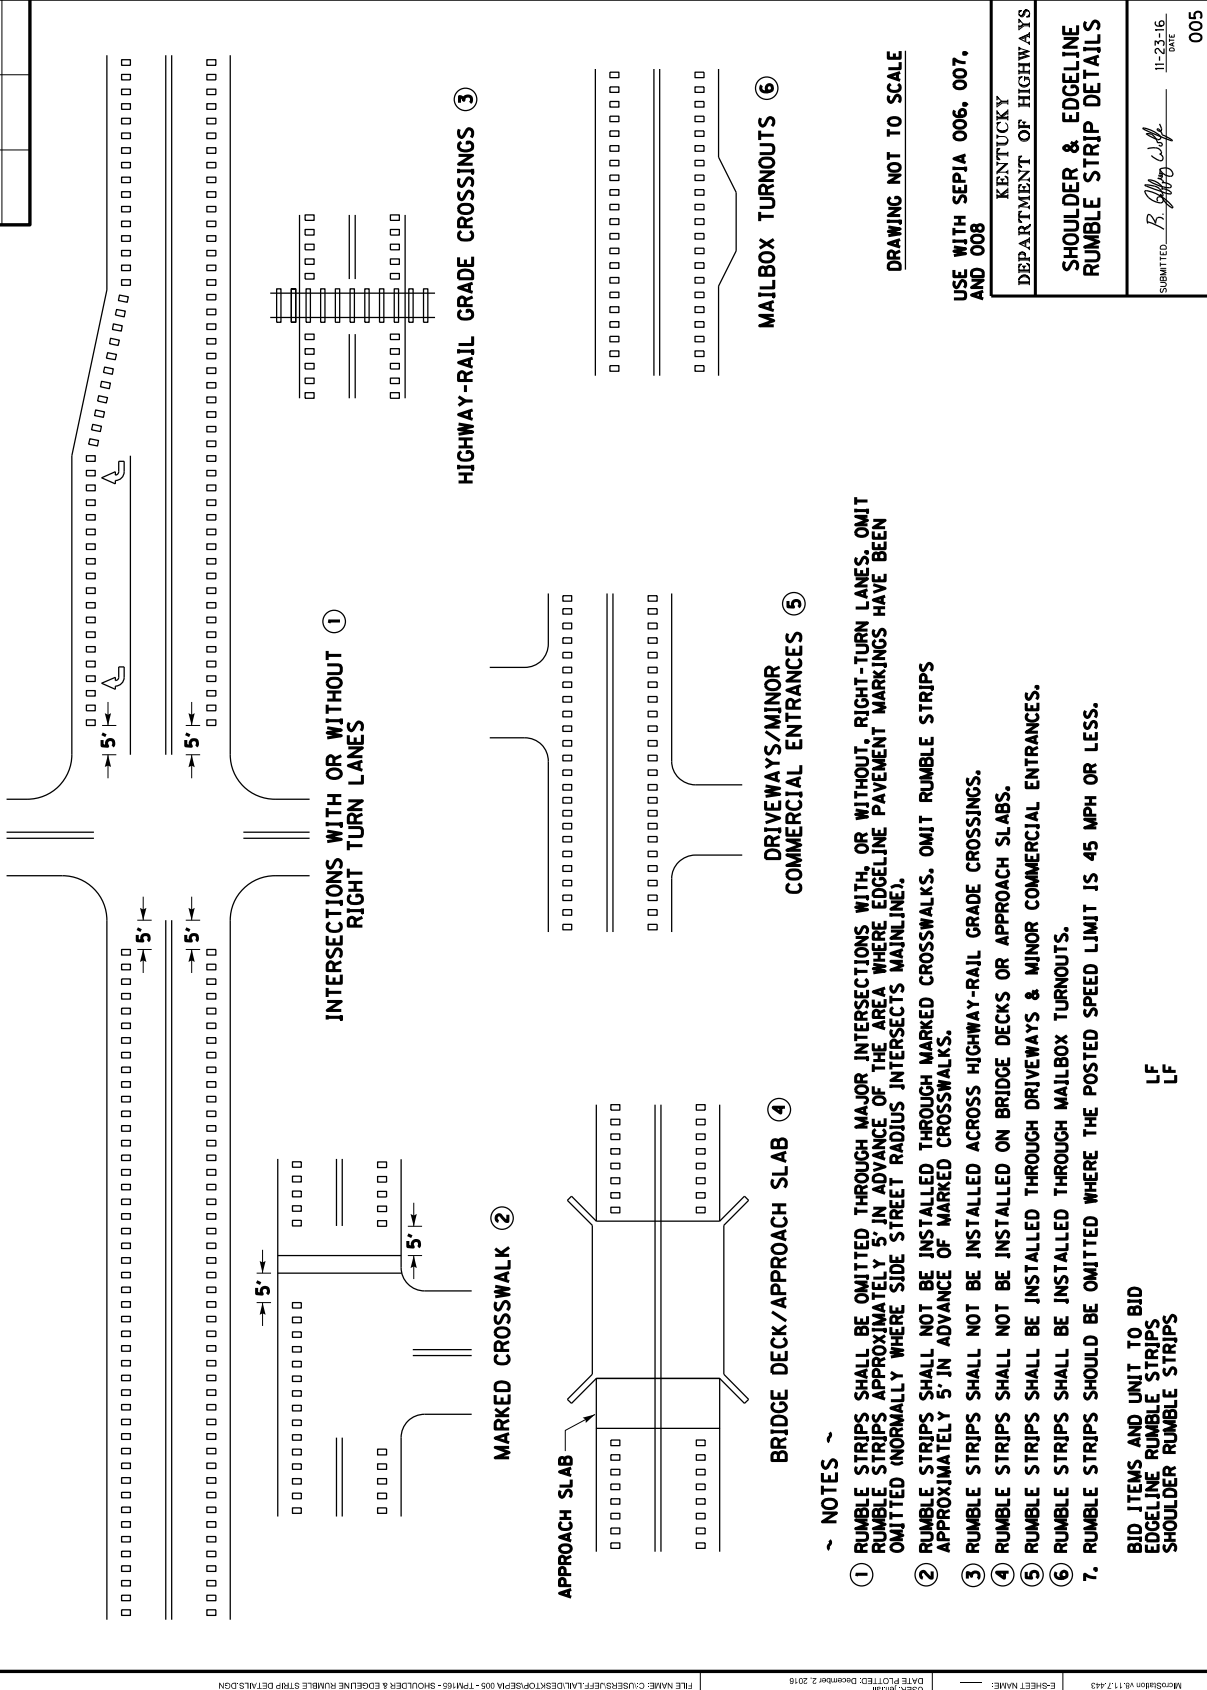

- ~ NOTES ~
- ① RUMBLE STRIPS SHALL BE OMITTED THROUGH MAJOR INTERSECTIONS WITH, OR WITHOUT, RIGHT-TURN LANES. OMIT RUMBLE STRIPS APPROXIMATELY 5' IN ADVANCE OF THE AREA WHERE EDGELINE PAVEMENT MARKINGS HAVE BEEN OMITTED (NORMALLY WHERE SIDE STREET RADIUS INTERSECTS MAINLINE).
 - ② RUMBLE STRIPS SHALL NOT BE INSTALLED THROUGH MARKED CROSSWALKS. OMIT RUMBLE STRIPS APPROXIMATELY 5' IN ADVANCE OF MARKED CROSSWALKS.
 - ③ RUMBLE STRIPS SHALL NOT BE INSTALLED ACROSS HIGHWAY-RAIL GRADE CROSSINGS.
 - ④ RUMBLE STRIPS SHALL NOT BE INSTALLED ON BRIDGE DECKS OR APPROACH SLABS.
 - ⑤ RUMBLE STRIPS SHALL BE INSTALLED THROUGH DRIVEWAYS & MINOR COMMERCIAL ENTRANCES.
 - ⑥ RUMBLE STRIPS SHALL BE INSTALLED THROUGH MAILBOX TURNOUTS.
 7. RUMBLE STRIPS SHOULD BE OMITTED WHERE THE POSTED SPEED LIMIT IS 45 MPH OR LESS.

BID ITEMS AND UNIT TO BID
EDGELINE RUMBLE STRIPS
SHOULDER RUMBLE STRIPS


LF
LF

DRAWING NOT TO SCALE
USE WITH SEPIA 006, 007,
AND 008



KENTUCKY
DEPARTMENT OF HIGHWAYS
SHOULDER & EDGELINE
RUMBLE STRIP DETAILS

SUBMITTED: *B. [Signature]*
DATE: 11-23-16
005

COUNTY OF	TITLING	SHEET NO.
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PAVEMENT CROSS-SECTION

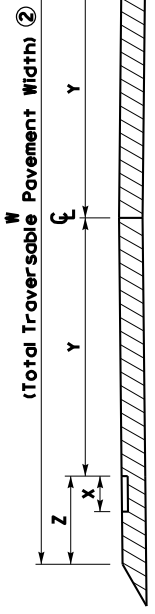

PAVEMENT WIDTH (W) ②	RUMBLE LENGTH (X) ⑥	ELRS ONLY		CLRS & ELRS	
		LANE WIDTH (Y) ③	SHOULDER WIDTH (Z) ④	LANE WIDTH (Y) ③	SHOULDER WIDTH (Z) ④
20'	8"	9'	1'	N/A	N/A
21'	8"	9.5'	1'	N/A	N/A
22'	8"	10'	1'	N/A	N/A
23'	8"	10'	1.5'	N/A	N/A
24'	8"	10.5'	1.5'	N/A	N/A
25'	8"	N/A	N/A	11'	1.5'
26'	8"	N/A	N/A	11'	2'
27'	8"	N/A	N/A	11.5'	2'
28'	8"	N/A	N/A	12'	2'
29'	8"	N/A	N/A	12'	2.5'
30'	8"	N/A	N/A	12'	3'
31'	8"	N/A	N/A	12'	3.5'
32'	8"	N/A	N/A	12'	4'
33'	8"	N/A	N/A	12'	4.5'

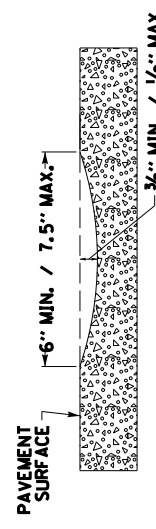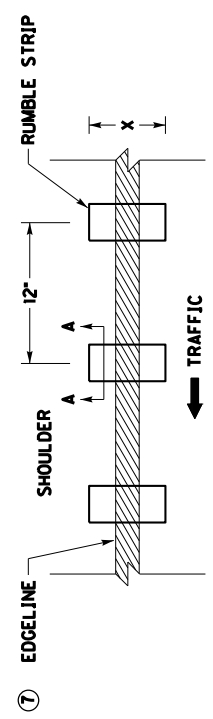~ NOTES ~

1. EDGELINE RUMBLE STRIPS SHOULD BE INSTALLED ACCORDING TO THE DIMENSIONS PROPOSED ABOVE UNLESS THERE IS AN ENGINEERING BASIS THAT SUPPORTS A CHANGE IN DIMENSION. FOR EXAMPLE, IF THE EXISTING LANE WIDTH IS NARROWER THAN THE LANE WIDTH PROPOSED IN THIS DRAWING AND THE EXISTING SHOULDER PAVEMENT DEPTH IS NOT SUITABLE TO BE CONVERTED INTO A PORTION OF THE PROPOSED LANE WIDTH, THEN THE EXISTING LANE WIDTH SHOULD BE USED INSTEAD OF THE WIDTH PROPOSED IN THIS DRAWING. NOTE: CENTERLINE RUMBLE STRIPS SHOULD BE OMITTED WHEN THE LANE WIDTH (Y) IS LESS THAN 11 FT.
2. PAVEMENT WIDTH (W) IS THE TOTAL WIDTH OF TRAVERSABLE PAVEMENT. DO NOT INCLUDE THE WIDTH OF ANY NON-TRAVERSABLE PAVEMENT, SUCH AS PAVEMENT WEDGES, WHEN MEASURING THE PAVEMENT WIDTH (W).
3. LANE WIDTH (Y) TO BE MEASURED FROM CENTER OF ROAD TO LANE SIDE EDGE OF RUMBLE STRIP.
4. PAVED SHOULDER WIDTH (Z) TO BE MEASURED FROM LANE SIDE EDGE OF RUMBLE STRIP TO OUTSIDE EDGE OF TRAVERSABLE PAVEMENT. DISTANCES SHOWN ARE APPROXIMATE. MAINTAIN RUMBLE STRIP DIMENSIONS AND SPACING AS MUCH AS POSSIBLE. IF THE TYPICAL SECTION SHOWS A LANE WIDTH (Y) AND/OR SHOULDER WIDTH (Z) THAT DIFFERS FROM THE WIDTHS LISTED IN THIS DRAWING, THE ENGINEER SHALL DETERMINE THE LANE WIDTH (Y) AND/OR SHOULDER WIDTH (Z) AT THE TIME OF CONSTRUCTION.
5. RUMBLE LENGTH (X) MAY BE MODIFIED AS THE ENGINEER DIRECTS. IF THE SHOULDER WIDTH (Z) IS EQUAL TO OR LESS THAN THE PROPOSED RUMBLE LENGTH (X).
6. PLACE THE EDGELINE MARKING IN THE CENTER OF THE RUMBLE STRIP.
7. EDGELINE RUMBLE STRIPS SHOULD BE OMITTED WHERE THE POSTED SPEED LIMIT IS 45 MPH OR LESS.

BID ITEM AND UNIT TO BID
EDGELINE RUMBLE STRIPS

LF

DRAWING NOT TO SCALE

USE WITH SEPIA 005


KENTUCKY
DEPARTMENT OF HIGHWAYS
EDGELINE RUMBLE STRIP
DETAILS
TWO LANE ROADWAYS

SUBMITTED: *B. [Signature]*
DATE: 11-23-16
006


COUNTY OF	TITLING	SHEET NO.

~ NOTES ~


1. FOR END TREATMENT TYPE 4A USE CUR. STD. DWG. RBR-035 FOR OFFSETS.
2. THE MINIMUM LENGTH OF GUARDRAIL, INCLUDING THE END TREATMENT, PRECEDING A FIXED OBJECT IS 200 FEET: (LENGTH MAY BE REDUCED SHOULD FIELD CONDITIONS WARRANT).

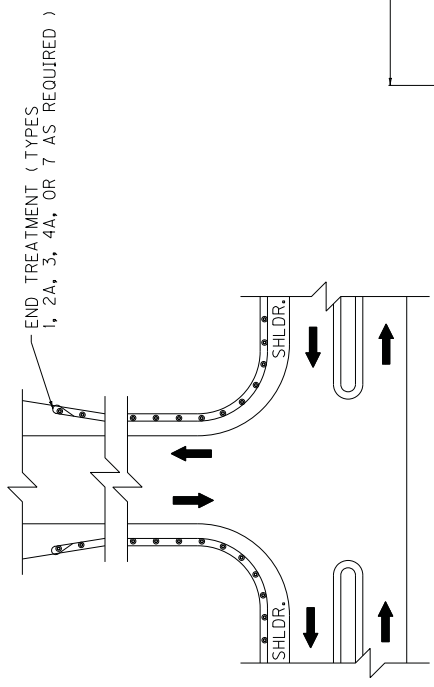


APPROACH ROADS

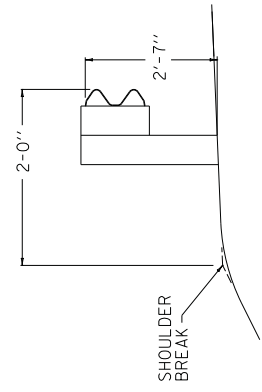


NORMAL GUARDRAIL INSTALLATION

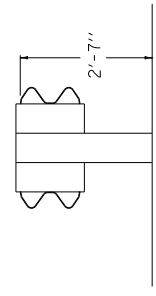

TYPICAL DOUBLE FACE GUARDRAIL INSTALLATION

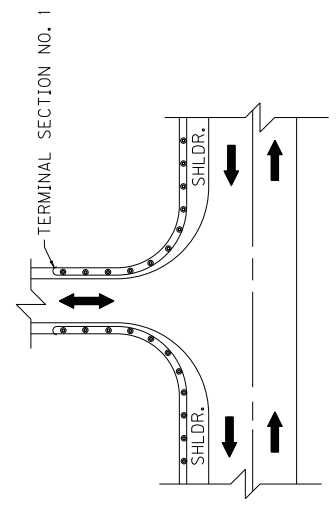

ENTRANCES

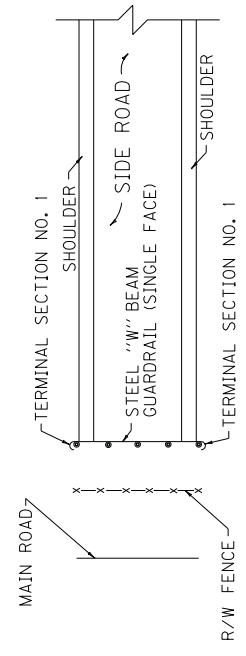


GUARDRAIL USED AS A BARRICADE

USE WITH CUR. STD. DWG.
RBI-002, RBR-035

KENTUCKY
DEPARTMENT OF HIGHWAYS
TYPICAL GUARDRAIL
INSTALLATIONS

SUBMITTED: *[Signature]*
DIRECTOR DIVISION OF DESIGN
DATE: 11-17-17
024

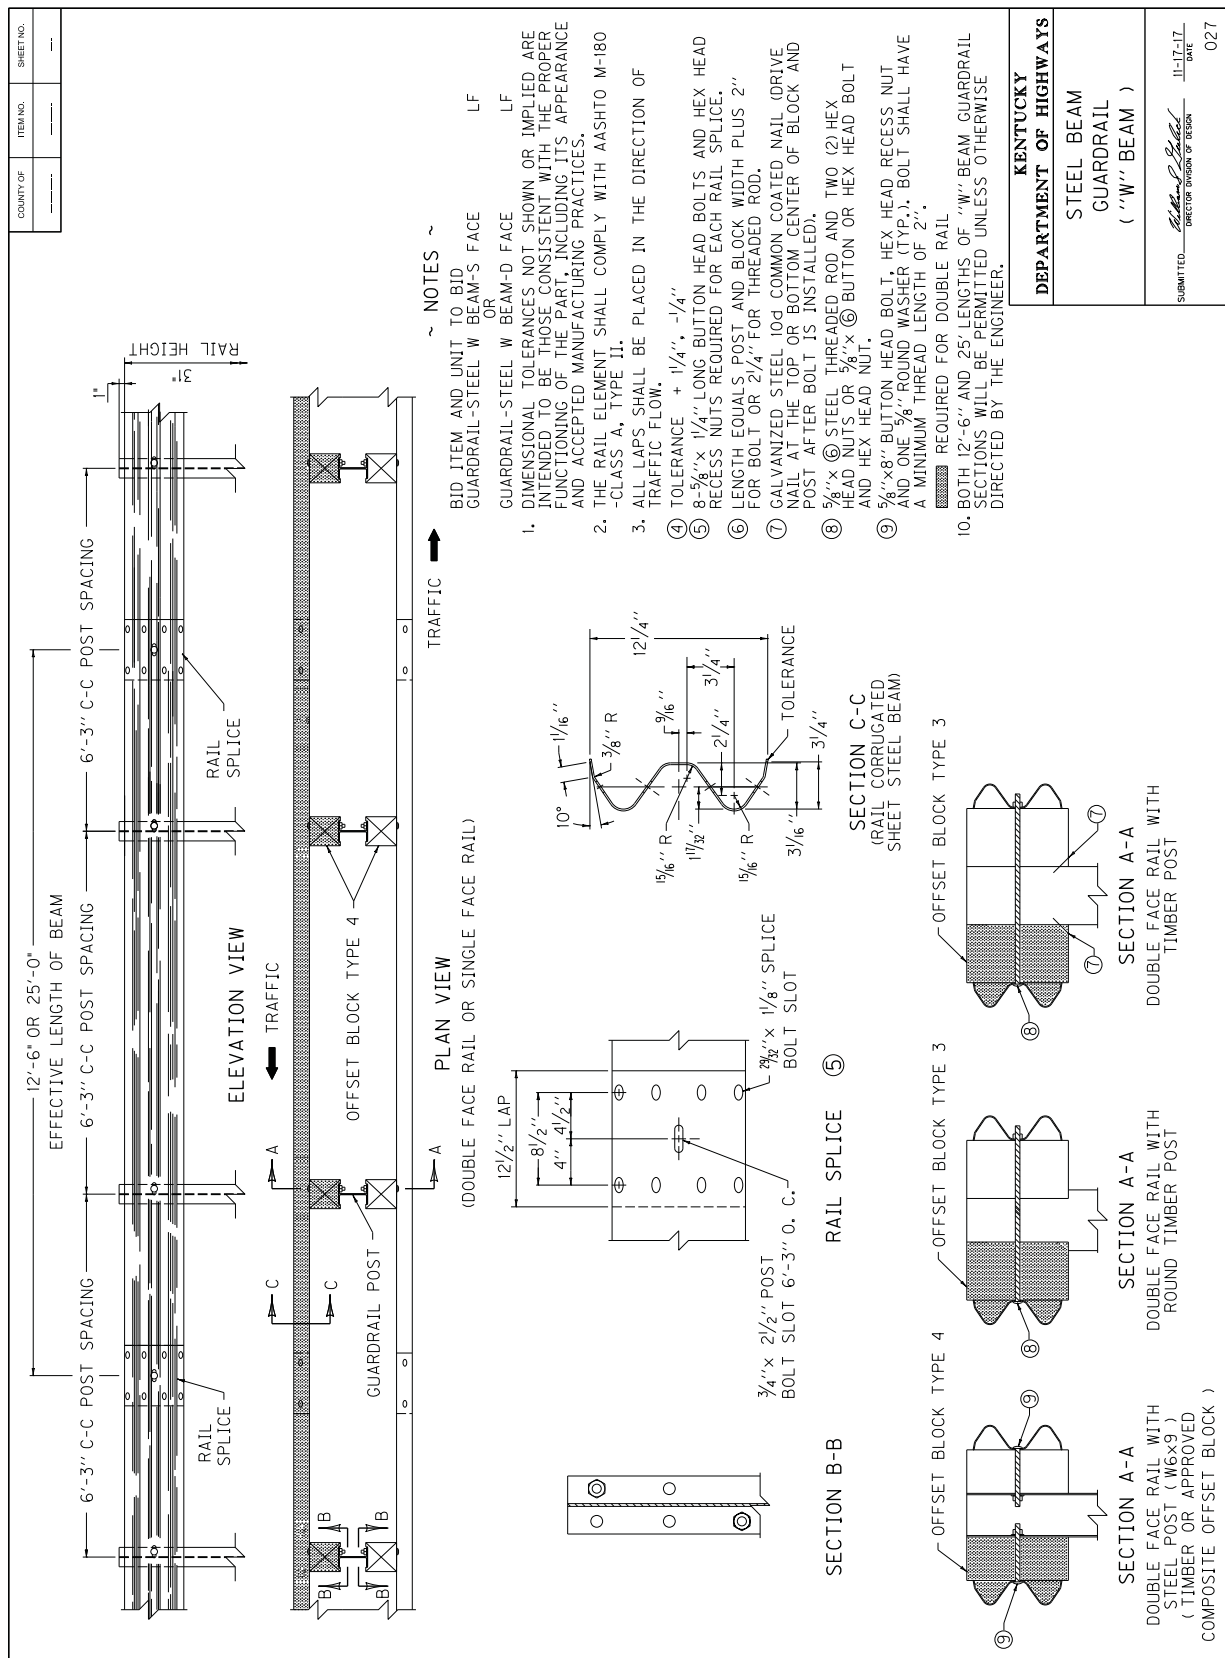

NOTES ~


- BID ITEM AND UNIT TO BID
 GUARDRAIL-STEEL W BEAM-S FACE LF
- OR
 GUARDRAIL-STEEL W BEAM-D FACE LF
- 1. DIMENSIONAL TOLERANCES NOT SHOWN OR IMPLIED ARE INTENDED TO BE THOSE CONSISTENT WITH THE PROPER FUNCTIONING OF THE PART, INCLUDING ITS APPEARANCE AND ACCEPTED MANUFACTURING PRACTICES.
- 2. THE RAIL ELEMENT SHALL COMPLY WITH AASHTO M-180 -CLASS A, TYPE II.
- 3. ALL LAPS SHALL BE PLACED IN THE DIRECTION OF TRAFFIC FLOW.
- 4. TOLERANCE + 1/4", -1/4"
- 5. 8-5/8" x 1 1/4" LONG BUTTON HEAD BOLTS AND HEX HEAD RECESS NUTS REQUIRED FOR EACH RAIL SPLICE.
- 6. LENGTH EQUALS POST AND BLOCK WIDTH PLUS 2" FOR BOLT OR 2 1/4" FOR THREADED ROD.
- 7. GALVANIZED STEEL 104 COMMON COATED NAIL (DRIVE NAIL AT THE TOP OR BOTTOM CENTER OF BLOCK AND POST AFTER BOLT IS INSTALLED).
- 8. 5/8" x 6 STEEL THREADED ROD AND TWO (2) HEX HEAD NUTS OR 5/8" x 6 BUTTON OR HEX HEAD BOLT AND HEX HEAD NUT.
- 9. 5/8" x 8" BUTTON HEAD BOLT, HEX HEAD RECESS NUT AND ONE 3/8" ROUND WASHER (TYP.). BOLT SHALL HAVE A MINIMUM THREAD LENGTH OF 2".
- 10. BOTH 12'-6" AND 25' LENGTHS OF "W" BEAM GUARDRAIL SECTIONS WILL BE PERMITTED UNLESS OTHERWISE DIRECTED BY THE ENGINEER.

COUNTY OF	ITEM NO.	SHEET NO.

KENTUCKY
DEPARTMENT OF HIGHWAYS
 STEEL BEAM
 GUARDRAIL
 ("W" BEAM)

SUBMITTED: *Robert P. Schell*
 DIRECTOR DIVISION OF DESIGN
 11-17-17
 DATE
 027

COUNTY OF	ITEM NO.	SHEET NO.

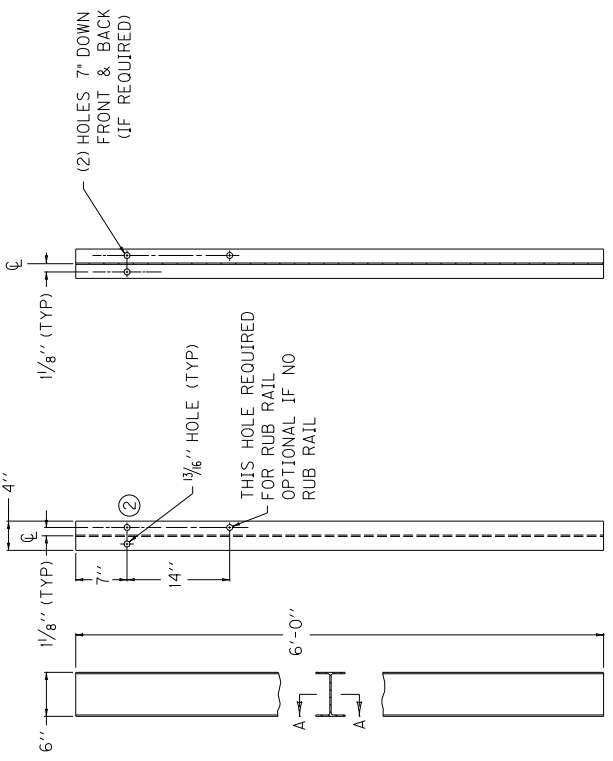


FRONT VIEW

SIDE VIEW


SECTION A-A

~ W6 X 9.0 STEEL POST ① ~

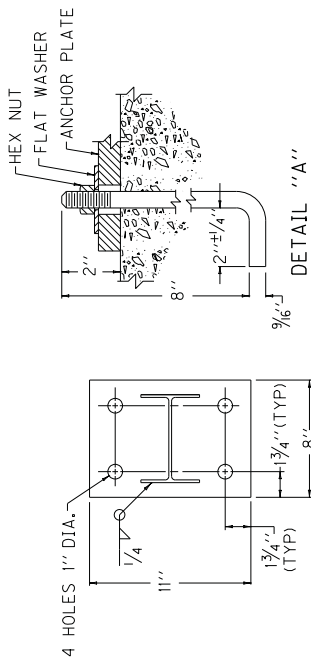


PLAN VIEW

DETAIL "A"

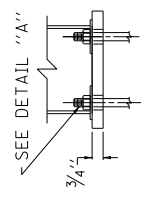

SIDE VIEW

ANCHOR PLATE

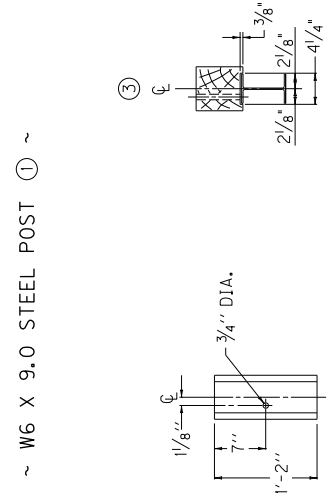

REAR ELEVATION

PLAN VIEW

OFFSET BLOCK TYPE 4
6" X 8" (Nominal Size)
(TIMBER OR APPROVED COMPOSITE)
(FOR USE WITH STEEL POST ONLY)


- ~ NOTES ~
- ① W6 X 8.5 IS AN ACCEPTABLE ALTERNATE.
 - ② THESE HOLES ARE REQUIRED FOR ATTACHING RAIL.
 - ③ TIMBER OR COMPOSITE BLOCKOUTS MAY BE USED WITH STEEL POST.

KENTUCKY DEPARTMENT OF HIGHWAYS	STEEL GUARDRAIL POSTS
	SUBMITTED: <i>Mark S. Sells</i> DIRECTOR DIVISION OF DESIGN DATE: 3-06-18 028

COUNTY OF	ITEM NO.	SHEET NO.


~ NOTES ~

- BID ITEMS AND UNIT TO BID
 DELINEATOR FOR GUARDRAIL B/W EACH
 DELINEATOR FOR GUARDRAIL M/W EACH
 DELINEATOR FOR GUARDRAIL M/Y EACH
1. DELINEATORS SHALL BE MEASURED AND PAID FOR AT THE CONTRACT UNIT PRICE EACH AND SHALL INCLUDE ALL MATERIALS AND LABOR NECESSARY FOR ONE COMPLETE INSTALLATION.
 2. DELINEATOR SHAPE AND DIMENSIONS ARE SHOWN FOR ILLUSTRATION PURPOSES ONLY. TYPES OF DELINEATORS PERMITTED SHALL BE FROM THE LIST OF APPROVED MATERIALS.
 3. GUARDRAIL DELINEATORS SHALL BE REQUIRED ON ALL GUARDRAIL.
 4. DELINEATORS SHALL NOT BE INSTALLED WITHIN THE PAY LIMITS OF THE END TREATMENT.
 5. DELINEATORS SHALL BE MANUFACTURED FROM 12 GA. GALVANIZED STEEL.
 6. DIMENSIONS SHOWN ARE APPROXIMATE AND ARE SUBJECT TO MANUFACTURER'S TOLERANCES.
 7. WHEN CONCRETE BARRIERS EXTEND ACROSS BRIDGE STRUCTURES IN LIEU OF STEEL BEAM GUARDRAIL, DELINEATORS SHALL BE INSTALLED AT SAME VERTICAL ALIGNMENT AS ON THE GUARDRAIL, AND DELINEATORS SHALL COMPLY WITH CURRENT STANDARD DRAWING RBM-020.
 8. DELINEATORS SHALL BE INSTALLED IN ACCORDANCE WITH MANUFACTURER'S RECOMMENDATIONS.

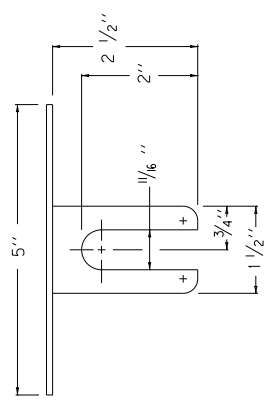


PLAN VIEW

TYPE IX SHEETING,
YELLOW OR WHITE

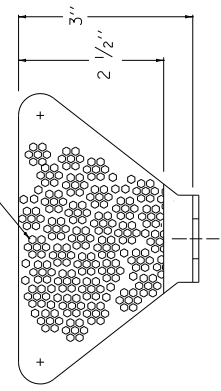


FRONT VIEW

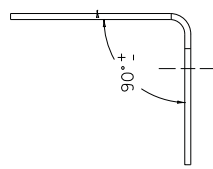


SIDE VIEW

DIMENSIONS SHOWN ARE FOR ONE VERSION OF A WEB-MOUNTED GUARDRAIL DELINEATOR. DELINEATORS WITH ALTERNATE DIMENSIONS MAY BE CONSIDERED FOR INCLUSION ON THE APPROVED PRODUCTS LIST.

BI-DIRECTIONAL WHITE DELINEATOR FOR GUARDRAIL FACING TRAFFIC

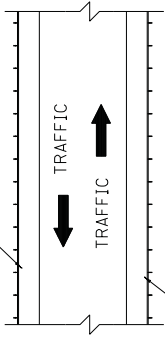

BI-DIRECTIONAL WHITE DELINEATOR FOR GUARDRAIL FACING TRAFFIC

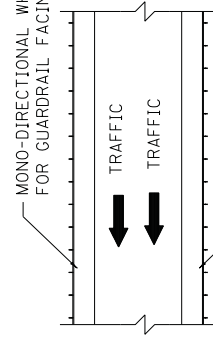

MONO-DIRECTIONAL WHITE DELINEATOR FOR GUARDRAIL FACING TRAFFIC


MONO-DIRECTIONAL YELLOW DELINEATOR FOR GUARDRAIL FACING TRAFFIC



PLACEMENT OF DELINEATORS FOR GUARDRAIL

APPROXIMATE DELINEATOR SPACING	
TANGENT	100'
CURVE	50'


SPACING SHOULD BE ADJUSTED IN CURVES SO THAT SEVERAL DELINEATORS ARE ALWAYS SIMULTANEOUSLY VISIBLE TO THE ROAD USER.

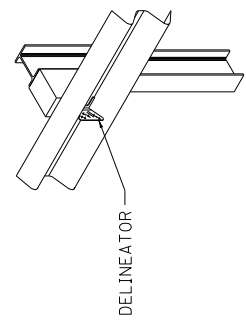


ISOMETRIC VIEW
USE WITH CUR. STD. DWGS.
RBM-020, RBR-060

KENTUCKY	
DEPARTMENT OF HIGHWAYS	
DELINEATORS FOR GUARDRAIL	
SUBMITTED: <i>Mark P. Pickett</i> DIRECTOR DIVISION OF DESIGN	JL-17-17 DATE
	032

COUNTY OF	ITEM NO.	SHEET NO.

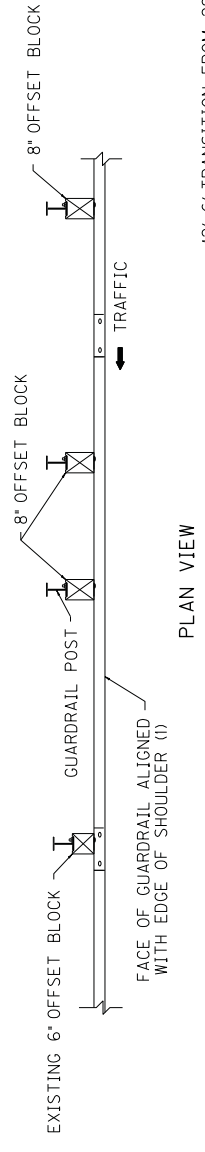

• 12'-6" TRANSITION FROM 29" TO 31" SHOWN,
25'-0" REQUIRED FOR 27" TO 31" TRANSITION.

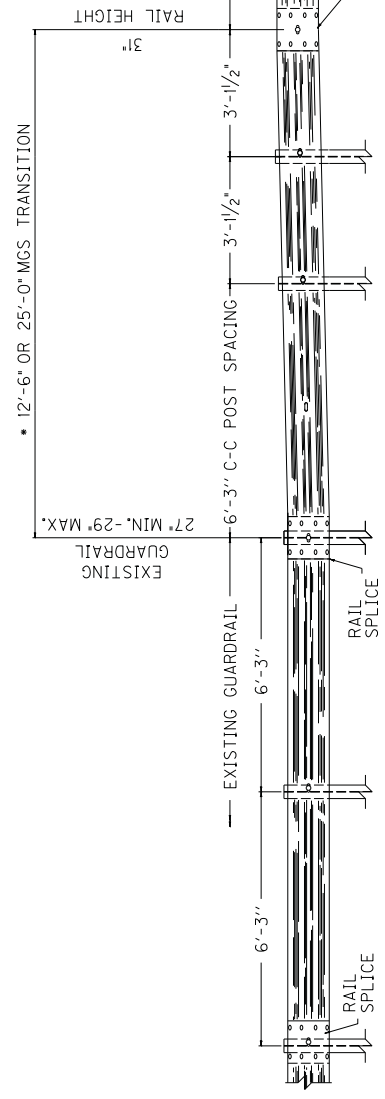

ELEVATION VIEW

~ NOTES ~

- 1) WHERE POST OFFSET IS CONSTRAINED, AND WHEN THE EXISTING SHOULDER IS WIDER THAN 4 FEET, THE EXISTING SHOULDER MAY BE REDUCED UP TO 2 INCHES TO ACCOMMODATE THE 8 INCH BLOCKS OF THE MGS GUARDRAIL. WHERE SITE CONSTRAINTS PROHIBIT THE POST FROM BEING PLACED AT LEAST 6 INCHES IN FRONT OF THE SLOPE BREAK POINT, USE 7 FOOT POSTS.
- 2) MGS TRANSITION FROM EXISTING GUARDRAIL SHALL BE COMPLETED OUTSIDE THE 50 FEET MGS END TERMINAL LIMITS.

KENTUCKY DEPARTMENT OF HIGHWAYS	SUBMITTED: <i>Robert P. Salcedo</i> DIRECTOR DESIGN & DESIGN	4-04-18 DATE
	GUARDRAIL SYSTEM TRANSITION	
		033

PART III

EMPLOYMENT, WAGE AND RECORD REQUIREMENTS

FHWA-1273 -- Revised May 1, 2012

**REQUIRED CONTRACT PROVISIONS
FEDERAL-AID CONSTRUCTION CONTRACTS**

- I. General
- II. Nondiscrimination
- III. Nonsegregated Facilities
- IV. Davis-Bacon and Related Act Provisions
- V. Contract Work Hours and Safety Standards Act Provisions
- VI. Subletting or Assigning the Contract
- VII. Safety: Accident Prevention
- VIII. False Statements Concerning Highway Projects
- IX. Implementation of Clean Air Act and Federal Water Pollution Control Act
- X. Compliance with Governmentwide Suspension and Debarment Requirements
- XI. Certification Regarding Use of Contract Funds for Lobbying

3. A breach of any of the stipulations contained in these Required Contract Provisions may be sufficient grounds for withholding of progress payments, withholding of final payment, termination of the contract, suspension / debarment or any other action determined to be appropriate by the contracting agency and FHWA.

4. Selection of Labor: During the performance of this contract, the contractor shall not use convict labor for any purpose within the limits of a construction project on a Federal-aid highway unless it is labor performed by convicts who are on parole, supervised release, or probation. The term Federal-aid highway does not include roadways functionally classified as local roads or rural minor collectors.

ATTACHMENTS

A. Employment and Materials Preference for Appalachian Development Highway System or Appalachian Local Access Road Contracts (included in Appalachian contracts only)

II. NONDISCRIMINATION

The provisions of this section related to 23 CFR Part 230 are applicable to all Federal-aid construction contracts and to all related construction subcontracts of \$10,000 or more. The provisions of 23 CFR Part 230 are not applicable to material supply, engineering, or architectural service contracts.

I. GENERAL

1. Form FHWA-1273 must be physically incorporated in each construction contract funded under Title 23 (excluding emergency contracts solely intended for debris removal). The contractor (or subcontractor) must insert this form in each subcontract and further require its inclusion in all lower tier subcontracts (excluding purchase orders, rental agreements and other agreements for supplies or services).

In addition, the contractor and all subcontractors must comply with the following policies: Executive Order 11246, 41 CFR 60, 29 CFR 1625-1627, Title 23 USC Section 140, the Rehabilitation Act of 1973, as amended (29 USC 794), Title VI of the Civil Rights Act of 1964, as amended, and related regulations including 49 CFR Parts 21, 26 and 27; and 23 CFR Parts 200, 230, and 633.

The applicable requirements of Form FHWA-1273 are incorporated by reference for work done under any purchase order, rental agreement or agreement for other services. The prime contractor shall be responsible for compliance by any subcontractor, lower-tier subcontractor or service provider.

The contractor and all subcontractors must comply with: the requirements of the Equal Opportunity Clause in 41 CFR 60-1.4(b) and, for all construction contracts exceeding \$10,000, the Standard Federal Equal Employment Opportunity Construction Contract Specifications in 41 CFR 60-4.3.

Form FHWA-1273 must be included in all Federal-aid design-build contracts, in all subcontracts and in lower tier subcontracts (excluding subcontracts for design services, purchase orders, rental agreements and other agreements for supplies or services). The design-builder shall be responsible for compliance by any subcontractor, lower-tier subcontractor or service provider.

Note: The U.S. Department of Labor has exclusive authority to determine compliance with Executive Order 11246 and the policies of the Secretary of Labor including 41 CFR 60, and 29 CFR 1625-1627. The contracting agency and the FHWA have the authority and the responsibility to ensure compliance with Title 23 USC Section 140, the Rehabilitation Act of 1973, as amended (29 USC 794), and Title VI of the Civil Rights Act of 1964, as amended, and related regulations including 49 CFR Parts 21, 26 and 27; and 23 CFR Parts 200, 230, and 633.

Contracting agencies may reference Form FHWA-1273 in bid proposal or request for proposal documents, however, the Form FHWA-1273 must be physically incorporated (not referenced) in all contracts, subcontracts and lower-tier subcontracts (excluding purchase orders, rental agreements and other agreements for supplies or services related to a construction contract).

The following provision is adopted from 23 CFR 230, Appendix A, with appropriate revisions to conform to the U.S. Department of Labor (US DOL) and FHWA requirements.

2. Subject to the applicability criteria noted in the following sections, these contract provisions shall apply to all work performed on the contract by the contractor's own organization and with the assistance of workers under the contractor's immediate superintendence and to all work performed on the contract by piecework, station work, or by subcontract.

1. Equal Employment Opportunity: Equal employment opportunity (EEO) requirements not to discriminate and to take affirmative action to assure equal opportunity as set forth under laws, executive orders, rules, regulations (28 CFR 35, 29 CFR 1630, 29 CFR 1625-1627, 41 CFR 60 and 49 CFR 27) and orders of the Secretary of Labor as modified by the provisions prescribed herein, and imposed pursuant to 23 U.S.C. 140 shall constitute the EEO and specific affirmative action standards for the contractor's project activities under

this contract. The provisions of the Americans with Disabilities Act of 1990 (42 U.S.C. 12101 et seq.) set forth under 28 CFR 35 and 29 CFR 1630 are incorporated by reference in this contract. In the execution of this contract, the contractor agrees to comply with the following minimum specific requirement activities of EEO:

a. The contractor will work with the contracting agency and the Federal Government to ensure that it has made every good faith effort to provide equal opportunity with respect to all of its terms and conditions of employment and in their review of activities under the contract.

b. The contractor will accept as its operating policy the following statement:

"It is the policy of this Company to assure that applicants are employed, and that employees are treated during employment, without regard to their race, religion, sex, color, national origin, age or disability. Such action shall include: employment, upgrading, demotion, or transfer; recruitment or recruitment advertising; layoff or termination; rates of pay or other forms of compensation; and selection for training, including apprenticeship, pre-apprenticeship, and/or on-the-job training."

2. EEO Officer: The contractor will designate and make known to the contracting officers an EEO Officer who will have the responsibility for and must be capable of effectively administering and promoting an active EEO program and who must be assigned adequate authority and responsibility to do so.

3. Dissemination of Policy: All members of the contractor's staff who are authorized to hire, supervise, promote, and discharge employees, or who recommend such action, or who are substantially involved in such action, will be made fully cognizant of, and will implement, the contractor's EEO policy and contractual responsibilities to provide EEO in each grade and classification of employment. To ensure that the above agreement will be met, the following actions will be taken as a minimum:

a. Periodic meetings of supervisory and personnel office employees will be conducted before the start of work and then not less often than once every six months, at which time the contractor's EEO policy and its implementation will be reviewed and explained. The meetings will be conducted by the EEO Officer.

b. All new supervisory or personnel office employees will be given a thorough indoctrination by the EEO Officer, covering all major aspects of the contractor's EEO obligations within thirty days following their reporting for duty with the contractor.

c. All personnel who are engaged in direct recruitment for the project will be instructed by the EEO Officer in the contractor's procedures for locating and hiring minorities and women.

d. Notices and posters setting forth the contractor's EEO policy will be placed in areas readily accessible to employees, applicants for employment and potential employees.

e. The contractor's EEO policy and the procedures to implement such policy will be brought to the attention of employees by means of meetings, employee handbooks, or other appropriate means.

4. Recruitment: When advertising for employees, the contractor will include in all advertisements for employees the notation: "An Equal Opportunity Employer." All such advertisements will be placed in publications having a large circulation among minorities and women in the area from which the project work force would normally be derived.

a. The contractor will, unless precluded by a valid bargaining agreement, conduct systematic and direct recruitment through public and private employee referral sources likely to yield qualified minorities and women. To meet this requirement, the contractor will identify sources of potential minority group employees, and establish with such identified sources procedures whereby minority and women applicants may be referred to the contractor for employment consideration.

b. In the event the contractor has a valid bargaining agreement providing for exclusive hiring hall referrals, the contractor is expected to observe the provisions of that agreement to the extent that the system meets the contractor's compliance with EEO contract provisions. Where implementation of such an agreement has the effect of discriminating against minorities or women, or obligates the contractor to do the same, such implementation violates Federal nondiscrimination provisions.

c. The contractor will encourage its present employees to refer minorities and women as applicants for employment. Information and procedures with regard to referring such applicants will be discussed with employees.

5. Personnel Actions: Wages, working conditions, and employee benefits shall be established and administered, and personnel actions of every type, including hiring, upgrading, promotion, transfer, demotion, layoff, and termination, shall be taken without regard to race, color, religion, sex, national origin, age or disability. The following procedures shall be followed:

a. The contractor will conduct periodic inspections of project sites to insure that working conditions and employee facilities do not indicate discriminatory treatment of project site personnel.

b. The contractor will periodically evaluate the spread of wages paid within each classification to determine any evidence of discriminatory wage practices.

c. The contractor will periodically review selected personnel actions in depth to determine whether there is evidence of discrimination. Where evidence is found, the contractor will promptly take corrective action. If the review indicates that the discrimination may extend beyond the actions reviewed, such corrective action shall include all affected persons.

d. The contractor will promptly investigate all complaints of alleged discrimination made to the contractor in connection with its obligations under this contract, will attempt to resolve such complaints, and will take appropriate corrective action within a reasonable time. If the investigation indicates that the discrimination may affect persons other than the complainant, such corrective action shall include such other persons. Upon completion of each investigation, the contractor will inform every complainant of all of their avenues of appeal.

6. Training and Promotion:

a. The contractor will assist in locating, qualifying, and increasing the skills of minorities and women who are

applicants for employment or current employees. Such efforts should be aimed at developing full journey level status employees in the type of trade or job classification involved.

b. Consistent with the contractor's work force requirements and as permissible under Federal and State regulations, the contractor shall make full use of training programs, i.e., apprenticeship, and on-the-job training programs for the geographical area of contract performance. In the event a special provision for training is provided under this contract, this subparagraph will be superseded as indicated in the special provision. The contracting agency may reserve training positions for persons who receive welfare assistance in accordance with 23 U.S.C. 140(a).

c. The contractor will advise employees and applicants for employment of available training programs and entrance requirements for each.

d. The contractor will periodically review the training and promotion potential of employees who are minorities and women and will encourage eligible employees to apply for such training and promotion.

7. Unions: If the contractor relies in whole or in part upon unions as a source of employees, the contractor will use good faith efforts to obtain the cooperation of such unions to increase opportunities for minorities and women. Actions by the contractor, either directly or through a contractor's association acting as agent, will include the procedures set forth below:

a. The contractor will use good faith efforts to develop, in cooperation with the unions, joint training programs aimed toward qualifying more minorities and women for membership in the unions and increasing the skills of minorities and women so that they may qualify for higher paying employment.

b. The contractor will use good faith efforts to incorporate an EEO clause into each union agreement to the end that such union will be contractually bound to refer applicants without regard to their race, color, religion, sex, national origin, age or disability.

c. The contractor is to obtain information as to the referral practices and policies of the labor union except that to the extent such information is within the exclusive possession of the labor union and such labor union refuses to furnish such information to the contractor, the contractor shall so certify to the contracting agency and shall set forth what efforts have been made to obtain such information.

d. In the event the union is unable to provide the contractor with a reasonable flow of referrals within the time limit set forth in the collective bargaining agreement, the contractor will, through independent recruitment efforts, fill the employment vacancies without regard to race, color, religion, sex, national origin, age or disability; making full efforts to obtain qualified and/or qualifiable minorities and women. The failure of a union to provide sufficient referrals (even though it is obligated to provide exclusive referrals under the terms of a collective bargaining agreement) does not relieve the contractor from the requirements of this paragraph. In the event the union referral practice prevents the contractor from meeting the obligations pursuant to Executive Order 11246, as amended, and these special provisions, such contractor shall immediately notify the contracting agency.

8. Reasonable Accommodation for Applicants / Employees with Disabilities: The contractor must be familiar

with the requirements for and comply with the Americans with Disabilities Act and all rules and regulations established there under. Employers must provide reasonable accommodation in all employment activities unless to do so would cause an undue hardship.

9. Selection of Subcontractors, Procurement of Materials and Leasing of Equipment: The contractor shall not discriminate on the grounds of race, color, religion, sex, national origin, age or disability in the selection and retention of subcontractors, including procurement of materials and leases of equipment. The contractor shall take all necessary and reasonable steps to ensure nondiscrimination in the administration of this contract.

a. The contractor shall notify all potential subcontractors and suppliers and lessors of their EEO obligations under this contract.

b. The contractor will use good faith efforts to ensure subcontractor compliance with their EEO obligations.

10. Assurance Required by 49 CFR 26.13(b):

a. The requirements of 49 CFR Part 26 and the State DOT's U.S. DOT-approved DBE program are incorporated by reference.

b. The contractor or subcontractor shall not discriminate on the basis of race, color, national origin, or sex in the performance of this contract. The contractor shall carry out applicable requirements of 49 CFR Part 26 in the award and administration of DOT-assisted contracts. Failure by the contractor to carry out these requirements is a material breach of this contract, which may result in the termination of this contract or such other remedy as the contracting agency deems appropriate.

11. Records and Reports: The contractor shall keep such records as necessary to document compliance with the EEO requirements. Such records shall be retained for a period of three years following the date of the final payment to the contractor for all contract work and shall be available at reasonable times and places for inspection by authorized representatives of the contracting agency and the FHWA.

a. The records kept by the contractor shall document the following:

(1) The number and work hours of minority and non-minority group members and women employed in each work classification on the project;

(2) The progress and efforts being made in cooperation with unions, when applicable, to increase employment opportunities for minorities and women; and

(3) The progress and efforts being made in locating, hiring, training, qualifying, and upgrading minorities and women;

b. The contractors and subcontractors will submit an annual report to the contracting agency each July for the duration of the project, indicating the number of minority, women, and non-minority group employees currently engaged in each work classification required by the contract work. This information is to be reported on [Form FHWA-1391](#). The staffing data should represent the project work force on board in all or any part of the last payroll period preceding the end of July. If on-the-job training is being required by special provision, the contractor

will be required to collect and report training data. The employment data should reflect the work force on board during all or any part of the last payroll period preceding the end of July.

III. NONSEGREGATED FACILITIES

This provision is applicable to all Federal-aid construction contracts and to all related construction subcontracts of \$10,000 or more.

The contractor must ensure that facilities provided for employees are provided in such a manner that segregation on the basis of race, color, religion, sex, or national origin cannot result. The contractor may neither require such segregated use by written or oral policies nor tolerate such use by employee custom. The contractor's obligation extends further to ensure that its employees are not assigned to perform their services at any location, under the contractor's control, where the facilities are segregated. The term "facilities" includes waiting rooms, work areas, restaurants and other eating areas, time clocks, restrooms, washrooms, locker rooms, and other storage or dressing areas, parking lots, drinking fountains, recreation or entertainment areas, transportation, and housing provided for employees. The contractor shall provide separate or single-user restrooms and necessary dressing or sleeping areas to assure privacy between sexes.

IV. DAVIS-BACON AND RELATED ACT PROVISIONS

This section is applicable to all Federal-aid construction projects exceeding \$2,000 and to all related subcontracts and lower-tier subcontracts (regardless of subcontract size). The requirements apply to all projects located within the right-of-way of a roadway that is functionally classified as Federal-aid highway. This excludes roadways functionally classified as local roads or rural minor collectors, which are exempt. Contracting agencies may elect to apply these requirements to other projects.

The following provisions are from the U.S. Department of Labor regulations in 29 CFR 5.5 "Contract provisions and related matters" with minor revisions to conform to the FHWA-1273 format and FHWA program requirements.

1. Minimum wages

a. All laborers and mechanics employed or working upon the site of the work, will be paid unconditionally and not less often than once a week, and without subsequent deduction or rebate on any account (except such payroll deductions as are permitted by regulations issued by the Secretary of Labor under the Copeland Act (29 CFR part 3)), the full amount of wages and bona fide fringe benefits (or cash equivalents thereof) due at time of payment computed at rates not less than those contained in the wage determination of the Secretary of Labor which is attached hereto and made a part hereof, regardless of any contractual relationship which may be alleged to exist between the contractor and such laborers and mechanics.

Contributions made or costs reasonably anticipated for bona fide fringe benefits under section 1(b)(2) of the Davis-Bacon Act on behalf of laborers or mechanics are considered wages paid to such laborers or mechanics, subject to the provisions

of paragraph 1.d. of this section; also, regular contributions made or costs incurred for more than a weekly period (but not less often than quarterly) under plans, funds, or programs which cover the particular weekly period, are deemed to be constructively made or incurred during such weekly period. Such laborers and mechanics shall be paid the appropriate wage rate and fringe benefits on the wage determination for the classification of work actually performed, without regard to skill, except as provided in 29 CFR 5.5(a)(4). Laborers or mechanics performing work in more than one classification may be compensated at the rate specified for each classification for the time actually worked therein: Provided, That the employer's payroll records accurately set forth the time spent in each classification in which work is performed. The wage determination (including any additional classification and wage rates conformed under paragraph 1.b. of this section) and the Davis-Bacon poster (WH-1321) shall be posted at all times by the contractor and its subcontractors at the site of the work in a prominent and accessible place where it can be easily seen by the workers.

b.(1) The contracting officer shall require that any class of laborers or mechanics, including helpers, which is not listed in the wage determination and which is to be employed under the contract shall be classified in conformance with the wage determination. The contracting officer shall approve an additional classification and wage rate and fringe benefits therefore only when the following criteria have been met:

- (i) The work to be performed by the classification requested is not performed by a classification in the wage determination; and
- (ii) The classification is utilized in the area by the construction industry; and
- (iii) The proposed wage rate, including any bona fide fringe benefits, bears a reasonable relationship to the wage rates contained in the wage determination.

(2) If the contractor and the laborers and mechanics to be employed in the classification (if known), or their representatives, and the contracting officer agree on the classification and wage rate (including the amount designated for fringe benefits where appropriate), a report of the action taken shall be sent by the contracting officer to the Administrator of the Wage and Hour Division, Employment Standards Administration, U.S. Department of Labor, Washington, DC 20210. The Administrator, or an authorized representative, will approve, modify, or disapprove every additional classification action within 30 days of receipt and so advise the contracting officer or will notify the contracting officer within the 30-day period that additional time is necessary.

(3) In the event the contractor, the laborers or mechanics to be employed in the classification or their representatives, and the contracting officer do not agree on the proposed classification and wage rate (including the amount designated for fringe benefits, where appropriate), the contracting officer shall refer the questions, including the views of all interested parties and the recommendation of the contracting officer, to the Wage and Hour Administrator for determination. The Wage and Hour Administrator, or an authorized representative, will issue a determination within 30 days of receipt and so advise the contracting officer or

will notify the contracting officer within the 30-day period that additional time is necessary.

(4) The wage rate (including fringe benefits where appropriate) determined pursuant to paragraphs 1.b.(2) or 1.b.(3) of this section, shall be paid to all workers performing work in the classification under this contract from the first day on which work is performed in the classification.

c. Whenever the minimum wage rate prescribed in the contract for a class of laborers or mechanics includes a fringe benefit which is not expressed as an hourly rate, the contractor shall either pay the benefit as stated in the wage determination or shall pay another bona fide fringe benefit or an hourly cash equivalent thereof.

d. If the contractor does not make payments to a trustee or other third person, the contractor may consider as part of the wages of any laborer or mechanic the amount of any costs reasonably anticipated in providing bona fide fringe benefits under a plan or program. Provided, That the Secretary of Labor has found, upon the written request of the contractor, that the applicable standards of the Davis-Bacon Act have been met. The Secretary of Labor may require the contractor to set aside in a separate account assets for the meeting of obligations under the plan or program.

2. Withholding

The contracting agency shall upon its own action or upon written request of an authorized representative of the Department of Labor, withhold or cause to be withheld from the contractor under this contract, or any other Federal contract with the same prime contractor, or any other federally-assisted contract subject to Davis-Bacon prevailing wage requirements, which is held by the same prime contractor, so much of the accrued payments or advances as may be considered necessary to pay laborers and mechanics, including apprentices, trainees, and helpers, employed by the contractor or any subcontractor the full amount of wages required by the contract. In the event of failure to pay any laborer or mechanic, including any apprentice, trainee, or helper, employed or working on the site of the work, all or part of the wages required by the contract, the contracting agency may, after written notice to the contractor, take such action as may be necessary to cause the suspension of any further payment, advance, or guarantee of funds until such violations have ceased.

3. Payrolls and basic records

a. Payrolls and basic records relating thereto shall be maintained by the contractor during the course of the work and preserved for a period of three years thereafter for all laborers and mechanics working at the site of the work. Such records shall contain the name, address, and social security number of each such worker, his or her correct classification, hourly rates of wages paid (including rates of contributions or costs anticipated for bona fide fringe benefits or cash equivalents thereof of the types described in section 1(b)(2)(B) of the Davis-Bacon Act), daily and weekly number of hours worked, deductions made and actual wages paid. Whenever the Secretary of Labor has found under 29 CFR 5.5(a)(1)(iv) that the wages of any laborer or mechanic include the amount of any costs reasonably anticipated in providing benefits under a plan or program described in section 1(b)(2)(B) of the Davis-

Bacon Act, the contractor shall maintain records which show that the commitment to provide such benefits is enforceable, that the plan or program is financially responsible, and that the plan or program has been communicated in writing to the laborers or mechanics affected, and records which show the costs anticipated or the actual cost incurred in providing such benefits. Contractors employing apprentices or trainees under approved programs shall maintain written evidence of the registration of apprenticeship programs and certification of trainee programs, the registration of the apprentices and trainees, and the ratios and wage rates prescribed in the applicable programs.

b. (1) The contractor shall submit weekly for each week in which any contract work is performed a copy of all payrolls to the contracting agency. The payrolls submitted shall set out accurately and completely all of the information required to be maintained under 29 CFR 5.5(a)(3)(i), except that full social security numbers and home addresses shall not be included on weekly transmittals. Instead the payrolls shall only need to include an individually identifying number for each employee (e.g., the last four digits of the employee's social security number). The required weekly payroll information may be submitted in any form desired. Optional Form WH-347 is available for this purpose from the Wage and Hour Division Web site at <http://www.dol.gov/esa/whd/forms/wh347instr.htm> or its successor site. The prime contractor is responsible for the submission of copies of payrolls by all subcontractors. Contractors and subcontractors shall maintain the full social security number and current address of each covered worker, and shall provide them upon request to the contracting agency for transmission to the State DOT, the FHWA or the Wage and Hour Division of the Department of Labor for purposes of an investigation or audit of compliance with prevailing wage requirements. It is not a violation of this section for a prime contractor to require a subcontractor to provide addresses and social security numbers to the prime contractor for its own records, without weekly submission to the contracting agency..

(2) Each payroll submitted shall be accompanied by a "Statement of Compliance," signed by the contractor or subcontractor or his or her agent who pays or supervises the payment of the persons employed under the contract and shall certify the following:

(i) That the payroll for the payroll period contains the information required to be provided under §5.5 (a)(3)(ii) of Regulations, 29 CFR part 5, the appropriate information is being maintained under §5.5 (a)(3)(i) of Regulations, 29 CFR part 5, and that such information is correct and complete;

(ii) That each laborer or mechanic (including each helper, apprentice, and trainee) employed on the contract during the payroll period has been paid the full weekly wages earned, without rebate, either directly or indirectly, and that no deductions have been made either directly or indirectly from the full wages earned, other than permissible deductions as set forth in Regulations, 29 CFR part 3;

(iii) That each laborer or mechanic has been paid not less than the applicable wage rates and fringe benefits or cash equivalents for the classification of work performed, as specified in the applicable wage determination incorporated into the contract.

(3) The weekly submission of a properly executed certification set forth on the reverse side of Optional Form WH-347 shall satisfy the requirement for submission of the "Statement of Compliance" required by paragraph 3.b.(2) of this section.

(4) The falsification of any of the above certifications may subject the contractor or subcontractor to civil or criminal prosecution under section 1001 of title 18 and section 231 of title 31 of the United States Code.

c. The contractor or subcontractor shall make the records required under paragraph 3.a. of this section available for inspection, copying, or transcription by authorized representatives of the contracting agency, the State DOT, the FHWA, or the Department of Labor, and shall permit such representatives to interview employees during working hours on the job. If the contractor or subcontractor fails to submit the required records or to make them available, the FHWA may, after written notice to the contractor, the contracting agency or the State DOT, take such action as may be necessary to cause the suspension of any further payment, advance, or guarantee of funds. Furthermore, failure to submit the required records upon request or to make such records available may be grounds for debarment action pursuant to 29 CFR 5.12.

4. Apprentices and trainees

a. Apprentices (programs of the USDOL).

Apprentices will be permitted to work at less than the predetermined rate for the work they performed when they are employed pursuant to and individually registered in a bona fide apprenticeship program registered with the U.S. Department of Labor, Employment and Training Administration, Office of Apprenticeship Training, Employer and Labor Services, or with a State Apprenticeship Agency recognized by the Office, or if a person is employed in his or her first 90 days of probationary employment as an apprentice in such an apprenticeship program, who is not individually registered in the program, but who has been certified by the Office of Apprenticeship Training, Employer and Labor Services or a State Apprenticeship Agency (where appropriate) to be eligible for probationary employment as an apprentice.

The allowable ratio of apprentices to journeymen on the job site in any craft classification shall not be greater than the ratio permitted to the contractor as to the entire work force under the registered program. Any worker listed on a payroll at an apprentice wage rate, who is not registered or otherwise employed as stated above, shall be paid not less than the applicable wage rate on the wage determination for the classification of work actually performed. In addition, any apprentice performing work on the job site in excess of the ratio permitted under the registered program shall be paid not less than the applicable wage rate on the wage determination for the work actually performed. Where a contractor is performing construction on a project in a locality other than that in which its program is registered, the ratios and wage rates (expressed in percentages of the journeyman's hourly rate) specified in the contractor's or subcontractor's registered program shall be observed.

Every apprentice must be paid at not less than the rate specified in the registered program for the apprentice's level of progress, expressed as a percentage of the journeymen hourly

rate specified in the applicable wage determination. Apprentices shall be paid fringe benefits in accordance with the provisions of the apprenticeship program. If the apprenticeship program does not specify fringe benefits, apprentices must be paid the full amount of fringe benefits listed on the wage determination for the applicable classification. If the Administrator determines that a different practice prevails for the applicable apprentice classification, fringes shall be paid in accordance with that determination.

In the event the Office of Apprenticeship Training, Employer and Labor Services, or a State Apprenticeship Agency recognized by the Office, withdraws approval of an apprenticeship program, the contractor will no longer be permitted to utilize apprentices at less than the applicable predetermined rate for the work performed until an acceptable program is approved.

b. Trainees (programs of the USDOL).

Except as provided in 29 CFR 5.16, trainees will not be permitted to work at less than the predetermined rate for the work performed unless they are employed pursuant to and individually registered in a program which has received prior approval, evidenced by formal certification by the U.S. Department of Labor, Employment and Training Administration.

The ratio of trainees to journeymen on the job site shall not be greater than permitted under the plan approved by the Employment and Training Administration.

Every trainee must be paid at not less than the rate specified in the approved program for the trainee's level of progress, expressed as a percentage of the journeyman hourly rate specified in the applicable wage determination. Trainees shall be paid fringe benefits in accordance with the provisions of the trainee program. If the trainee program does not mention fringe benefits, trainees shall be paid the full amount of fringe benefits listed on the wage determination unless the Administrator of the Wage and Hour Division determines that there is an apprenticeship program associated with the corresponding journeyman wage rate on the wage determination which provides for less than full fringe benefits for apprentices. Any employee listed on the payroll at a trainee rate who is not registered and participating in a training plan approved by the Employment and Training Administration shall be paid not less than the applicable wage rate on the wage determination for the classification of work actually performed. In addition, any trainee performing work on the job site in excess of the ratio permitted under the registered program shall be paid not less than the applicable wage rate on the wage determination for the work actually performed.

In the event the Employment and Training Administration withdraws approval of a training program, the contractor will no longer be permitted to utilize trainees at less than the applicable predetermined rate for the work performed until an acceptable program is approved.

c. Equal employment opportunity. The utilization of apprentices, trainees and journeymen under this part shall be in conformity with the equal employment opportunity requirements of Executive Order 11246, as amended, and 29 CFR part 30.

d. Apprentices and Trainees (programs of the U.S. DOT).

Apprentices and trainees working under apprenticeship and skill training programs which have been certified by the Secretary of Transportation as promoting EEO in connection with Federal-aid highway construction programs are not subject to the requirements of paragraph 4 of this Section IV. The straight time hourly wage rates for apprentices and trainees under such programs will be established by the particular programs. The ratio of apprentices and trainees to journeymen shall not be greater than permitted by the terms of the particular program.

5. Compliance with Copeland Act requirements. The contractor shall comply with the requirements of 29 CFR part 3, which are incorporated by reference in this contract.

6. Subcontracts. The contractor or subcontractor shall insert Form FHWA-1273 in any subcontracts and also require the subcontractors to include Form FHWA-1273 in any lower tier subcontracts. The prime contractor shall be responsible for the compliance by any subcontractor or lower tier subcontractor with all the contract clauses in 29 CFR 5.5.

7. Contract termination: debarment. A breach of the contract clauses in 29 CFR 5.5 may be grounds for termination of the contract, and for debarment as a contractor and a subcontractor as provided in 29 CFR 5.12.

8. Compliance with Davis-Bacon and Related Act requirements. All rulings and interpretations of the Davis-Bacon and Related Acts contained in 29 CFR parts 1, 3, and 5 are herein incorporated by reference in this contract.

9. Disputes concerning labor standards. Disputes arising out of the labor standards provisions of this contract shall not be subject to the general disputes clause of this contract. Such disputes shall be resolved in accordance with the procedures of the Department of Labor set forth in 29 CFR parts 5, 6, and 7. Disputes within the meaning of this clause include disputes between the contractor (or any of its subcontractors) and the contracting agency, the U.S. Department of Labor, or the employees or their representatives.

10. Certification of eligibility.

a. By entering into this contract, the contractor certifies that neither it (nor he or she) nor any person or firm who has an interest in the contractor's firm is a person or firm ineligible to be awarded Government contracts by virtue of section 3(a) of the Davis-Bacon Act or 29 CFR 5.12(a)(1).

b. No part of this contract shall be subcontracted to any person or firm ineligible for award of a Government contract by virtue of section 3(a) of the Davis-Bacon Act or 29 CFR 5.12(a)(1).

c. The penalty for making false statements is prescribed in the U.S. Criminal Code, 18 U.S.C. 1001.

V. CONTRACT WORK HOURS AND SAFETY STANDARDS ACT

The following clauses apply to any Federal-aid construction contract in an amount in excess of \$100,000 and subject to the overtime provisions of the Contract Work Hours and Safety Standards Act. These clauses shall be inserted in addition to the clauses required by 29 CFR 5.5(a) or 29 CFR 4.6. As used in this paragraph, the terms laborers and mechanics include watchmen and guards.

1. Overtime requirements. No contractor or subcontractor contracting for any part of the contract work which may require or involve the employment of laborers or mechanics shall require or permit any such laborer or mechanic in any workweek in which he or she is employed on such work to work in excess of forty hours in such workweek unless such laborer or mechanic receives compensation at a rate not less than one and one-half times the basic rate of pay for all hours worked in excess of forty hours in such workweek.

2. Violation; liability for unpaid wages; liquidated damages. In the event of any violation of the clause set forth in paragraph (1.) of this section, the contractor and any subcontractor responsible therefor shall be liable for the unpaid wages. In addition, such contractor and subcontractor shall be liable to the United States (in the case of work done under contract for the District of Columbia or a territory, to such District or to such territory), for liquidated damages. Such liquidated damages shall be computed with respect to each individual laborer or mechanic, including watchmen and guards, employed in violation of the clause set forth in paragraph (1.) of this section, in the sum of \$10 for each calendar day on which such individual was required or permitted to work in excess of the standard workweek of forty hours without payment of the overtime wages required by the clause set forth in paragraph (1.) of this section.

3. Withholding for unpaid wages and liquidated damages. The FHWA or the contracting agency shall upon its own action or upon written request of an authorized representative of the Department of Labor withhold or cause to be withheld, from any moneys payable on account of work performed by the contractor or subcontractor under any such contract or any other Federal contract with the same prime contractor, or any other federally-assisted contract subject to the Contract Work Hours and Safety Standards Act, which is held by the same prime contractor, such sums as may be determined to be necessary to satisfy any liabilities of such contractor or subcontractor for unpaid wages and liquidated damages as provided in the clause set forth in paragraph (2.) of this section.

4. Subcontracts. The contractor or subcontractor shall insert in any subcontracts the clauses set forth in paragraph (1.) through (4.) of this section and also a clause requiring the subcontractors to include these clauses in any lower tier subcontracts. The prime contractor shall be responsible for compliance by any subcontractor or lower tier subcontractor with the clauses set forth in paragraphs (1.) through (4.) of this section.

VI. SUBLETTING OR ASSIGNING THE CONTRACT

This provision is applicable to all Federal-aid construction contracts on the National Highway System.

1. The contractor shall perform with its own organization contract work amounting to not less than 30 percent (or a greater percentage if specified elsewhere in the contract) of the total original contract price, excluding any specialty items designated by the contracting agency. Specialty items may be performed by subcontract and the amount of any such specialty items performed may be deducted from the total original contract price before computing the amount of work required to be performed by the contractor's own organization (23 CFR 635.116).

a. The term "perform work with its own organization" refers to workers employed or leased by the prime contractor, and equipment owned or rented by the prime contractor, with or without operators. Such term does not include employees or equipment of a subcontractor or lower tier subcontractor, agents of the prime contractor, or any other assignees. The term may include payments for the costs of hiring leased employees from an employee leasing firm meeting all relevant Federal and State regulatory requirements. Leased employees may only be included in this term if the prime contractor meets all of the following conditions:

(1) the prime contractor maintains control over the supervision of the day-to-day activities of the leased employees;

(2) the prime contractor remains responsible for the quality of the work of the leased employees;

(3) the prime contractor retains all power to accept or exclude individual employees from work on the project; and

(4) the prime contractor remains ultimately responsible for the payment of predetermined minimum wages, the submission of payrolls, statements of compliance and all other Federal regulatory requirements.

b. "Specialty Items" shall be construed to be limited to work that requires highly specialized knowledge, abilities, or equipment not ordinarily available in the type of contracting organizations qualified and expected to bid or propose on the contract as a whole and in general are to be limited to minor components of the overall contract.

2. The contract amount upon which the requirements set forth in paragraph (1) of Section VI is computed includes the cost of material and manufactured products which are to be purchased or produced by the contractor under the contract provisions.

3. The contractor shall furnish (a) a competent superintendent or supervisor who is employed by the firm, has full authority to direct performance of the work in accordance with the contract requirements, and is in charge of all construction operations (regardless of who performs the work) and (b) such other of its own organizational resources (supervision, management, and engineering services) as the contracting officer determines is necessary to assure the performance of the contract.

4. No portion of the contract shall be sublet, assigned or otherwise disposed of except with the written consent of the contracting officer, or authorized representative, and such consent when given shall not be construed to relieve the contractor of any responsibility for the fulfillment of the contract. Written consent will be given only after the contracting agency has assured that each subcontract is

evidenced in writing and that it contains all pertinent provisions and requirements of the prime contract.

5. The 30% self-performance requirement of paragraph (1) is not applicable to design-build contracts; however, contracting agencies may establish their own self-performance requirements.

VII. SAFETY: ACCIDENT PREVENTION

This provision is applicable to all Federal-aid construction contracts and to all related subcontracts.

1. In the performance of this contract the contractor shall comply with all applicable Federal, State, and local laws governing safety, health, and sanitation (23 CFR 635). The contractor shall provide all safeguards, safety devices and protective equipment and take any other needed actions as it determines, or as the contracting officer may determine, to be reasonably necessary to protect the life and health of employees on the job and the safety of the public and to protect property in connection with the performance of the work covered by the contract.

2. It is a condition of this contract, and shall be made a condition of each subcontract, which the contractor enters into pursuant to this contract, that the contractor and any subcontractor shall not permit any employee, in performance of the contract, to work in surroundings or under conditions which are unsanitary, hazardous or dangerous to his/her health or safety, as determined under construction safety and health standards (29 CFR 1926) promulgated by the Secretary of Labor, in accordance with Section 107 of the Contract Work Hours and Safety Standards Act (40 U.S.C. 3704).

3. Pursuant to 29 CFR 1926.3, it is a condition of this contract that the Secretary of Labor or authorized representative thereof, shall have right of entry to any site of contract performance to inspect or investigate the matter of compliance with the construction safety and health standards and to carry out the duties of the Secretary under Section 107 of the Contract Work Hours and Safety Standards Act (40 U.S.C.3704).

VIII. FALSE STATEMENTS CONCERNING HIGHWAY PROJECTS

This provision is applicable to all Federal-aid construction contracts and to all related subcontracts.

In order to assure high quality and durable construction in conformity with approved plans and specifications and a high degree of reliability on statements and representations made by engineers, contractors, suppliers, and workers on Federal-aid highway projects, it is essential that all persons concerned with the project perform their functions as carefully, thoroughly, and honestly as possible. Willful falsification, distortion, or misrepresentation with respect to any facts related to the project is a violation of Federal law. To prevent any misunderstanding regarding the seriousness of these and similar acts, Form FHWA-1022 shall be posted on each Federal-aid highway project (23 CFR 635) in one or more places where it is readily available to all persons concerned with the project:

18 U.S.C. 1020 reads as follows:

"Whoever, being an officer, agent, or employee of the United States, or of any State or Territory, or whoever, whether a person, association, firm, or corporation, knowingly makes any false statement, false representation, or false report as to the character, quality, quantity, or cost of the material used or to be used, or the quantity or quality of the work performed or to be performed, or the cost thereof in connection with the submission of plans, maps, specifications, contracts, or costs of construction on any highway or related project submitted for approval to the Secretary of Transportation; or

Whoever knowingly makes any false statement, false representation, false report or false claim with respect to the character, quality, quantity, or cost of any work performed or to be performed, or materials furnished or to be furnished, in connection with the construction of any highway or related project approved by the Secretary of Transportation; or

Whoever knowingly makes any false statement or false representation as to material fact in any statement, certificate, or report submitted pursuant to provisions of the Federal-aid Roads Act approved July 1, 1916, (39 Stat. 355), as amended and supplemented;

Shall be fined under this title or imprisoned not more than 5 years or both."

IX. IMPLEMENTATION OF CLEAN AIR ACT AND FEDERAL WATER POLLUTION CONTROL ACT

This provision is applicable to all Federal-aid construction contracts and to all related subcontracts.

By submission of this bid/proposal or the execution of this contract, or subcontract, as appropriate, the bidder, proposer, Federal-aid construction contractor, or subcontractor, as appropriate, will be deemed to have stipulated as follows:

1. That any person who is or will be utilized in the performance of this contract is not prohibited from receiving an award due to a violation of Section 508 of the Clean Water Act or Section 306 of the Clean Air Act.

2. That the contractor agrees to include or cause to be included the requirements of paragraph (1) of this Section X in every subcontract, and further agrees to take such action as the contracting agency may direct as a means of enforcing such requirements.

X. CERTIFICATION REGARDING DEBARMENT, SUSPENSION, INELIGIBILITY AND VOLUNTARY EXCLUSION

This provision is applicable to all Federal-aid construction contracts, design-build contracts, subcontracts, lower-tier subcontracts, purchase orders, lease agreements, consultant contracts or any other covered transaction requiring FHWA approval or that is estimated to cost \$25,000 or more – as defined in 2 CFR Parts 180 and 1200.

1. Instructions for Certification – First Tier Participants:

a. By signing and submitting this proposal, the prospective first tier participant is providing the certification set out below.

b. The inability of a person to provide the certification set out below will not necessarily result in denial of participation in this

covered transaction. The prospective first tier participant shall submit an explanation of why it cannot provide the certification set out below. The certification or explanation will be considered in connection with the department or agency's determination whether to enter into this transaction. However, failure of the prospective first tier participant to furnish a certification or an explanation shall disqualify such a person from participation in this transaction.

c. The certification in this clause is a material representation of fact upon which reliance was placed when the contracting agency determined to enter into this transaction. If it is later determined that the prospective participant knowingly rendered an erroneous certification, in addition to other remedies available to the Federal Government, the contracting agency may terminate this transaction for cause of default.

d. The prospective first tier participant shall provide immediate written notice to the contracting agency to whom this proposal is submitted if any time the prospective first tier participant learns that its certification was erroneous when submitted or has become erroneous by reason of changed circumstances.

e. The terms "covered transaction," "debarred," "suspended," "ineligible," "participant," "person," "principal," and "voluntarily excluded," as used in this clause, are defined in 2 CFR Parts 180 and 1200. "First Tier Covered Transactions" refers to any covered transaction between a grantee or subgrantee of Federal funds and a participant (such as the prime or general contract). "Lower Tier Covered Transactions" refers to any covered transaction under a First Tier Covered Transaction (such as subcontracts). "First Tier Participant" refers to the participant who has entered into a covered transaction with a grantee or subgrantee of Federal funds (such as the prime or general contractor). "Lower Tier Participant" refers any participant who has entered into a covered transaction with a First Tier Participant or other Lower Tier Participants (such as subcontractors and suppliers).

f. The prospective first tier participant agrees by submitting this proposal that, should the proposed covered transaction be entered into, it shall not knowingly enter into any lower tier covered transaction with a person who is debarred, suspended, declared ineligible, or voluntarily excluded from participation in this covered transaction, unless authorized by the department or agency entering into this transaction.

g. The prospective first tier participant further agrees by submitting this proposal that it will include the clause titled "Certification Regarding Debarment, Suspension, Ineligibility and Voluntary Exclusion-Lower Tier Covered Transactions," provided by the department or contracting agency, entering into this covered transaction, without modification, in all lower tier covered transactions and in all solicitations for lower tier covered transactions exceeding the \$25,000 threshold.

h. A participant in a covered transaction may rely upon a certification of a prospective participant in a lower tier covered transaction that is not debarred, suspended, ineligible, or voluntarily excluded from the covered transaction, unless it knows that the certification is erroneous. A participant is responsible for ensuring that its principals are not suspended, debarred, or otherwise ineligible to participate in covered transactions. To verify the eligibility of its principals, as well as the eligibility of any lower tier prospective participants, each participant may, but is not required to, check the Excluded Parties List System website (<https://www.epls.gov/>), which is compiled by the General Services Administration.

i. Nothing contained in the foregoing shall be construed to require the establishment of a system of records in order to render in good faith the certification required by this clause. The knowledge and information of the prospective participant is not required to exceed that which is normally possessed by a prudent person in the ordinary course of business dealings.

j. Except for transactions authorized under paragraph (f) of these instructions, if a participant in a covered transaction knowingly enters into a lower tier covered transaction with a person who is suspended, debarred, ineligible, or voluntarily excluded from participation in this transaction, in addition to other remedies available to the Federal Government, the department or agency may terminate this transaction for cause or default.

2. Certification Regarding Debarment, Suspension, Ineligibility and Voluntary Exclusion – First Tier Participants:

a. The prospective first tier participant certifies to the best of its knowledge and belief, that it and its principals:

(1) Are not presently debarred, suspended, proposed for debarment, declared ineligible, or voluntarily excluded from participating in covered transactions by any Federal department or agency;

(2) Have not within a three-year period preceding this proposal been convicted of or had a civil judgment rendered against them for commission of fraud or a criminal offense in connection with obtaining, attempting to obtain, or performing a public (Federal, State or local) transaction or contract under a public transaction; violation of Federal or State antitrust statutes or commission of embezzlement, theft, forgery, bribery, falsification or destruction of records, making false statements, or receiving stolen property;

(3) Are not presently indicted for or otherwise criminally or civilly charged by a governmental entity (Federal, State or local) with commission of any of the offenses enumerated in paragraph (a)(2) of this certification; and

(4) Have not within a three-year period preceding this application/proposal had one or more public transactions (Federal, State or local) terminated for cause or default.

b. Where the prospective participant is unable to certify to any of the statements in this certification, such prospective participant shall attach an explanation to this proposal.

2. Instructions for Certification - Lower Tier Participants:

(Applicable to all subcontracts, purchase orders and other lower tier transactions requiring prior FHWA approval or estimated to cost \$25,000 or more - 2 CFR Parts 180 and 1200)

a. By signing and submitting this proposal, the prospective lower tier is providing the certification set out below.

b. The certification in this clause is a material representation of fact upon which reliance was placed when this transaction was entered into. If it is later determined that the prospective lower tier participant knowingly rendered an erroneous certification, in addition to other remedies available to the Federal Government, the department, or agency with which

this transaction originated may pursue available remedies, including suspension and/or debarment.

c. The prospective lower tier participant shall provide immediate written notice to the person to which this proposal is submitted if at any time the prospective lower tier participant learns that its certification was erroneous by reason of changed circumstances.

d. The terms "covered transaction," "debarred," "suspended," "ineligible," "participant," "person," "principal," and "voluntarily excluded," as used in this clause, are defined in 2 CFR Parts 180 and 1200. You may contact the person to which this proposal is submitted for assistance in obtaining a copy of those regulations. "First Tier Covered Transactions" refers to any covered transaction between a grantee or subgrantee of Federal funds and a participant (such as the prime or general contract). "Lower Tier Covered Transactions" refers to any covered transaction under a First Tier Covered Transaction (such as subcontracts). "First Tier Participant" refers to the participant who has entered into a covered transaction with a grantee or subgrantee of Federal funds (such as the prime or general contractor). "Lower Tier Participant" refers any participant who has entered into a covered transaction with a First Tier Participant or other Lower Tier Participants (such as subcontractors and suppliers).

e. The prospective lower tier participant agrees by submitting this proposal that, should the proposed covered transaction be entered into, it shall not knowingly enter into any lower tier covered transaction with a person who is debarred, suspended, declared ineligible, or voluntarily excluded from participation in this covered transaction, unless authorized by the department or agency with which this transaction originated.

f. The prospective lower tier participant further agrees by submitting this proposal that it will include this clause titled "Certification Regarding Debarment, Suspension, Ineligibility and Voluntary Exclusion-Lower Tier Covered Transaction," without modification, in all lower tier covered transactions and in all solicitations for lower tier covered transactions exceeding the \$25,000 threshold.

g. A participant in a covered transaction may rely upon a certification of a prospective participant in a lower tier covered transaction that is not debarred, suspended, ineligible, or voluntarily excluded from the covered transaction, unless it knows that the certification is erroneous. A participant is responsible for ensuring that its principals are not suspended, debarred, or otherwise ineligible to participate in covered transactions. To verify the eligibility of its principals, as well as the eligibility of any lower tier prospective participants, each participant may, but is not required to, check the Excluded Parties List System website (<https://www.epls.gov/>), which is compiled by the General Services Administration.

h. Nothing contained in the foregoing shall be construed to require establishment of a system of records in order to render in good faith the certification required by this clause. The knowledge and information of participant is not required to exceed that which is normally possessed by a prudent person in the ordinary course of business dealings.

i. Except for transactions authorized under paragraph e of these instructions, if a participant in a covered transaction knowingly enters into a lower tier covered transaction with a person who is suspended, debarred, ineligible, or voluntarily excluded from participation in this transaction, in addition to other remedies available to the Federal Government, the

department or agency with which this transaction originated may pursue available remedies, including suspension and/or debarment.

* * * * *

Certification Regarding Debarment, Suspension, Ineligibility and Voluntary Exclusion--Lower Tier Participants:

1. The prospective lower tier participant certifies, by submission of this proposal, that neither it nor its principals is presently debarred, suspended, proposed for debarment, declared ineligible, or voluntarily excluded from participating in covered transactions by any Federal department or agency.

2. Where the prospective lower tier participant is unable to certify to any of the statements in this certification, such prospective participant shall attach an explanation to this proposal.

* * * * *

XI. CERTIFICATION REGARDING USE OF CONTRACT FUNDS FOR LOBBYING

This provision is applicable to all Federal-aid construction contracts and to all related subcontracts which exceed \$100,000 (49 CFR 20).

1. The prospective participant certifies, by signing and submitting this bid or proposal, to the best of his or her knowledge and belief, that:

a. No Federal appropriated funds have been paid or will be paid, by or on behalf of the undersigned, to any person for influencing or attempting to influence an officer or employee of any Federal agency, a Member of Congress, an officer or employee of Congress, or an employee of a Member of Congress in connection with the awarding of any Federal contract, the making of any Federal grant, the making of any Federal loan, the entering into of any cooperative agreement, and the extension, continuation, renewal, amendment, or modification of any Federal contract, grant, loan, or cooperative agreement.

b. If any funds other than Federal appropriated funds have been paid or will be paid to any person for influencing or attempting to influence an officer or employee of any Federal agency, a Member of Congress, an officer or employee of Congress, or an employee of a Member of Congress in connection with this Federal contract, grant, loan, or cooperative agreement, the undersigned shall complete and submit Standard Form-LLL, "Disclosure Form to Report Lobbying," in accordance with its instructions.

2. This certification is a material representation of fact upon which reliance was placed when this transaction was made or entered into. Submission of this certification is a prerequisite for making or entering into this transaction imposed by 31 U.S.C. 1352. Any person who fails to file the required certification shall be subject to a civil penalty of not less than \$10,000 and not more than \$100,000 for each such failure.

3. The prospective participant also agrees by submitting its bid or proposal that the participant shall require that the language of this certification be included in all lower tier subcontracts, which exceed \$100,000 and that all such recipients shall certify and disclose accordingly.

**ATTACHMENT A - EMPLOYMENT AND MATERIALS
PREFERENCE FOR APPALACHIAN DEVELOPMENT
HIGHWAY SYSTEM OR APPALACHIAN LOCAL ACCESS
ROAD CONTRACTS**

This provision is applicable to all Federal-aid projects funded under the Appalachian Regional Development Act of 1965.

1. During the performance of this contract, the contractor undertaking to do work which is, or reasonably may be, done as on-site work, shall give preference to qualified persons who regularly reside in the labor area as designated by the DOL wherein the contract work is situated, or the subregion, or the Appalachian counties of the State wherein the contract work is situated, except:

a. To the extent that qualified persons regularly residing in the area are not available.

b. For the reasonable needs of the contractor to employ supervisory or specially experienced personnel necessary to assure an efficient execution of the contract work.

c. For the obligation of the contractor to offer employment to present or former employees as the result of a lawful collective bargaining contract, provided that the number of nonresident persons employed under this subparagraph (1c) shall not exceed 20 percent of the total number of employees employed by the contractor on the contract work, except as provided in subparagraph (4) below.

2. The contractor shall place a job order with the State Employment Service indicating (a) the classifications of the laborers, mechanics and other employees required to perform the contract work, (b) the number of employees required in each classification, (c) the date on which the participant estimates such employees will be required, and (d) any other pertinent information required by the State Employment Service to complete the job order form. The job order may be placed with the State Employment Service in writing or by telephone. If during the course of the contract work, the information submitted by the contractor in the original job order is substantially modified, the participant shall promptly notify the State Employment Service.

3. The contractor shall give full consideration to all qualified job applicants referred to him by the State Employment Service. The contractor is not required to grant employment to any job applicants who, in his opinion, are not qualified to perform the classification of work required.

4. If, within one week following the placing of a job order by the contractor with the State Employment Service, the State Employment Service is unable to refer any qualified job applicants to the contractor, or less than the number requested, the State Employment Service will forward a certificate to the contractor indicating the unavailability of applicants. Such certificate shall be made a part of the contractor's permanent project records. Upon receipt of this certificate, the contractor may employ persons who do not normally reside in the labor area to fill positions covered by the certificate, notwithstanding the provisions of subparagraph (1c) above.

5. The provisions of 23 CFR 633.207(e) allow the contracting agency to provide a contractual preference for the use of mineral resource materials native to the Appalachian region.

6. The contractor shall include the provisions of Sections 1 through 4 of this Attachment A in every subcontract for work which is, or reasonably may be, done as on-site work.

**KENTUCKY TRANSPORTATION CABINET
DEPARTMENT OF HIGHWAYS**

**EMPLOYMENT REQUIREMENTS
RELATING TO
NONDISCRIMINATION OF EMPLOYEES
(APPLICABLE TO FEDERAL-AID SYSTEM CONTRACTS)**

**AN ACT OF THE KENTUCKY GENERAL ASSEMBLY
TO PREVENT DISCRIMINATION IN EMPLOYMENT**

**KRS CHAPTER 344
EFFECTIVE JUNE 16, 1972**

The contract on this project, in accordance with KRS Chapter 344, provides that during the performance of this contract, the contractor agrees as follows:

1. The contractor shall not fail or refuse to hire, or shall not discharge any individual, or otherwise discriminate against an individual with respect to his compensation, terms, conditions, or privileges of employment, because of such individual's race, color, religion, national origin, sex, disability or age (forty and above); or limit, segregate, or classify his employees in any way which would deprive or tend to deprive an individual of employment opportunities or otherwise adversely affect his status as an employee, because of such individual's race, color, religion, national origin, sex, disability or age forty (40) and over. The contractor agrees to post in conspicuous places, available to employees and applicants for employment, notices to be provided setting forth the provisions of this nondiscrimination clause.

2. The contractor shall not print or publish or cause to be printed or published a notice or advertisement relating to employment by such an employer or membership in or any classification or referral for employment by the employment agency, indicating any preference, limitation, specification, or discrimination, based on race, color, religion, national origin, sex, or age forty (40) and over, or because the person is a qualified individual with a disability, except that such a notice or advertisement may indicate a preference, limitation, or specification based on religion, national origin, sex, or age forty (40) and over, or because the person is a qualified individual with a disability, when religion, national origin, sex, or age forty (40) and over, or because the person is a qualified individual with a disability, is a bona fide occupational qualification for employment.

3. If the contractor is in control of apprenticeship or other training or retraining, including on-the-job training programs, he shall not discriminate against an individual because of his race, color, religion, national origin, sex, disability or age forty (40) and over, in admission to, or employment in any program established to provide apprenticeship or other training.

4. The contractor will send to each labor union or representative of workers with which he has a collective bargaining agreement or other contract or understanding, a notice to be provided advising the said labor union or workers' representative of the contractor's commitments under this section, and shall post copies of the notice in conspicuous places available to employees and applicants for employment. The contractor will take such action with respect to any subcontract or purchase order as the administering agency may direct as a means of enforcing such provisions, including sanctions for non-compliance.

Revised: January 25, 2017

Standard Title VI/Non-Discrimination Assurances

During the performance of this contract, the contractor, for itself, its assignees, and successors in interest (hereinafter referred to as the "contractor") agrees as follows:

1. **Compliance with Regulations:** The contractor (hereinafter includes consultants) will comply with the Acts and the Regulations relative to Non-discrimination in Federally-assisted programs of the U.S. Department of Transportation, **Federal Highway Administration**, as they may be amended from time to time, which are herein incorporated by reference and made a part of this contract.
2. **Non-discrimination:** The contractor, with regard to the work performed by it during the contract, will not discriminate on the grounds of race, color, or national origin in the selection and retention of subcontractors, including procurements of materials and leases of equipment. The contractor will not participate directly or indirectly in the discrimination prohibited by the Acts and the Regulations, including employment practices when the contract covers any activity, project, or program set forth in Appendix B of 49 CFR Part 21.
3. **Solicitations for Subcontracts, Including Procurements of Materials and Equipment:** In all solicitations, either by competitive bidding, or negotiation made by the contractor for work to be performed under a subcontract, including procurements of materials, or leases of equipment, each potential subcontractor or supplier will be notified by the contractor of the contractor's obligations under this contract and the Acts and the Regulations relative to Non-discrimination on the grounds of race, color, or national origin.
4. **Information and Reports:** The contractor will provide all information and reports required by the Acts, the Regulations, and directives issued pursuant thereto and will permit access to its books, records, accounts, other sources of information, and its facilities as may be determined by the Recipient or the **Federal Highway Administration** to be pertinent to ascertain compliance with such Acts, Regulations, and instructions. Where any information required of a contractor is in the exclusive possession of another who fails or refuses to furnish the information, the contractor will so certify to the Recipient or the **Federal Highway Administration**, as appropriate, and will set forth what efforts it has made to obtain the information.
5. **Sanctions for Noncompliance:** In the event of a contractor's noncompliance with the Non-discrimination provisions of this contract, the Recipient will impose such contract sanctions as it or the **Federal Highway Administration** may determine to be appropriate, including, but not limited to:
 - a. withholding payments to the contractor under the contract until the contractor complies; and/or
 - b. cancelling, terminating, or suspending a contract, in whole or in part.
6. **Incorporation of Provisions:** The contractor will include the provisions of paragraphs one through six in every subcontract, including procurements of materials and leases of equipment, unless exempt by the Acts, the Regulations and directives issued pursuant thereto. The contractor will take action with respect to any subcontract or procurement as the Recipient or the **Federal Highway Administration** may direct as a means of enforcing such provisions including sanctions for noncompliance. Provided, that if the contractor becomes involved in, or is threatened with litigation by a subcontractor, or supplier because of such direction, the contractor may request the Recipient to enter into any litigation to protect the interests of the Recipient. In addition, the contractor may request the United States to enter into the litigation to protect the interests of the United States.

Standard Title VI/Non-Discrimination Statutes and Authorities

During the performance of this contract, the contractor, for itself, its assignees, and successors in interest (hereinafter referred to as the “contractor”) agrees to comply with the following non-discrimination statutes and authorities; including but not limited to:

- Title VI of the Civil Rights Act of 1964 (42 U.S.C. § 2000d *et seq.*, 78 stat. 252), (prohibits discrimination on the basis of race, color, national origin); and 49 CFR Part 21;
- The Uniform Relocation Assistance and Real Property Acquisition Policies Act of 1970, (42 U.S.C. § 4601), (prohibits unfair treatment of persons displaced or whose property has been acquired because of Federal or Federal-aid programs and projects);
- Federal-Aid Highway Act of 1973, (23 U.S.C. § 324 *et seq.*), (prohibits discrimination on the basis of sex);
- Section 504 of the Rehabilitation Act of 1973, (29 U.S.C. § 794 *et seq.*), as amended, (prohibits discrimination on the basis of disability); and 49 CFR Part 27;
- The Age Discrimination Act of 1975, as amended, (42 U.S.C. § 6101 *et seq.*), (prohibits discrimination on the basis of age);
- Airport and Airway Improvement Act of 1982, (49 USC § 471, Section 47123), as amended, (prohibits discrimination based on race, creed, color, national origin, or sex);
- The Civil Rights Restoration Act of 1987, (PL 100-209), (Broadened the scope, coverage and applicability of Title VI of the Civil Rights Act of 1964, The Age Discrimination Act of 1975 and Section 504 of the Rehabilitation Act of 1973, by expanding the definition of the terms “programs or activities” to include all of the programs or activities of the Federal-aid recipients, sub-recipients and contractors, whether such programs or activities are Federally funded or not);
- Titles II and III of the Americans with Disabilities Act, which prohibit discrimination on the basis of disability in the operation of public entities, public and private transportation systems, places of public accommodation, and certain testing entities (42 U.S.C. §§ 12131 -- 12189) as implemented by Department of Transportation regulations at 49 C.F.R. parts 37 and 38;
- The Federal Aviation Administration’s Non-discrimination statute (49 U.S.C. § 47123) (prohibits discrimination on the basis of race, color, national origin, and sex);
- Executive Order 12898, Federal Actions to Address Environmental Justice in Minority Populations and Low-Income Populations, which ensures non-discrimination against minority populations by discouraging programs, policies, and activities with disproportionately high and adverse human health or environmental effects on minority and low-income populations;
- Executive Order 13166, Improving Access to Services for Persons with Limited English Proficiency, and resulting agency guidance, national origin discrimination includes discrimination because of limited English proficiency (LEP). To ensure compliance with Title VI, you must take reasonable steps to ensure that LEP persons have meaningful access to your programs (70 Fed. Reg. at 74087 to 74100);
- Title IX of the Education Amendments of 1972, as amended, which prohibits you from discriminating because of sex in education programs or activities (20 U.S.C. 1681 *et seq.*)

EXECUTIVE BRANCH CODE OF ETHICS

In the 1992 regular legislative session, the General Assembly passed and Governor Brereton Jones signed Senate Bill 63 (codified as KRS 11A), the Executive Branch Code of Ethics, which states, in part:

KRS 11A.040 (7) provides:

No present or former public servant shall, within six (6) months following termination of his office or employment, accept employment, compensation, or other economic benefit from any person or business that contracts or does business with, or is regulated by, the state in matters in which he was directly involved during the last thirty-six (36) months of his tenure. This provision shall not prohibit an individual from returning to the same business, firm, occupation, or profession in which he was involved prior to taking office or beginning his term of employment, or for which he received, prior to his state employment, a professional degree or license, provided that, for a period of six (6) months, he personally refrains from working on any matter in which he was directly involved during the last thirty-six (36) months of his tenure in state government. This subsection shall not prohibit the performance of ministerial functions, including but not limited to filing tax returns, filing applications for permits or licenses, or filing incorporation papers, nor shall it prohibit the former officer or public servant from receiving public funds disbursed through entitlement programs.

KRS 11A.040 (9) states:

A former public servant shall not represent a person or business before a state agency in a matter in which the former public servant was directly involved during the last thirty-six (36) months of his tenure, for a period of one (1) year after the latter of:

- a) The date of leaving office or termination of employment; or
- b) The date the term of office expires to which the public servant was elected.

This law is intended to promote public confidence in the integrity of state government and to declare as public policy the idea that state employees should view their work as a public trust and not as a way to obtain private benefits.

If you have worked for the executive branch of state government within the past six months, you may be subject to the law's prohibitions. The law's applicability may be different if you hold elected office or are contemplating representation of another before a state agency.

Also, if you are affiliated with a firm which does business with the state and which employs former state executive-branch employees, you should be aware that the law may apply to them.

In case of doubt, the law permits you to request an advisory opinion from the Executive Branch Ethics Commission, 3 Fountain Place, Frankfort, Kentucky 40601; telephone (502) 564-7954.

Revised: January 27, 2017

General Decision Number: KY190038 02/15/2019 KY38

Superseded General Decision Number: KY20180100

State: Kentucky

Construction Type: Highway

Counties: Anderson, Bath, Bourbon, Boyd, Boyle, Bracken, Breckinridge, Bullitt, Carroll, Carter, Clark, Elliott, Fayette, Fleming, Franklin, Gallatin, Grant, Grayson, Greenup, Hardin, Harrison, Henry, Jefferson, Jessamine, Larue, Lewis, Madison, Marion, Mason, Meade, Mercer, Montgomery, Nelson, Nicholas, Oldham, Owen, Robertson, Rowan, Scott, Shelby, Spencer, Trimble, Washington and Woodford Counties in Kentucky.

HIGHWAY CONSTRUCTION PROJECTS (excluding tunnels, building structures in rest area projects & railroad construction; bascule, suspension & spandrel arch bridges designed for commercial navigation, bridges involving marine construction; and other major bridges).

Note: Under Executive Order (EO) 13658, an hourly minimum wage of \$10.60 for calendar year 2019 applies to all contracts subject to the Davis-Bacon Act for which the contract is awarded (and any solicitation was issued) on or after January 1, 2015. If this contract is covered by the EO, the contractor must pay all workers in any classification listed on this wage determination at least \$10.60 per hour (or the applicable wage rate listed on this wage determination, if it is higher) for all hours spent performing on the contract in calendar year 2019. If this contract is covered by the EO and a classification considered necessary for performance of work on the contract does not appear on this wage determination, the contractor must pay workers in that classification at least the wage rate determined through the conformance process set forth in 29 CFR 5.5(a)(1)(ii) (or the EO minimum wage rate, if it is higher than the conformed wage rate). The EO minimum wage rate will be adjusted annually. Please note that this EO applies to the above-mentioned types of contracts entered into by the federal government that are subject to the Davis-Bacon Act itself, but it does not apply to contracts subject only to the Davis-Bacon Related Acts, including those set forth at 29 CFR 5.1(a)(2)-(60). Additional information on contractor requirements and worker protections under the EO is available at www.dol.gov/whd/govcontracts.

Modification Number	Publication Date
0	01/04/2019
1	02/15/2019

BRIN0004-003 06/01/2017

BRECKENRIDGE COUNTY

Rates Fringes

BRICKLAYER.....\$ 26.80 12.38

BRKY0001-005 06/01/2017

BULLITT, CARROLL, GRAYSON, HARDIN, HENRY, JEFFERSON, LARUE,
MARION, MEADE, NELSON, OLDHAM, SHELBY, SPENCER, & TRIMBLE
COUNTIES:

Rates Fringes
BRICKLAYER.....\$ 26.80 12.38

BRKY0002-006 06/01/2017

BRACKEN, GALLATIN, GRANT, MASON & ROBERTSON COUNTIES:

Rates Fringes
BRICKLAYER.....\$ 27.81 13.01

BRKY0007-004 06/01/2017

BOYD, CARTER, ELLIOT, FLEMING, GREENUP, LEWIS & ROWAN COUNTIES:

Rates Fringes
BRICKLAYER.....\$ 32.98 19.02

BRKY0017-004 06/01/2017

ANDERSON, BATH, BOURBON, BOYLE, CLARK, FAYETTE, FRANKLIN,
HARRISON, JESSAMINE, MADISON, MERCER, MONTGOMERY, NICHOLAS,
OWEN, SCOTT, WASHINGTON & WOODFORD COUNTIES:

Rates Fringes
BRICKLAYER.....\$ 26.47 12.76

CARP0064-001 05/01/2015

Rates Fringes
CARPENTER.....\$ 27.50 16.06
Diver.....\$ 41.63 16.06
PILEDRIVERMAN.....\$ 27.75 16.06

ELEC0212-008 06/04/2018

BRACKEN, GALLATIN and GRANT COUNTIES

Rates Fringes
ELECTRICIAN.....\$ 28.39 18.98

* ELEC0212-014 11/26/2018

BRACKEN, GALLATIN & GRANT COUNTIES:

	Rates	Fringes
Sound & Communication Technician.....	\$ 24.35	10.99

ELEC0317-012 06/01/2018		

BOYD, CARTER, ELLIOT & ROWAN COUNTIES:

	Rates	Fringes
ELECTRICIAN (Wiremen) Cable Splicer.....	\$ 32.68	18.13
Electrician.....	\$ 33.75	20.03

ELEC0369-007 05/30/2018		

ANDERSON, BATH, BOURBON, BOYLE, BRECKINRIDGE, BULLITT, CARROLL,
 CLARK, FAYETTE, FRAONKLIN, GRAYSON, HARDIN, HARRISON, HENRY,
 JEFFERSON, JESSAMINE, LARUE, MADISON, MARION, MEADE, MERCER,
 MONTGOMERY, NELSON, NICHOLAS, OLDHAM, OWEN, ROBERTSON, SCOTT,
 SHELBY, SPENCER, TRIMBLE, WASHINGTON, & WOODFORD COUNTIES:

	Rates	Fringes
ELECTRICIAN.....	\$ 31.66	17.01

* ELEC0575-002 12/31/2018

FLEMING, GREENUP, LEWIS & MASON COUNTIES:

	Rates	Fringes
ELECTRICIAN.....	\$ 32.75	16.69

ENGI0181-018 07/01/2017		

	Rates	Fringes
POWER EQUIPMENT OPERATOR GROUP 1.....	\$ 31.95	15.15
GROUP 2.....	\$ 29.09	15.15
GROUP 3.....	\$ 29.54	15.15
GROUP 4.....	\$ 28.77	15.15

OPERATING ENGINEER CLASSIFICATIONS

GROUP 1 - A-Frame Winch Truck; Auto Patrol; Backfiller;
 Batcher Plant; Bituminous Paver; Bituminous Transfer
 Machine; Boom Cat; Bulldozer; Mechanic; Cableway; Carry-All
 Scoop; Carry Deck Crane; Central Compressor Plant; Cherry
 Picker; Clamshell; Concrete Mixer (21 cu. ft. or Over);
 Concrete Paver; Truck-Mounted Concrete Pump; Core Drill;
 Crane; Crusher Plant; Derrick; Derrick Boat; Ditching &
 Trenching Machine; Dragline; Dredge Operator; Dredge
 Engineer; Elevating Grader & Loaders; Grade-All; Gurries;
 Heavy Equipment Robotics Operator/Mechanic; High Lift;
 Hoe-Type Machine; Hoist (Two or More Drums); Hoisting
 Engine (Two or More Drums); Horizontal Directional Drill

Operator; Hydrocrane; Hyster; KeCal Loader; LeTourneau; Locomotive; Mechanic; Mechanically Operated Laser Screed; Mechanic Welder; Mucking Machine; Motor Scraper; Orangepeel Bucket; Overhead Crane; Piledriver; Power Blade; Pumpcrete; Push Dozer; Rock Spreader, attached to equipment; Rotary Drill; Roller (Bituminous); Rough Terrain Crane; Scarifier; Scoopmobile; Shovel; Side Boom; Subgrader; Tailboom; Telescoping Type Forklift; Tow or Push Boat; Tower Crane (French, German & other types); Tractor Shovel; Truck Crane; Tunnel Mining Machines, including Moles, Shields or similar types of Tunnel Mining Equipment

GROUP 2 - Air Compressor (Over 900 cu. ft. per min.); Bituminous Mixer; Boom Type Tamping Machine; Bull Float; Concrete Mixer (Under 21 cu. ft.); Dredge Engineer; Electric Vibrator; Compactor/Self-Propelled Compactor; Elevator (One Drum or Buck Hoist); Elevator (When used to Hoist Building Material); Finish Machine; Firemen & Hoist (One Drum); Flexplane; Forklift (Regardless of Lift Height); Form Grader; Joint Sealing Machine; Outboard Motor Boat; Power Sweeper (Riding Type); Roller (Rock); Ross Carrier; Skid Mounted or Trailer Mounted Concrete Pump; Skid Steer Machine with all Attachments; Switchman or Brakeman; Throttle Valve Person; Tractair & Road Widening Trencher; Tractor (50 H.P. or Over); Truck Crane Oiler; Tugger; Welding Machine; Well Points; & Whirley Oiler

GROUP 3 - All Off Road Material Handling Equipment, including Articulating Dump Trucks; Greaser on Grease Facilities servicing Heavy Equipment

GROUP 4 - Bituminous Distributor; Burlap & Curing Machine; Cement Gun; Concrete Saw; Conveyor; Deckhand Oiler; Grout Pump; Hydraulic Post Driver; Hydro Seeder; Mud Jack; Oiler; Paving Joint Machine; Power Form Handling Equipment; Pump; Roller (Earth); Steerman; Tamping Machine; Tractor (Under 50 H.P.); & Vibrator

CRANES - with booms 150 ft. & Over (Including JIB), and where the length of the boom in combination with the length of the piling leads equals or exceeds 150 ft. - \$1.00 over Group 1 rate

EMPLOYEES ASSIGNED TO WORK BELOW GROUND LEVEL ARE TO BE PAID 10% ABOVE BASIC WAGE RATE. THIS DOES NOT APPLY TO OPEN CUT WORK.

IRON0044-009 06/01/2018

BRACKEN, GALLATIN, GRANT, HARRISON, ROBERTSON,
BOURBON (Northern third, including Townships of Jackson, Millersburg, Ruddel Mills & Shawhan);
CARROLL (Eastern third, including the Township of Ghent);
FLEMING (Western part, excluding Townships of Beechburg, Colfax, Elizaville, Flemingsburg, Flemingsburg Junction, Foxport, Grange City, Hillsboro, Hilltop, Mount Carmel, Muses Mills, Nepton, Pecksridge, Plummers Landing, Plummers Mill, Poplar Plains, Ringos Mills, Tilton & Wallingford);
MASON (Western two-thirds, including Townships of Dover,

Lewisburg, Mays Lick, Maysville, Minerva, Moranburg, Murphysville, Ripley, Sardis, Shannon, South Ripley & Washington);
 NICHOLAS (Townships of Barefoot, Barterville, Carlisle, Ellisville, Headquarters, Henryville, Morningglory, Myers & Oakland Mills);
 OWEN (Townships of Beechwood, Bromley, Fairbanks, Holbrook, Jonesville, Long Ridge, Lusby's Mill, New, New Columbus, New Liberty, Owenton, Poplar Grove, Rockdale, Sanders, Teresita & Wheatley);
 SCOTT (Northern two-thirds, including Townships of Biddle, Davis, Delaplain, Elmville, Longlick, Muddy Ford, Oxford, Rogers Gap, Sadieville, Skinnersburg & Stonewall)

	Rates	Fringes
IRONWORKER		
Fence Erector.....	\$ 26.76	21.20
Structural.....	\$ 28.17	21.20

 IRON0070-006 06/01/2018

ANDERSON, BOYLE, BRECKINRIDGE, BULLITT, FAYETTE, FRANKLIN, GRAYSON, HARDIN, HENRY, JEFFERSON, JESSAMINE, LARUE, MADISON, MARION, MEADE, MERCER, NELSON, OLDHAM, SHELBY, SPENCER, TRIMBLE, WASHINGTON & WOODFORD
 BOURBON (Southern two-thirds, including Townships of Austerlity, Centerville, Clintonville, Elizabeth, Hutchison, Littlerock, North Middletown & Paris);
 CARROLL (Western two-thirds, including Townships of Carrollton, Easterday, English, Locust, Louis, Prestonville & Worthville);
 CLARK (Western two-thirds, including Townships of Becknerville, Flanagan, Ford, Pine Grove, Winchester & Wyandotte);
 OWEN (Eastern eighth, including Townships of Glenmary, Gratz, Monterey, Perry Park & Tacketts Mill);
 SCOTT (Southern third, including Townships of Georgetown, Great Crossing, Newtown, Stampling Ground & Woodlake);

	Rates	Fringes
IRONWORKER.....	\$ 28.79	22.50

 IRON0769-007 06/01/2018

BATH, BOYD, CARTER, ELLIOTT, GREENUP, LEWIS, MONTGOMERY & ROWAN
 CLARK (Eastern third, including townships of Bloomingdale, Hunt, Indian Fields, Kiddville, Loglick, Rightangele & Thomson);
 FLEMING (Townships of Beechburg, Colfax, Elizaville, Flemingsburg, Flemingsburg Junction, Foxport, Grange City, Hillsboro, Hilltop, Mount Carmel, Muses Mills, Nepton, Pecksville, Plummers Landing, Plummers Mill, Poplar Plains, Ringos Mills, Tilton & Wallingford);
 MASON (Eastern third, including Townships of Helena, Marshall, Orangeburg, Plumville & Springdale);
 NICHOLAS (Eastern eighth, including the Township of Moorefield Sprout)

	Rates	Fringes
IRONWORKER		
ZONE 1.....	\$ 31.67	25.27
ZONE 2.....	\$ 31.67	25.27
ZONE 3.....	\$ 31.67	25.27

ZONE 1 - (no base rate increase) Up to 10 mile radius of Union Hall, 1643 Greenup Ave, Ashland, KY.

ZONE 2 - (add \$0.40 per hour to base rate) 10 to 50 mile radius of Union Hall, 1643 Greenup Ave, Ashland, KY.

ZONE 3 - (add \$2.00 per hour to base rate) 50 mile radius & over of Union Hall, 1643 Greenup Ave, Ashland, KY.

LAB00189-003 07/01/2018

BATH, BOURBON, BOYD, BOYLE, BRACKEN, CARTER, CLARK, ELLIOTT, FAYETTE, FLEMING, FRANKLIN, GALLATIN, GRANT, GREENUP, HARRISON, JESSAMINE, LEWIS, MADISON, MASON, MERCER, MONTGOMERY, NICHOLAS, OWEN, ROBERTSON, ROWAN, SCOTT, & WOOLFORD COUNTIES

	Rates	Fringes
Laborers:		
GROUP 1.....	\$ 23.07	14.21
GROUP 2.....	\$ 23.32	14.21
GROUP 3.....	\$ 23.37	14.21
GROUP 4.....	\$ 23.97	14.21

LABORERS CLASSIFICATIONS

GROUP 1 - Aging & Curing of Concrete; Asbestos Abatement Worker; Asphalt Plant; Asphalt; Batch Truck Dump; Carpenter Tender; Cement Mason Tender; Cleaning of Machines; Concrete; Demolition; Dredging; Environmental - Nuclear, Radiation, Toxic & Hazardous Waste - Level D; Flagperson; Grade Checker; Hand Digging & Hand Back Filling; Highway Marker Placer; Landscaping, Mesh Handler & Placer; Puddler; Railroad; Rip-rap & Grouter; Right-of-Way; Sign, Guard Rail & Fence Installer; Signal Person; Sound Barrier Installer; Storm & Sanitary Sewer; Swamper; Truck Spotter & Dumper; Wrecking of Concrete Forms; General Cleanup

GROUP 2 - Batter Board Man (Sanitary & Storm Sewer); Brickmason Tender; Mortar Mixer Operator; Scaffold Builder; Burner & Welder; Bushhammer; Chain Saw Operator; Concrete Saw Operator; Deckhand Scow Man; Dry Cement Handler; Environmental - Nuclear, Radiation, Toxic & Hazardous Waste - Level C; Forklift Operator for Masonary; Form Setter; Green Concrete Cutting; Hand Operated Grouter & Grinder Machine Operator; Jackhammer; Pavement Breaker; Paving Joint Machine; Pipelayer; Plastic Pipe Fusion; Power Driven Georgia Buggy & Wheel Barrow; Power Post Hole Digger; Precast Manhole Setter; Walk-Behind Tamper; Walk-Behind Trencher; Sand Blaster; Concrete Chipper; Surface Grinder; Vibrator Operator; Wagon Driller

GROUP 3 - Asphalt Luteman & Raker; Gunnite Nozzleman;
Gunnite Operator & Mixer; Grout Pump Operator; Side Rail
Setter; Rail Paved Ditches; Screw Operator; Tunnel (Free
Air); Water Blaster

GROUP 4 - Caisson Worker (Free Air); Cement Finisher;
Environmental - Nuclear, Radiation, Toxic & Hazardous Waste
- Levels A & B; Miner & Driller (Free Air); Tunnel Blaster;
& Tunnel Mucker (Free Air); Directional & Horizontal
Boring; Air Track Drillers (All Types); Powdermen &
Blasters; Troxler & Concrete Tester if Laborer is Utilized

LAB00189-008 07/01/2018

ANDERSON, BULLITT, CARROLL, HARDIN, HENRY, JEFFERSON, LARUE,
MARION, MEADE, NELSON, OLDHAM, SHELBY, SPENCER, TRIMBLE &
WASHINGTON COUNTIES

	Rates	Fringes
Laborers:		
GROUP 1.....	\$ 23.07	14.21
GROUP 2.....	\$ 23.32	14.21
GROUP 3.....	\$ 23.37	14.21
GROUP 4.....	\$ 23.97	14.21

LABORERS CLASSIFICATIONS

GROUP 1 - Aging & Curing of Concrete; Asbestos Abatement
Worker; Asphalt Plant; Asphalt; Batch Truck Dump; Carpenter
Tender; Cement Mason Tender; Cleaning of Machines;
Concrete; Demolition; Dredging; Environmental - Nuclear,
Radiation, Toxic & Hazardous Waste - Level D; Flagperson;
Grade Checker; Hand Digging & Hand Back Filling; Highway
Marker Placer; Landscaping, Mesh Handler & Placer; Puddler;
Railroad; Rip-rap & Grouter; Right-of-Way; Sign, Guard Rail
& Fence Installer; Signal Person; Sound Barrier Installer;
Storm & Sanitary Sewer; Swamper; Truck Spotter & Dumper;
Wrecking of Concrete Forms; General Cleanup

GROUP 2 - Batter Board Man (Sanitary & Storm Sewer);
Brickmason Tender; Mortar Mixer Operator; Scaffold Builder;
Burner & Welder; Bushhammer; Chain Saw Operator; Concrete
Saw Operator; Deckhand Scow Man; Dry Cement Handler;
Environmental - Nuclear, Radiation, Toxic & Hazardous Waste
- Level C; Forklift Operator for Masonary; Form Setter;
Green Concrete Cutting; Hand Operated Grouter & Grinder
Machine Operator; Jackhammer; Pavement Breaker; Paving
Joint Machine; Pipelayer; Plastic Pipe Fusion; Power Driven
Georgia Buggy & Wheel Barrow; Power Post Hole Digger;
Precast Manhole Setter; Walk-Behind Tamper; Walk-Behind
Trencher; Sand Blaster; Concrete Chipper; Surface Grinder;
Vibrator Operator; Wagon Driller

GROUP 3 - Asphalt Luteman & Raker; Gunnite Nozzleman;
Gunnite Operator & Mixer; Grout Pump Operator; Side Rail
Setter; Rail Paved Ditches; Screw Operator; Tunnel (Free

Air); Water Blaster

GROUP 4 - Caisson Worker (Free Air); Cement Finisher;
 Environmental - Nuclear, Radiation, Toxic & Hazardous Waste
 - Levels A & B; Miner & Driller (Free Air); Tunnel Blaster;
 & Tunnel Mucker (Free Air); Directional & Horizontal
 Boring; Air Track Drillers (All Types); Powdermen &
 Blasters; Troxler & Concrete Tester if Laborer is Utilized

 LABO0189-009 07/01/2018

BRECKINRIDGE & GRAYSON COUNTIES

	Rates	Fringes
Laborers:		
GROUP 1.....	\$ 23.07	14.21
GROUP 2.....	\$ 23.32	14.21
GROUP 3.....	\$ 23.37	14.21
GROUP 4.....	\$ 23.97	14.21

LABORERS CLASSIFICATIONS

GROUP 1 - Aging & Curing of Concrete; Asbestos Abatement
 Worker; Asphalt Plant; Asphalt; Batch Truck Dump; Carpenter
 Tender; Cement Mason Tender; Cleaning of Machines;
 Concrete; Demolition; Dredging; Environmental - Nuclear,
 Radiation, Toxic & Hazardous Waste - Level D; Flagperson;
 Grade Checker; Hand Digging & Hand Back Filling; Highway
 Marker Placer; Landscaping, Mesh Handler & Placer; Puddler;
 Railroad; Rip-rap & Grouter; Right-of-Way; Sign, Guard Rail
 & Fence Installer; Signal Person; Sound Barrier Installer;
 Storm & Sanitary Sewer; Swamper; Truck Spotter & Dumper;
 Wrecking of Concrete Forms; General Cleanup

GROUP 2 - Batter Board Man (Sanitary & Storm Sewer);
 Brickmason Tender; Mortar Mixer Operator; Scaffold Builder;
 Burner & Welder; Bushhammer; Chain Saw Operator; Concrete
 Saw Operator; Deckhand Scow Man; Dry Cement Handler;
 Environmental - Nuclear, Radiation, Toxic & Hazardous Waste
 - Level C; Forklift Operator for Masonary; Form Setter;
 Green Concrete Cutting; Hand Operated Grouter & Grinder
 Machine Operator; Jackhammer; Pavement Breaker; Paving
 Joint Machine; Pipelayer; Plastic Pipe Fusion; Power Driven
 Georgia Buggy & Wheel Barrow; Power Post Hole Digger;
 Precast Manhole Setter; Walk-Behind Tamper; Walk-Behind
 Trencher; Sand Blaster; Concrete Chipper; Surface Grinder;
 Vibrator Operator; Wagon Driller

GROUP 3 - Asphalt Luteman & Raker; Gunnite Nozzleman;
 Gunnite Operator & Mixer; Grout Pump Operator; Side Rail
 Setter; Rail Paved Ditches; Screw Operator; Tunnel (Free
 Air); Water Blaster

GROUP 4 - Caisson Worker (Free Air); Cement Finisher;
 Environmental - Nuclear, Radiation, Toxic & Hazardous Waste
 - Levels A & B; Miner & Driller (Free Air); Tunnel Blaster;
 & Tunnel Mucker (Free Air); Directional & Horizontal
 Boring; Air Track Drillers (All Types); Powdermen &

Blasters; Troxler & Concrete Tester if Laborer is Utilized

PAIN0012-005 06/11/2005

BATH, BOURBON, BOYLE, CLARK, FAYETTE, FLEMING, FRANKLIN,
HARRISON, JESSAMINE, MADISON, MERCER, MONTGOMERY, NICHOLAS,
ROBERTSON, SCOTT & WOODFORD COUNTIES:

	Rates	Fringes
PAINTER		
Bridge/Equipment Tender and/or Containment Builder..\$	18.90	5.90
Brush & Roller.....\$	21.30	5.90
Elevated Tanks; Steeplejack Work; Bridge & Lead Abatement.....\$	22.30	5.90
Sandblasting & Waterblasting.....\$	22.05	5.90
Spray.....\$	21.80	5.90

PAIN0012-017 05/01/2015

BRACKEN, GALLATIN, GRANT, MASON & OWEN COUNTIES:

	Rates	Fringes
PAINTER (Heavy & Highway Bridges - Guardrails - Lightpoles - Striping)		
Bridge Equipment Tender and Containment Builder.....\$	20.73	9.06
Brush & Roller.....\$	23.39	9.06
Elevated Tanks; Steeplejack Work; Bridge & Lead Abatement.....\$	24.39	9.06
Sandblasting & Water Blasting.....\$	24.14	9.06
Spray.....\$	23.89	9.06

PAIN0118-004 06/01/2018

ANDERSON, BRECKINRIDGE, BULLITT, CARROLL, GRAYSON, HARDIN,
HENRY, JEFFERSON, LARUE, MARION, MEADE, NELSON, OLDHAM, SHELBY,
SPENCER, TRIMBLE & WASHINGTON COUNTIES:

	Rates	Fringes
PAINTER		
Brush & Roller.....\$	22.00	12.52
Spray, Sandblast, Power Tools, Waterblast & Steam Cleaning.....\$	23.00	12.52

PAIN1072-003 12/01/2018

BOYD, CARTER, ELLIOTT, GREENUP, LEWIS and ROWAN COUNTIES

Rates Fringes

Painters:

Bridges; Locks; Dams; Tension Towers & Energized Substations.....	\$ 33.33	18.50
Power Generating Facilities.	\$ 30.09	18.50

PLUM0248-003 06/01/2018

BOYD, CARTER, ELLIOTT, GREENUP, LEWIS & ROWAN COUNTIES:

Rates Fringes

Plumber and Steamfitter.....	\$ 36.00	20.23
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PLUM0392-007 06/01/2018

BRACKEN, CARROLL (Eastern Half), GALLATIN, GRANT, MASON, OWEN & ROBERTSON COUNTIES:

Rates Fringes

Plumbers and Pipefitters.....	\$ 32.01	19.67
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PLUM0502-003 08/01/2018

BRECKINRIDGE, BULLITT, CARROLL (Western Half), FRANKLIN (Western three-fourths), GRAYSON, HARDIN, HENRY, JEFFERSON, LARUE, MARION, MEADE, NELSON, OLDHAM, SHELBY, SPENCER, TRIMBLE & WASHINGTON COUNTIES

Rates Fringes

PLUMBER.....	\$ 34.62	20.78
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SUKY2010-160 10/08/2001

Rates Fringes

Truck drivers:

GROUP 1.....	\$ 16.57	7.34
GROUP 2.....	\$ 16.68	7.34
GROUP 3.....	\$ 16.86	7.34
GROUP 4.....	\$ 16.96	7.34

TRUCK DRIVER CLASSIFICATIONS

- GROUP 1 - Mobile Batch Truck Tender
- GROUP 2 - Greaser; Tire Changer; & Mechanic Tender
- GROUP 3 - Single Axle Dump; Flatbed; Semi-trailer or Pole Trailer when used to pull building materials and equipment; Tandem Axle Dump; Distributor; Mixer; & Truck Mechanic
- GROUP 4 - Euclid & Other Heavy Earthmoving Equipment &

Lowboy; Articulator Cat; 5-Axle Vehicle; Winch & A-Frame
when used in transporting materials; Ross Carrier; Forklift
when used to transport building materials; & Pavement
Breaker

WELDERS - Receive rate prescribed for craft performing
operation to which welding is incidental.

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Note: Executive Order (EO) 13706, Establishing Paid Sick Leave
for Federal Contractors applies to all contracts subject to the
Davis-Bacon Act for which the contract is awarded (and any
solicitation was issued) on or after January 1, 2017. If this
contract is covered by the EO, the contractor must provide
employees with 1 hour of paid sick leave for every 30 hours
they work, up to 56 hours of paid sick leave each year.
Employees must be permitted to use paid sick leave for their
own illness, injury or other health-related needs, including
preventive care; to assist a family member (or person who is
like family to the employee) who is ill, injured, or has other
health-related needs, including preventive care; or for reasons
resulting from, or to assist a family member (or person who is
like family to the employee) who is a victim of, domestic
violence, sexual assault, or stalking. Additional information
on contractor requirements and worker protections under the EO
is available at www.dol.gov/whd/govcontracts.

Unlisted classifications needed for work not included within
the scope of the classifications listed may be added after
award only as provided in the labor standards contract clauses
(29CFR 5.5 (a) (1) (ii)).

The body of each wage determination lists the classification
and wage rates that have been found to be prevailing for the
cited type(s) of construction in the area covered by the wage
determination. The classifications are listed in alphabetical
order of "identifiers" that indicate whether the particular
rate is a union rate (current union negotiated rate for local),
a survey rate (weighted average rate) or a union average rate
(weighted union average rate).

Union Rate Identifiers

A four letter classification abbreviation identifier enclosed
in dotted lines beginning with characters other than "SU" or
"UAVG" denotes that the union classification and rate were
prevailing for that classification in the survey. Example:
PLUM0198-005 07/01/2014. PLUM is an abbreviation identifier of
the union which prevailed in the survey for this
classification, which in this example would be Plumbers. 0198
indicates the local union number or district council number
where applicable, i.e., Plumbers Local 0198. The next number,
005 in the example, is an internal number used in processing

the wage determination. 07/01/2014 is the effective date of the most current negotiated rate, which in this example is July 1, 2014.

Union prevailing wage rates are updated to reflect all rate changes in the collective bargaining agreement (CBA) governing this classification and rate.

Survey Rate Identifiers

Classifications listed under the "SU" identifier indicate that no one rate prevailed for this classification in the survey and the published rate is derived by computing a weighted average rate based on all the rates reported in the survey for that classification. As this weighted average rate includes all rates reported in the survey, it may include both union and non-union rates. Example: SULA2012-007 5/13/2014. SU indicates the rates are survey rates based on a weighted average calculation of rates and are not majority rates. LA indicates the State of Louisiana. 2012 is the year of survey on which these classifications and rates are based. The next number, 007 in the example, is an internal number used in producing the wage determination. 5/13/2014 indicates the survey completion date for the classifications and rates under that identifier.

Survey wage rates are not updated and remain in effect until a new survey is conducted.

Union Average Rate Identifiers

Classification(s) listed under the UAVG identifier indicate that no single majority rate prevailed for those classifications; however, 100% of the data reported for the classifications was union data. EXAMPLE: UAVG-OH-0010 08/29/2014. UAVG indicates that the rate is a weighted union average rate. OH indicates the state. The next number, 0010 in the example, is an internal number used in producing the wage determination. 08/29/2014 indicates the survey completion date for the classifications and rates under that identifier.

A UAVG rate will be updated once a year, usually in January of each year, to reflect a weighted average of the current negotiated/CBA rate of the union locals from which the rate is based.

WAGE DETERMINATION APPEALS PROCESS

1.) Has there been an initial decision in the matter? This can be:

- * an existing published wage determination
- * a survey underlying a wage determination
- * a Wage and Hour Division letter setting forth a position on a wage determination matter
- * a conformance (additional classification and rate) ruling

On survey related matters, initial contact, including requests for summaries of surveys, should be with the Wage and Hour Regional Office for the area in which the survey was conducted because those Regional Offices have responsibility for the Davis-Bacon survey program. If the response from this initial contact is not satisfactory, then the process described in 2.) and 3.) should be followed.

With regard to any other matter not yet ripe for the formal process described here, initial contact should be with the Branch of Construction Wage Determinations. Write to:

Branch of Construction Wage Determinations
Wage and Hour Division
U.S. Department of Labor
200 Constitution Avenue, N.W.
Washington, DC 20210

2.) If the answer to the question in 1.) is yes, then an interested party (those affected by the action) can request review and reconsideration from the Wage and Hour Administrator (See 29 CFR Part 1.8 and 29 CFR Part 7). Write to:

Wage and Hour Administrator
U.S. Department of Labor
200 Constitution Avenue, N.W.
Washington, DC 20210

The request should be accompanied by a full statement of the interested party's position and by any information (wage payment data, project description, area practice material, etc.) that the requestor considers relevant to the issue.

3.) If the decision of the Administrator is not favorable, an interested party may appeal directly to the Administrative Review Board (formerly the Wage Appeals Board). Write to:

Administrative Review Board
U.S. Department of Labor
200 Constitution Avenue, N.W.
Washington, DC 20210

4.) All decisions by the Administrative Review Board are final.

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END OF GENERAL DECISION

Fringe benefit amounts are applicable for all hours worked except when otherwise noted.

No laborer, workman or mechanic shall be paid at a rate less than that of a Journeyman except those classified as bona fide apprentices.

Apprentices or trainees shall be permitted to work as such subject to Administrative Regulations adopted by the Commissioner of Workplace Standards. Copies of these regulations will be furnished upon request from any interested person.

Before using apprentices on the job the contractor shall present to the Contracting Officer written evidence of registration of such employees in a program of a State apprenticeship and training agency approved and recognized by the U. S. Bureau of Apprenticeship and Training. In the absence of such a State agency, the contractor shall submit evidence of approval and registration by the U. S. Bureau of Apprenticeship and Training.

The contractor shall submit to the Contracting Officer, written evidence of the established apprenticeship-journeyman ratios and wage rates in the project area, which will be the basis for establishing such ratios and rates for the project under the applicable contract provisions.

TO: EMPLOYERS/EMPLOYEES

PREVAILING WAGE SCHEDULE:

The wages indicated on this wage schedule are the least permitted to be paid for the occupations indicated. When an employee works in more than one classification, the employer must record the number of hours worked in each classification at the prescribed hourly base rate.

OVERTIME:

Overtime is to be paid to an employee at a rate not less than one and one-half times the basic rate of pay for all hours worked in excess of forty (40) hours in such workweek. Wage violations or questions should be directed to the designated Engineer or the undersigned.

Director
Division of Construction Procurement
Frankfort, Kentucky 40622
502-564-3500

**NOTICE OF REQUIREMENT FOR AFFIRMATIVE ACTION
TO ENSURE EQUAL EMPLOYMENT OPPORTUNITY
(Executive Order 11246)**

1. The Offeror's or Bidder's attention is called to the "Equal Opportunity Clause" and the "Standard Federal Equal Employment Specifications" set forth herein.
2. The goals and timetables for minority and female participation, expressed in percentage terms for the Contractor's aggregate work force in each trade on all construction work in the covered area, are as follows:

GOALS FOR MINORITY PARTICIPATION IN EACH TRADE	GOALS FOR FEMALE PARTICIPATION IN EACH TRADE
9.6%	6.9%

These goals are applicable to all the Contractor's construction work (whether or not it is Federal or federally-assisted) performed in the covered area. If the contractor performs construction work in a geographical area located outside of the covered area, it shall apply the goals established for such geographical area where the work is actually performed. With regard to this second area, the contractor also is subject to the goals for both its federally involved and non-federally involved construction.

The Contractor's compliance with the Executive Order and the regulations in CFR Part 60-4 shall be based on its implementation of the Equal Opportunity Clause, specific affirmative action obligations required by the specifications set forth in 41 CFR 60-4, 3(a), and its efforts to meet the goals. The hours of minority and female employment and training must be substantially uniform throughout the length of the contract, and in each trade, and the contractor shall make a good faith effort to employ minorities and women evenly on each of its projects. The transfer of minority or female employees or trainees from Contractor to Contractor or from project to project for the sole purpose of meeting the Contractor's goals shall be a violation of the contract, the Executive Order and the regulations in 41 CFR Part 60-4. Compliance with the goals will be measured against the total work hours performed.

3. The Contractor shall provide written notification to the Director of the Office of Federal Contract Compliance Programs within ten (10) working days of award of any construction subcontract in excess of \$10,000.00 at any tier for construction work under the contract resulting from this solicitation. The notification shall list the name, address and telephone number of the subcontractor; employer identification number of the subcontractor; estimated dollar amount of the subcontract; estimated starting and completion dates of the subcontract; and the geographical area in which the subcontract is to be performed. The notification shall be mailed to:

**Evelyn Teague, Regional Director
Office of Federal Contract Compliance Programs
61 Forsyth Street, SW, Suite 7B75
Atlanta, Georgia 30303-8609**

4. As used in this Notice, and in the contract resulting from this solicitation, the "**covered area**" is Hardin County.

PART IV
INSURANCE

Refer to
Kentucky Standard Specifications for Road and Bridge Construction,
current edition

PART V
BID ITEMS

PROPOSAL BID ITEMS

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Section: 0001 - PAVING

LINE	BID CODE	ALT	DESCRIPTION	QUANTITY	UNIT	UNIT PRIC	FP	AMOUNT
0010	00003		CRUSHED STONE BASE	4,911.00	TON		\$	
0020	00100		ASPHALT SEAL AGGREGATE	45.10	TON		\$	
0030	00103		ASPHALT SEAL COAT	5.40	TON		\$	
0040	00190		LEVELING & WEDGING PG64-22	6.00	TON		\$	
0050	00214		CL3 ASPH BASE 1.00D PG64-22	6,086.00	TON		\$	
0060	00216		CL3 ASPH BASE 1.00D PG76-22	2,002.00	TON		\$	
0070	00336		CL3 ASPH SURF 0.38A PG76-22	1,000.00	TON		\$	
0080	02101		CEM CONC ENT PAVEMENT-8 IN	140.00	SQYD		\$	
0090	24970EC		ASPHALT MATERIAL FOR TACK NON-TRACKING	11.80	TON		\$	

Section: 0002 - ROADWAY

LINE	BID CODE	ALT	DESCRIPTION	QUANTITY	UNIT	UNIT PRIC	FP	AMOUNT
0100	00078		CRUSHED AGGREGATE SIZE NO 2	43.00	TON		\$	
0110	01000		PERFORATED PIPE-4 IN	935.00	LF		\$	
0120	01010		NON-PERFORATED PIPE-4 IN	18.00	LF		\$	
0130	01314		PLUG PIPE	1.00	EACH		\$	
0140	01811		STANDARD CURB AND GUTTER MOD	41.00	LF		\$	
0150	01885		LIP HEADER CURB	90.00	LF		\$	
0160	01904		REMOVE CURB	2,249.00	LF		\$	
0170	01917		STANDARD BARRIER MEDIAN TYPE 2	1,534.00	SQYD		\$	
0180	01921		STANDARD BARRIER MEDIAN TYPE 4	958.00	SQYD		\$	
0190	02159		TEMP DITCH	2,724.00	LF		\$	
0200	02160		CLEAN TEMP DITCH	1,363.00	LF		\$	
0210	02200		ROADWAY EXCAVATION	8,539.00	CUYD		\$	
0220	02242		WATER	98.00	MGAL		\$	
0230	02403		REMOVE CONCRETE MASONRY REMOVAL OF CONCRETE FLUME IN MEDIAN	1.70	CUYD		\$	
0240	02429		RIGHT-OF-WAY MONUMENT TYPE 1	4.00	EACH		\$	
0250	02432		WITNESS POST	4.00	EACH		\$	
0260	02483		CHANNEL LINING CLASS II	180.00	TON		\$	
0270	02545		CLEARING AND GRUBBING US-31W @ BLACKJACK	1.00	LS		\$	
0280	02545		CLEARING AND GRUBBING US-31W @ KY-220	1.00	LS		\$	
0290	02545		CLEARING AND GRUBBING US-31W @ KY-434	1.00	LS		\$	
0300	02562		TEMPORARY SIGNS	639.00	SQFT		\$	
0310	02585		EDGE KEY	167.00	LF		\$	
0320	02650		MAINTAIN & CONTROL TRAFFIC US-31W @ BLACKJACK	1.00	LS		\$	
0330	02650		MAINTAIN & CONTROL TRAFFIC US-31W @ KY-220	1.00	LS		\$	
0340	02650		MAINTAIN & CONTROL TRAFFIC US-31W @ KY-434	1.00	LS		\$	
0350	02671		PORTABLE CHANGEABLE MESSAGE SIGN	6.00	EACH		\$	

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LINE	BID CODE	ALT	DESCRIPTION	QUANTITY	UNIT	UNIT PRIC	FP	AMOUNT
0360	02676		MOBILIZATION FOR MILL & TEXT US-31W @ BLACKJACK	1.00	LS		\$	
0370	02676		MOBILIZATION FOR MILL & TEXT US-31W @ KY-220	1.00	LS		\$	
0380	02676		MOBILIZATION FOR MILL & TEXT US-31W @ KY-434	1.00	LS		\$	
0390	02677		ASPHALT PAVE MILLING & TEXTURING	79.00	TON		\$	
0400	02697		EDGELINE RUMBLE STRIPS	150.00	LF		\$	
0410	02701		TEMP SILT FENCE	2,724.00	LF		\$	
0420	02703		SILT TRAP TYPE A	3.00	EACH		\$	
0430	02704		SILT TRAP TYPE B	13.00	EACH		\$	
0440	02705		SILT TRAP TYPE C	35.00	EACH		\$	
0450	02706		CLEAN SILT TRAP TYPE A	3.00	EACH		\$	
0460	02707		CLEAN SILT TRAP TYPE B	13.00	EACH		\$	
0470	02708		CLEAN SILT TRAP TYPE C	35.00	EACH		\$	
0480	02720		SIDEWALK-4 IN CONCRETE	21.00	SQYD		\$	
0490	02726		STAKING US-31W @ BLACKJACK	1.00	LS		\$	
0500	02726		STAKING US-31W @ KY-220	1.00	LS		\$	
0510	02726		STAKING US-31W @ KY-434	1.00	LS		\$	
0520	02775		ARROW PANEL	6.00	EACH		\$	
0530	03290		SIDEWALK RAMP TYPE 4	1.00	EACH		\$	
0540	05950		EROSION CONTROL BLANKET	3,079.00	SQYD		\$	
0550	05952		TEMP MULCH	13,665.00	SQYD		\$	
0560	05953		TEMP SEEDING AND PROTECTION	10,249.00	SQYD		\$	
0570	05963		INITIAL FERTILIZER	.72	TON		\$	
0580	05964		MAINTENANCE FERTILIZER	1.20	TON		\$	
0590	05985		SEEDING AND PROTECTION	20,214.00	SQYD		\$	
0600	05989		SPECIAL SEEDING CROWN VETCH	957.00	SQYD		\$	
0610	05992		AGRICULTURAL LIMESTONE	14.46	TON		\$	
0620	06530		PAVE STRIPING REMOVAL-4 IN	5,083.00	LF		\$	
0630	06568		PAVE MARKING-THERMO STOP BAR-24IN	89.00	LF		\$	
0640	06569		PAVE MARKING-THERMO CROSS-HATCH	433.00	SQFT		\$	
0650	06574		PAVE MARKING-THERMO CURV ARROW	53.00	EACH		\$	
0660	06576		PAVE MARKING-THERMO ONLY	1.00	EACH		\$	
0670	06598		PAVEMENT MARKING REMOVAL	759.00	SQFT		\$	
0680	10020NS		FUEL ADJUSTMENT	14,146.00	DOLL	\$1.00	\$	\$14,146.00
0690	10030NS		ASPHALT ADJUSTMENT	35,530.00	DOLL	\$1.00	\$	\$35,530.00
0700	20550ND		SAWCUT PAVEMENT	5,952.00	LF		\$	
0710	21289ED		LONGITUDINAL EDGE KEY	8,033.00	LF		\$	
0720	22861EN		HIGH STRENGTH GEOTEXTILE FABRIC TY V	354.00	SQYD		\$	
0730	23158ES505		DETECTABLE WARNINGS	20.00	SQFT		\$	
0740	23274EN11F		TURF REINFORCEMENT MAT 1	690.00	SQYD		\$	
0750	24489EC		INLAID PAVEMENT MARKER	158.00	EACH		\$	
0760	24679ED		PAVE MARK THERMO CHEVRON	547.00	SQFT		\$	
0770	24814EC		PIPELINE INSPECTION	2,581.00	LF		\$	
0780	24955ED		REMOVE SIGNAL EQUIPMENT	4.00	EACH		\$	
0790	24995EC		PAVE STRIPING-SPRAY THERMO-6 IN W	7,574.00	LF		\$	
0800	24996EC		PAVE STRIPING-SPRAY THERMO-6 IN Y	8,356.00	LF		\$	

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Section: 0003 - DRAINAGE

LINE	BID CODE	ALT	DESCRIPTION	QUANTITY	UNIT	UNIT PRIC	FP	AMOUNT
0810	00440		ENTRANCE PIPE-15 IN	71.00	LF		\$	
0820	00461		CULVERT PIPE-15 IN	390.00	LF		\$	
0830	00462		CULVERT PIPE-18 IN	286.00	LF		\$	
0840	00521		STORM SEWER PIPE-15 IN	1,147.00	LF		\$	
0850	00522		STORM SEWER PIPE-18 IN	736.00	LF		\$	
0860	00524		STORM SEWER PIPE-24 IN	19.00	LF		\$	
0870	01204		PIPE CULVERT HEADWALL-18 IN	1.00	EACH		\$	
0880	01310		REMOVE PIPE	1,120.00	LF		\$	
0890	01432		SLOPED BOX OUTLET TYPE 1-15 IN	9.00	EACH		\$	
0900	01433		SLOPED BOX OUTLET TYPE 1-18 IN	2.00	EACH		\$	
0910	01434		SLOPED BOX OUTLET TYPE 1-24 IN	1.00	EACH		\$	
0920	01456		CURB BOX INLET TYPE A	5.00	EACH		\$	
0930	01487		CURB BOX INLET TYPE F	15.00	EACH		\$	
0940	01511		DROP BOX INLET TYPE 5D	8.00	EACH		\$	
0950	01584		CAP DROP BOX INLET	1.00	EACH		\$	
0960	01585		REMOVE DROP BOX INLET	2.00	EACH		\$	
0970	01650		JUNCTION BOX	1.00	EACH		\$	
0980	01718		REMOVE INLET	4.00	EACH		\$	
0990	02600		FABRIC GEOTEXTILE TY IV FOR PIPE	4,309.00	SQYD	\$2.00	\$	\$8,618.00
1000	02625		REMOVE HEADWALL	4.00	EACH		\$	
1010	02690		SAFELADING	4.30	CUYD		\$	
1020	23822EC		CORED HOLE DRAINAGE BOX CON-15 IN	4.00	EACH		\$	
1030	23952EC		DRAINAGE JUNCTION BOX TY B	1.00	EACH		\$	

Section: 0004 - GUARDRAIL

LINE	BID CODE	ALT	DESCRIPTION	QUANTITY	UNIT	UNIT PRIC	FP	AMOUNT
1040	02351		GUARDRAIL-STEEL W BEAM-S FACE	475.00	LF		\$	
1050	02360		GUARDRAIL TERMINAL SECTION NO 1	1.00	EACH		\$	
1060	02369		GUARDRAIL END TREATMENT TYPE 2A	1.00	EACH		\$	
1070	02381		REMOVE GUARDRAIL	495.00	LF		\$	

Section: 0005 - DEMOBILIZATION

LINE	BID CODE	ALT	DESCRIPTION	QUANTITY	UNIT	UNIT PRIC	FP	AMOUNT
1080	02569		DEMOBILIZATION	1.00	LS		\$	